


Existing Ground Floor Plan

Scale 1:50

GENERAL NOTES:
 1. ALL DIMENSIONS ARE IN MILLIMETER.
 2. VERIFY ALL DIMENSIONS AND CONDITIONS BEFORE BUILDING OR
 STARTING CONSTRUCTION. NOTIFY THE DESIGNER IMMEDIATELY OF ANY
 DISCREPANCY OR VARIATION.
 3. ALL WORK TO COMPLY WITH CURRENT BUILDING REGULATIONS
 AND CODES OF PRACTICE

Title:

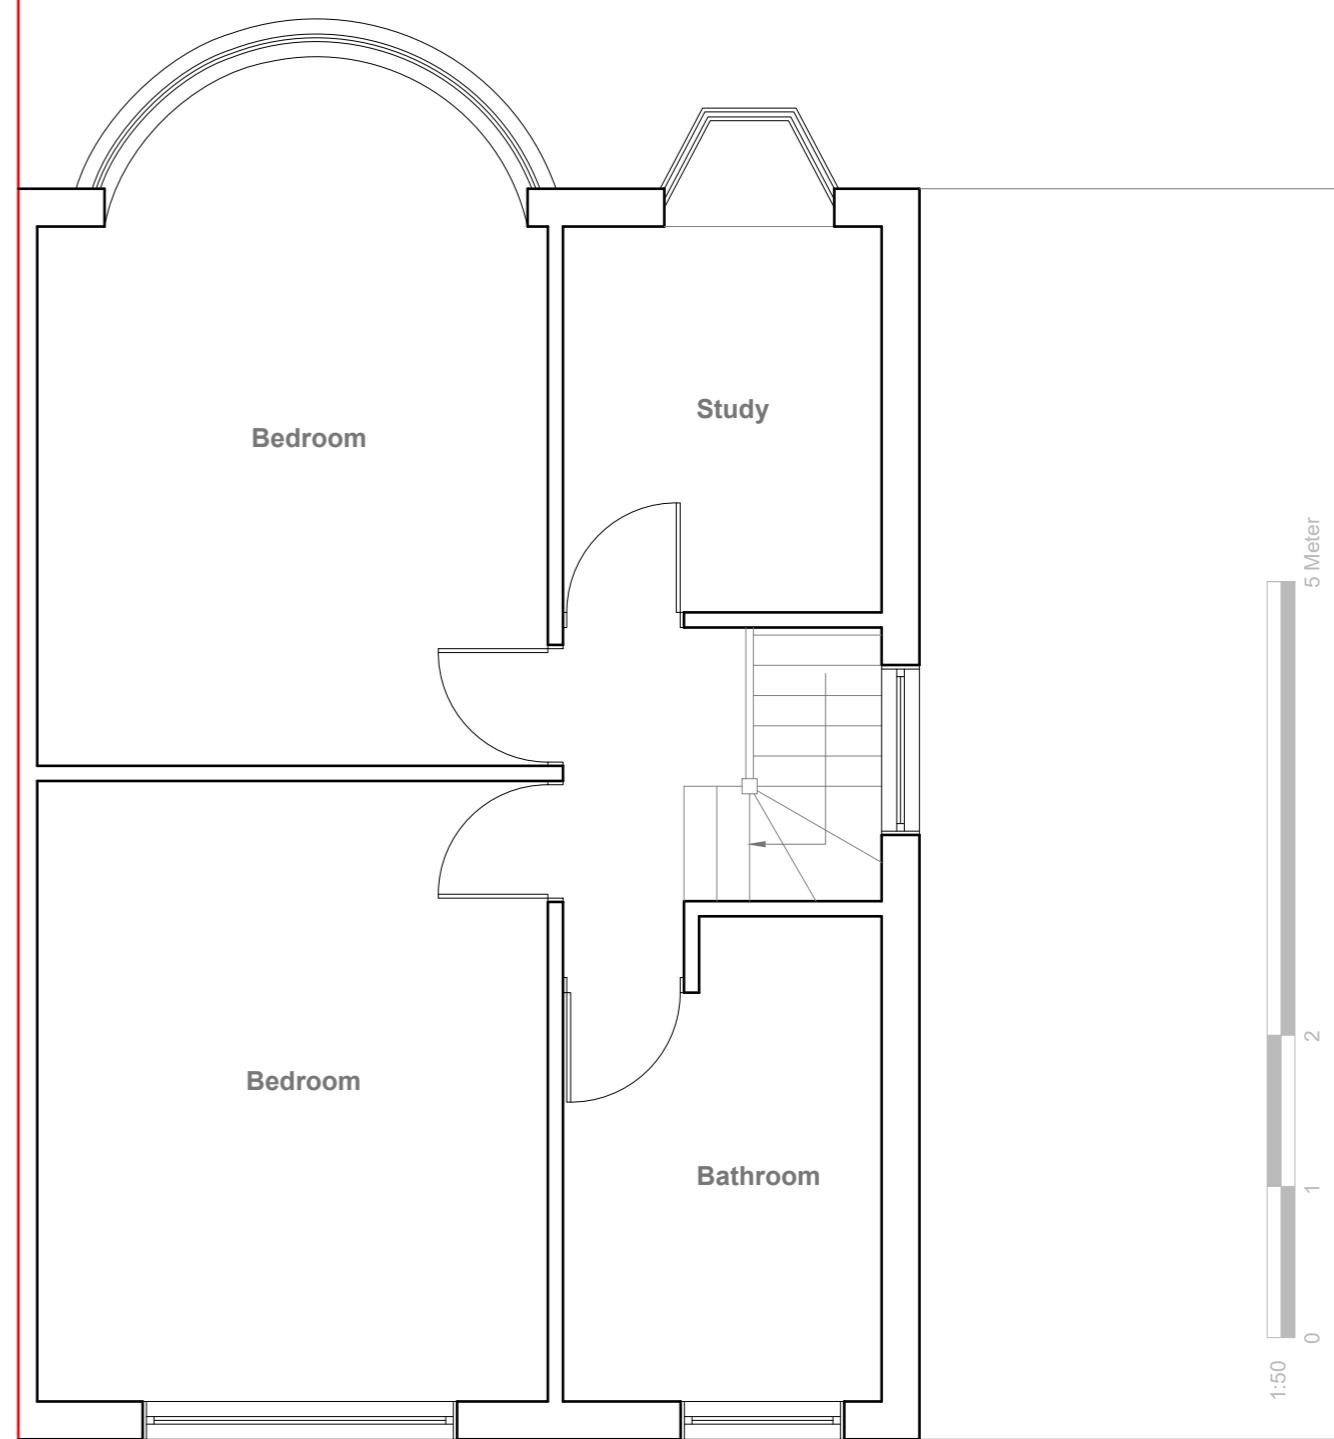

Existing First Floor Plan

Scale 1:50

Existing Floor Plans

Site Address
16 Cornwall Road
Ruislip
Middlesex
HA4 6AL

Scale: 1:50@A3
Date: 19/04/2021
Drawing No.: 2015/133-01PD
Drawn By: DP

Revision Date:

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Existing Front Elevation

Scale 1:100



Existing Side Elevation

Scale 1:100



Existing Rear Elevation

Scale 1:100



Existing Side Elevation

Scale 1:100

GENERAL NOTES:

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Title:

Existing Elevations

Site Address

16 Cornwall Road
Ruislip
Middlesex
HA4 6AL

Scale: 1:100 @A3



Date: 19/04/2021
Drawing No.: 2015/133 -02PD
Drawn By: DP

Revision Date:

e:mail - faluckpatel@yahoo.com
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10 Meter
5
2
1
0
1:100

Faluck Patel

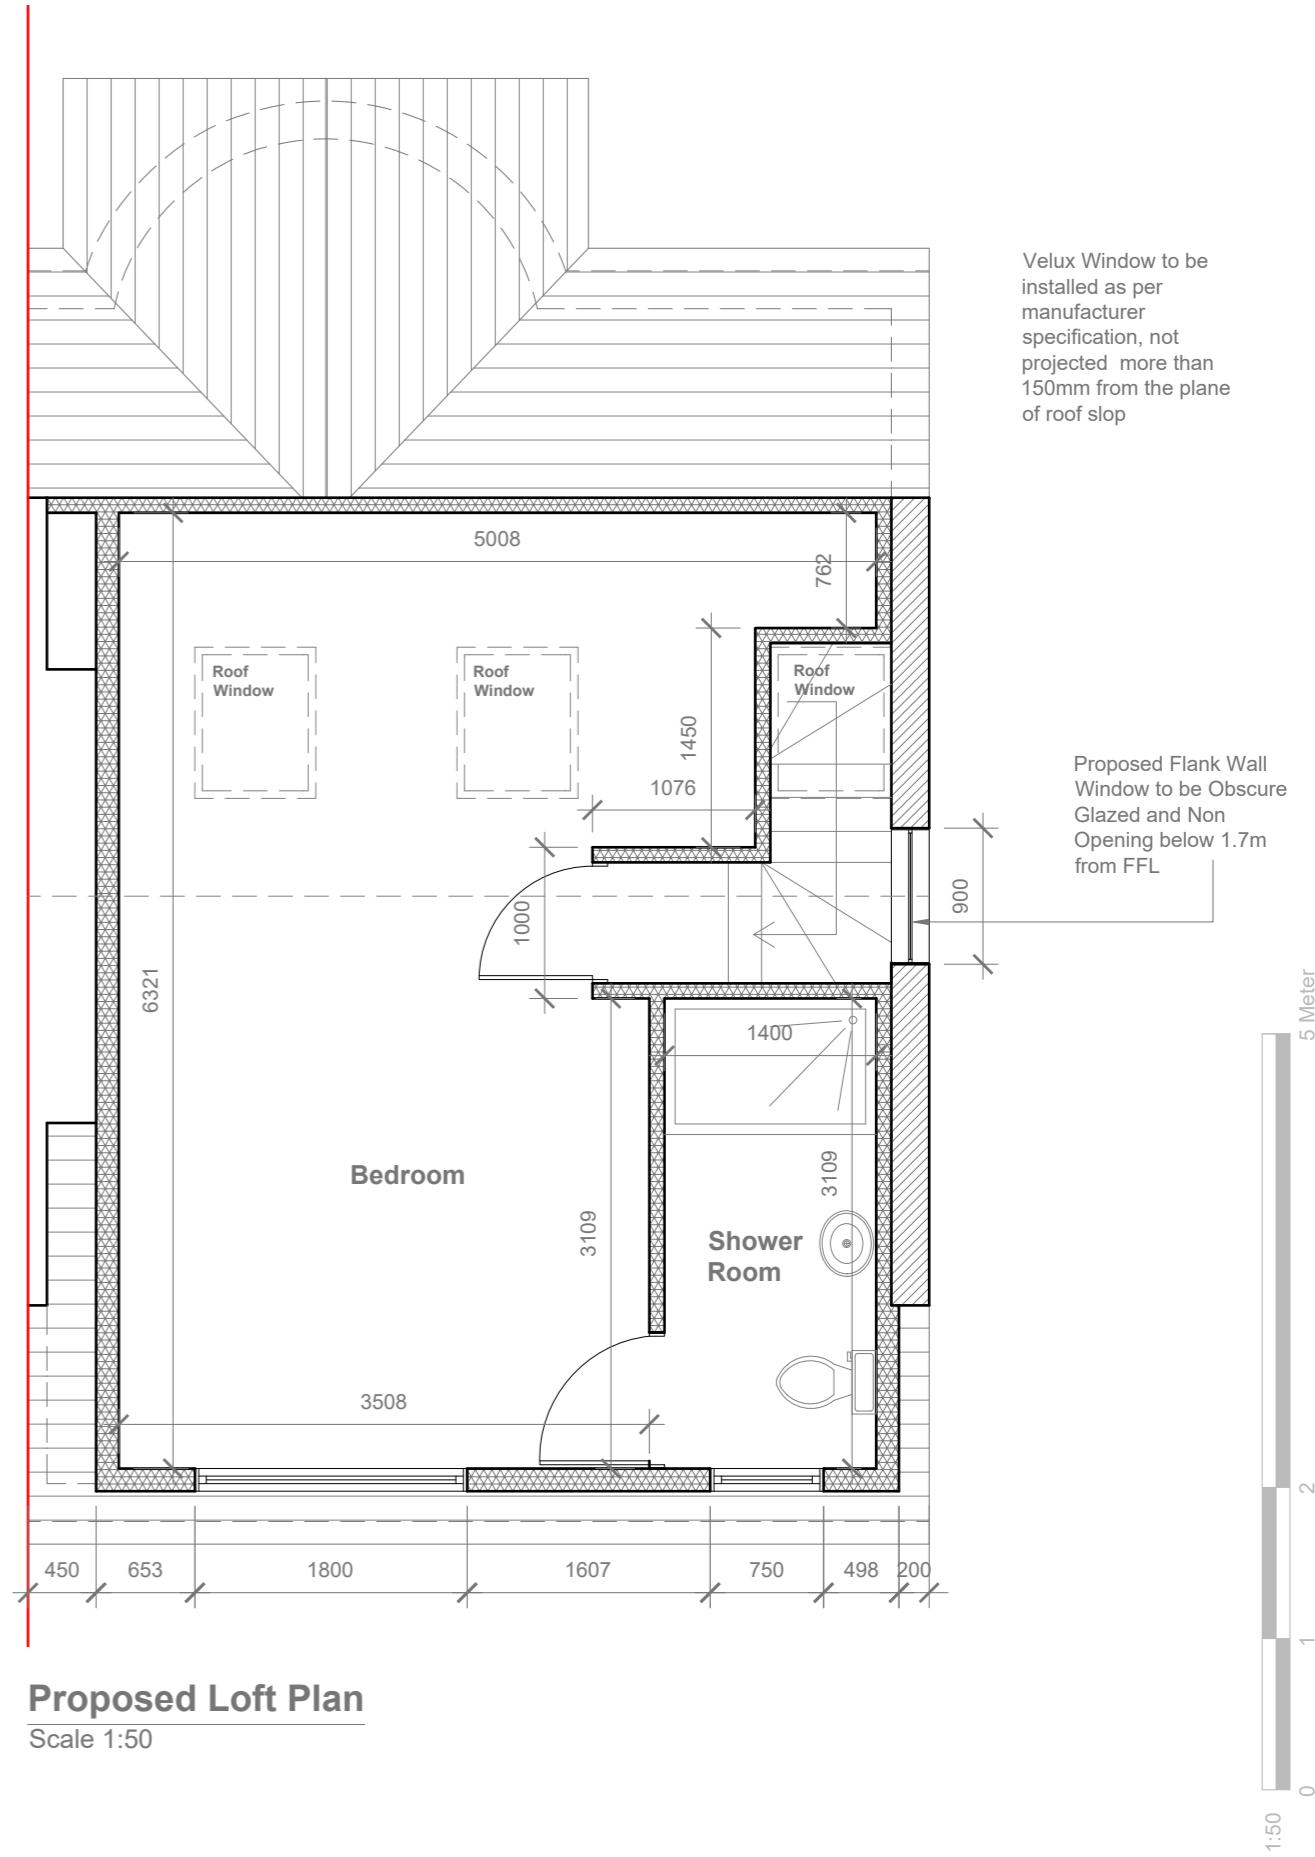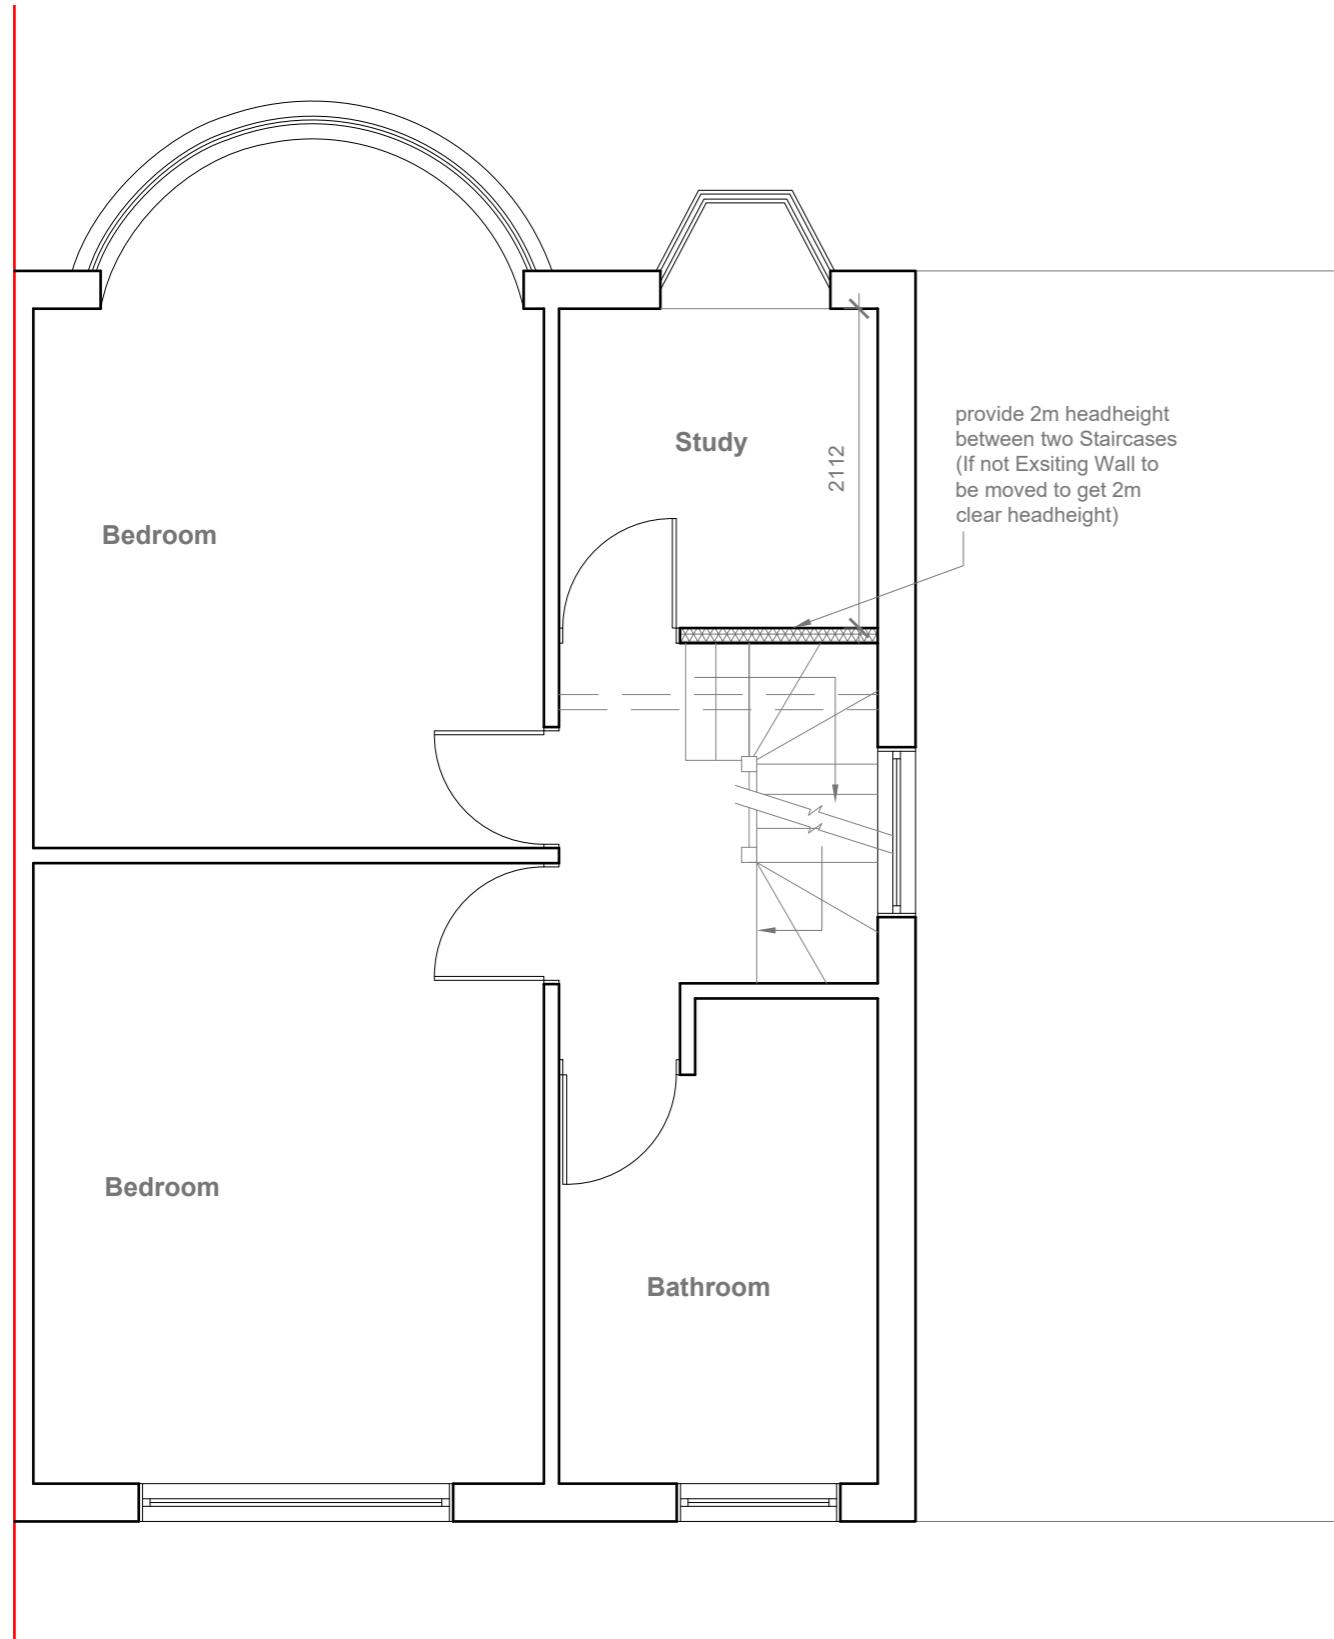

Proposed First Floor & Loft Plan

Velux Window to be installed as per manufacturer specification, not projected more than 150mm from the plane of roof slope



Proposed Front Elevation

Scale 1:100




Proposed Side Elevation

Scale 1:100



Proposed Rear Elevation

Scale 1:100

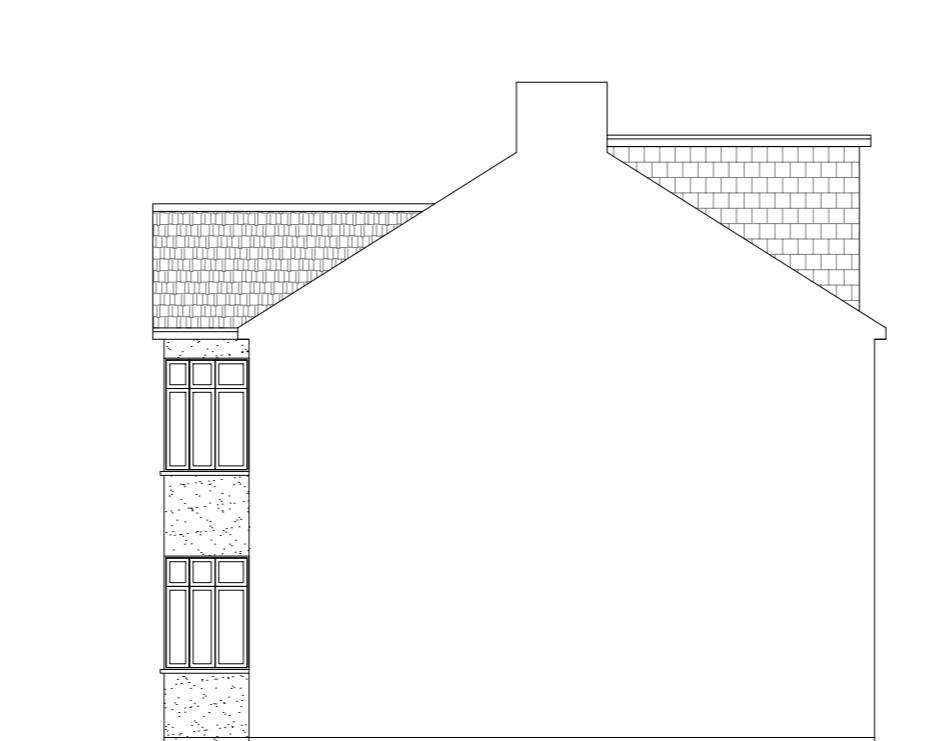

Proposed Side Elevation

Scale 1:100

Proposed External Finish Materials to Match Existing External Finish Materials

REAR DORMER VOLUME = $W \times H \times L / 2$
 $5.308 \times 2.254 \times 3.697 / 2$
 $44.23 / 2$
 22.11 CU.MT.

HIP TO GABLE ROOF VOLUME = $W1 \times H1 \times L1 / 6$
 $8.571 \times 2.850 \times 4.135 / 6$
 $101.00 / 6$
 16.83 CU.MT.

TOTAL ROOF VOLUME = $V1 + V2$
 $22.11 + 16.83$
 $38.94 \text{ CU.MT.} < 40.00 \text{ CU.MT.}$

10 Meter
0 1 2 5

1:100

GENERAL NOTES:
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3. ALL WORK TO COMPLY WITH CURRENT BUILDING REGULATIONS AND CODES OF PRACTICE

Title:

Proposed Elevations

Site Address
16 Cornwall Road
Ruislip
Middlesex
HA4 6AL

Scale: 1:100 @ A3
Date: 19/04/2021
Drawing No.: 2015/133 -04PD
Drawn By:
DP

Revision Date:

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