

Design Workshop

Dimensions to be verified on site
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No responsibility is taken for their accuracy.


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Site Address:

24, Dawley Avenue,
Uxbridge
UB8 3BT

Title:


Block and Location
Plans

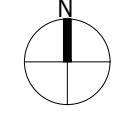

Scale: 1:500, 1:1250

Paper Size: A3

Rev Date Comments

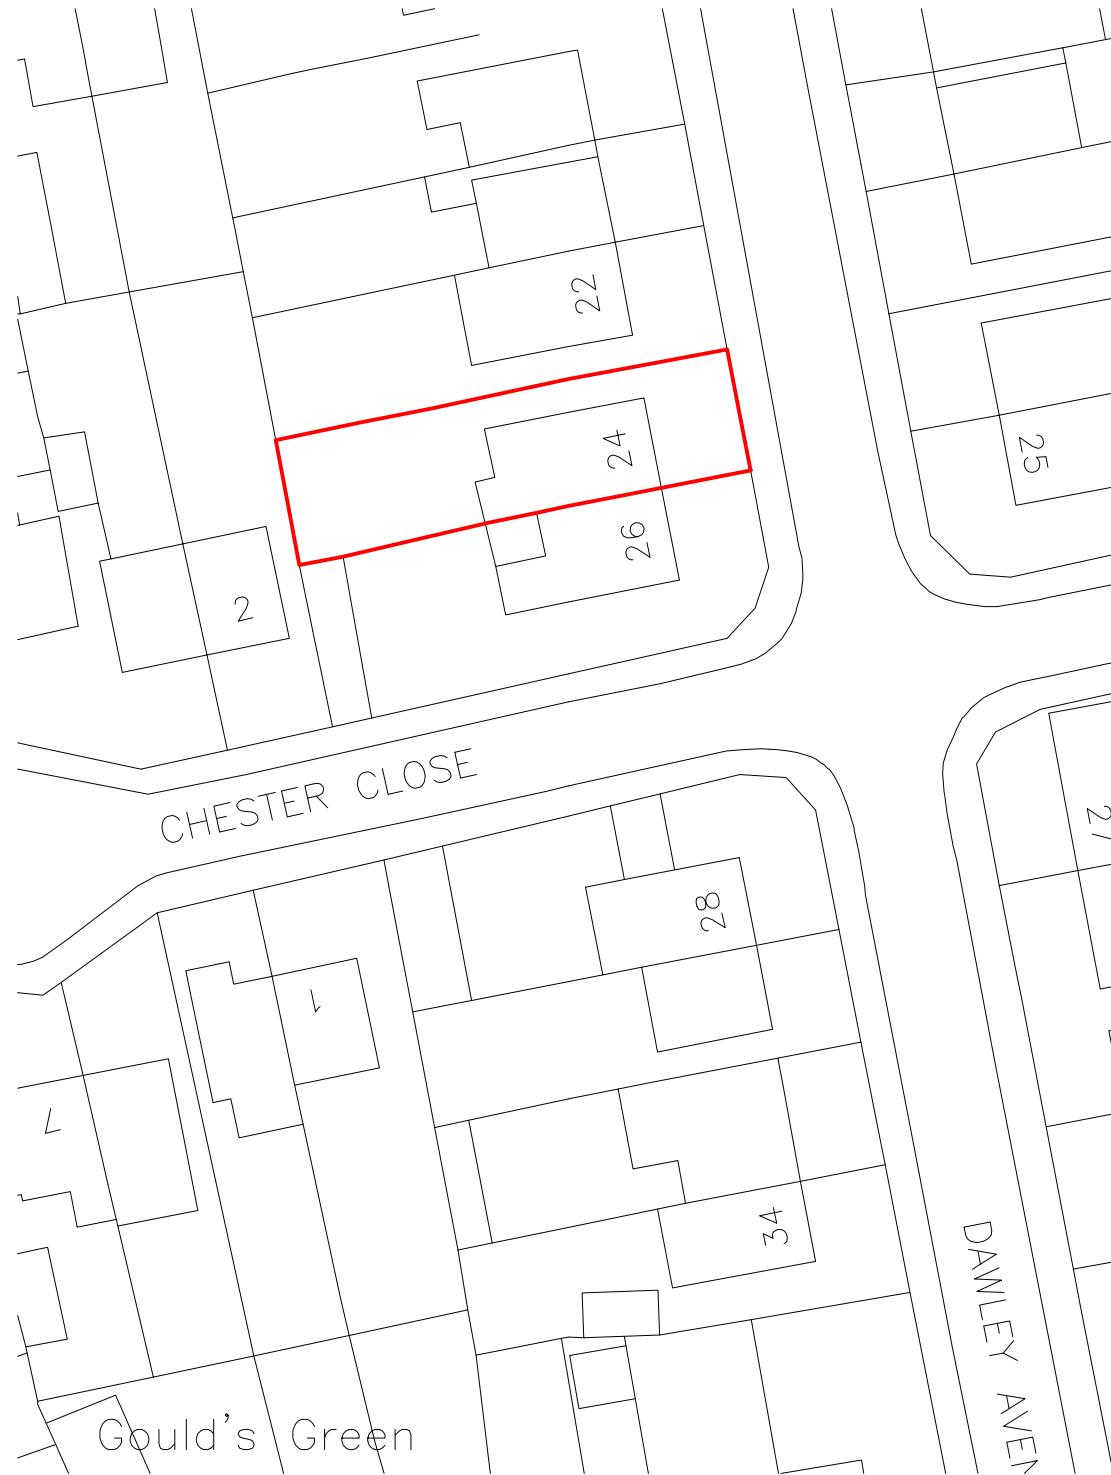

0 5 10 15 20 25

metres 1:500 scale



0 10 20 30 40 50


metres 1:1250 scale

Drawn By: VG

Job Ref: 25076D

Date: June 2025

Drawing No. LW - 01

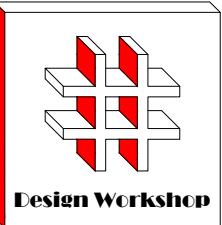

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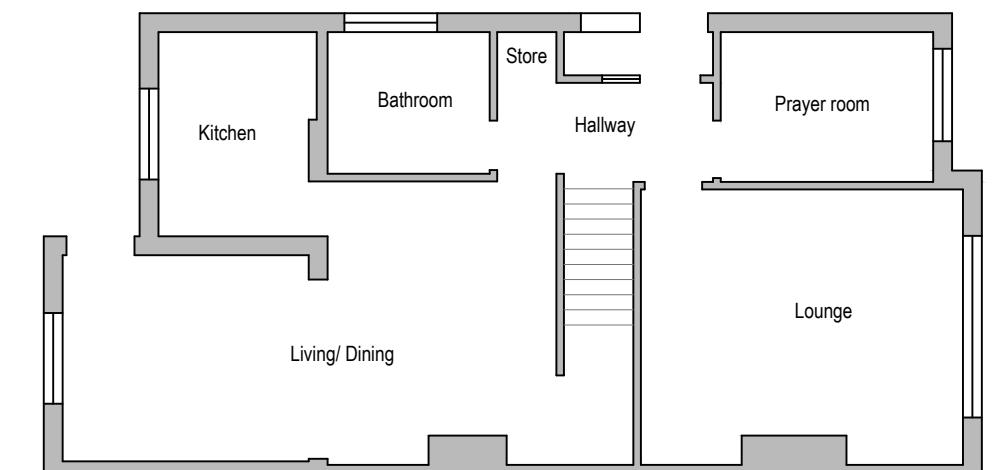
Title:

Existing & Proposed Ground Floor
Plans

Scale: 1:50, 1:100


Paper Size: A3

Rev Date Comments



Existing Ground Floor Plan

0 1 2 3 4 5
metres 1:100 scale

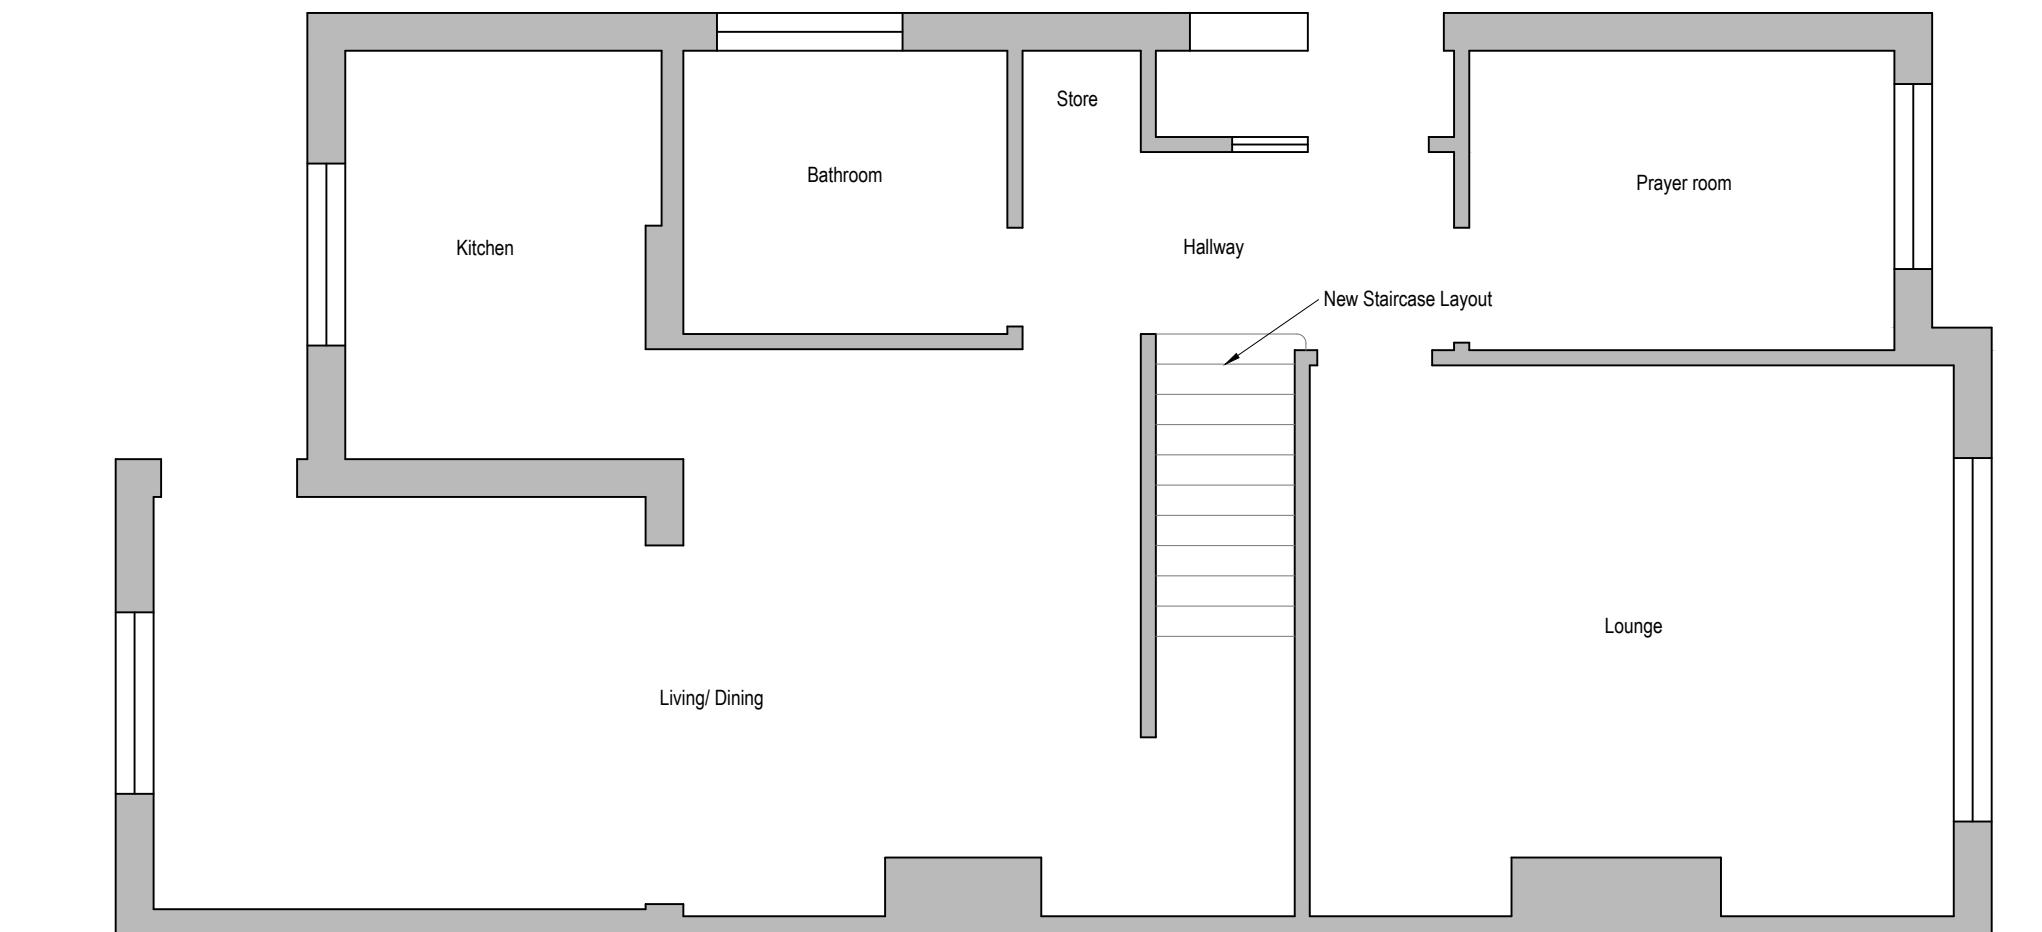

Proposed Ground Floor Plan

0 0.5 1.0 1.5 2.0 2.5
metres 1:50 scale

Drawn By: VG

Job Ref: 25076D

Date: June 2025

Drawing No. LW - 02



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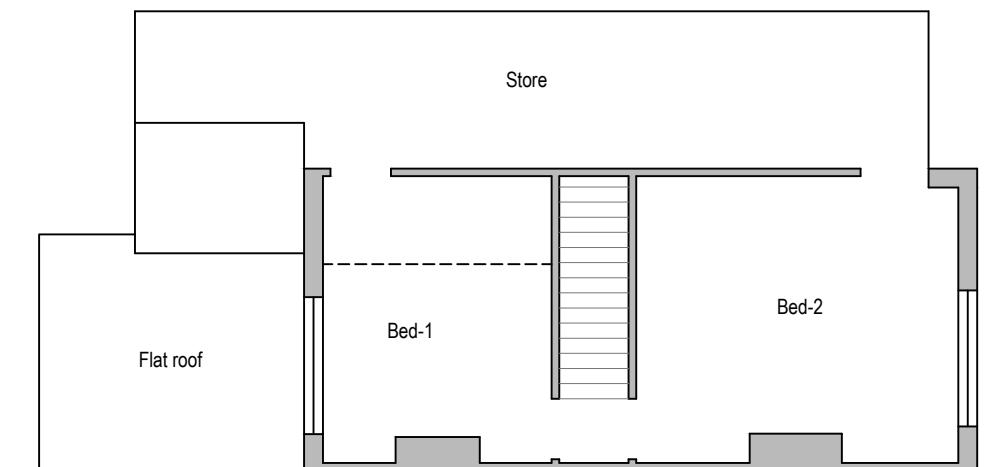
Title:

Existing & Proposed First Floor
Plans


Scale: 1:50, 1:100

Paper Size: A3

Rev	Date	Comments




0 1 2 3 4 5
metres 1:100 scale

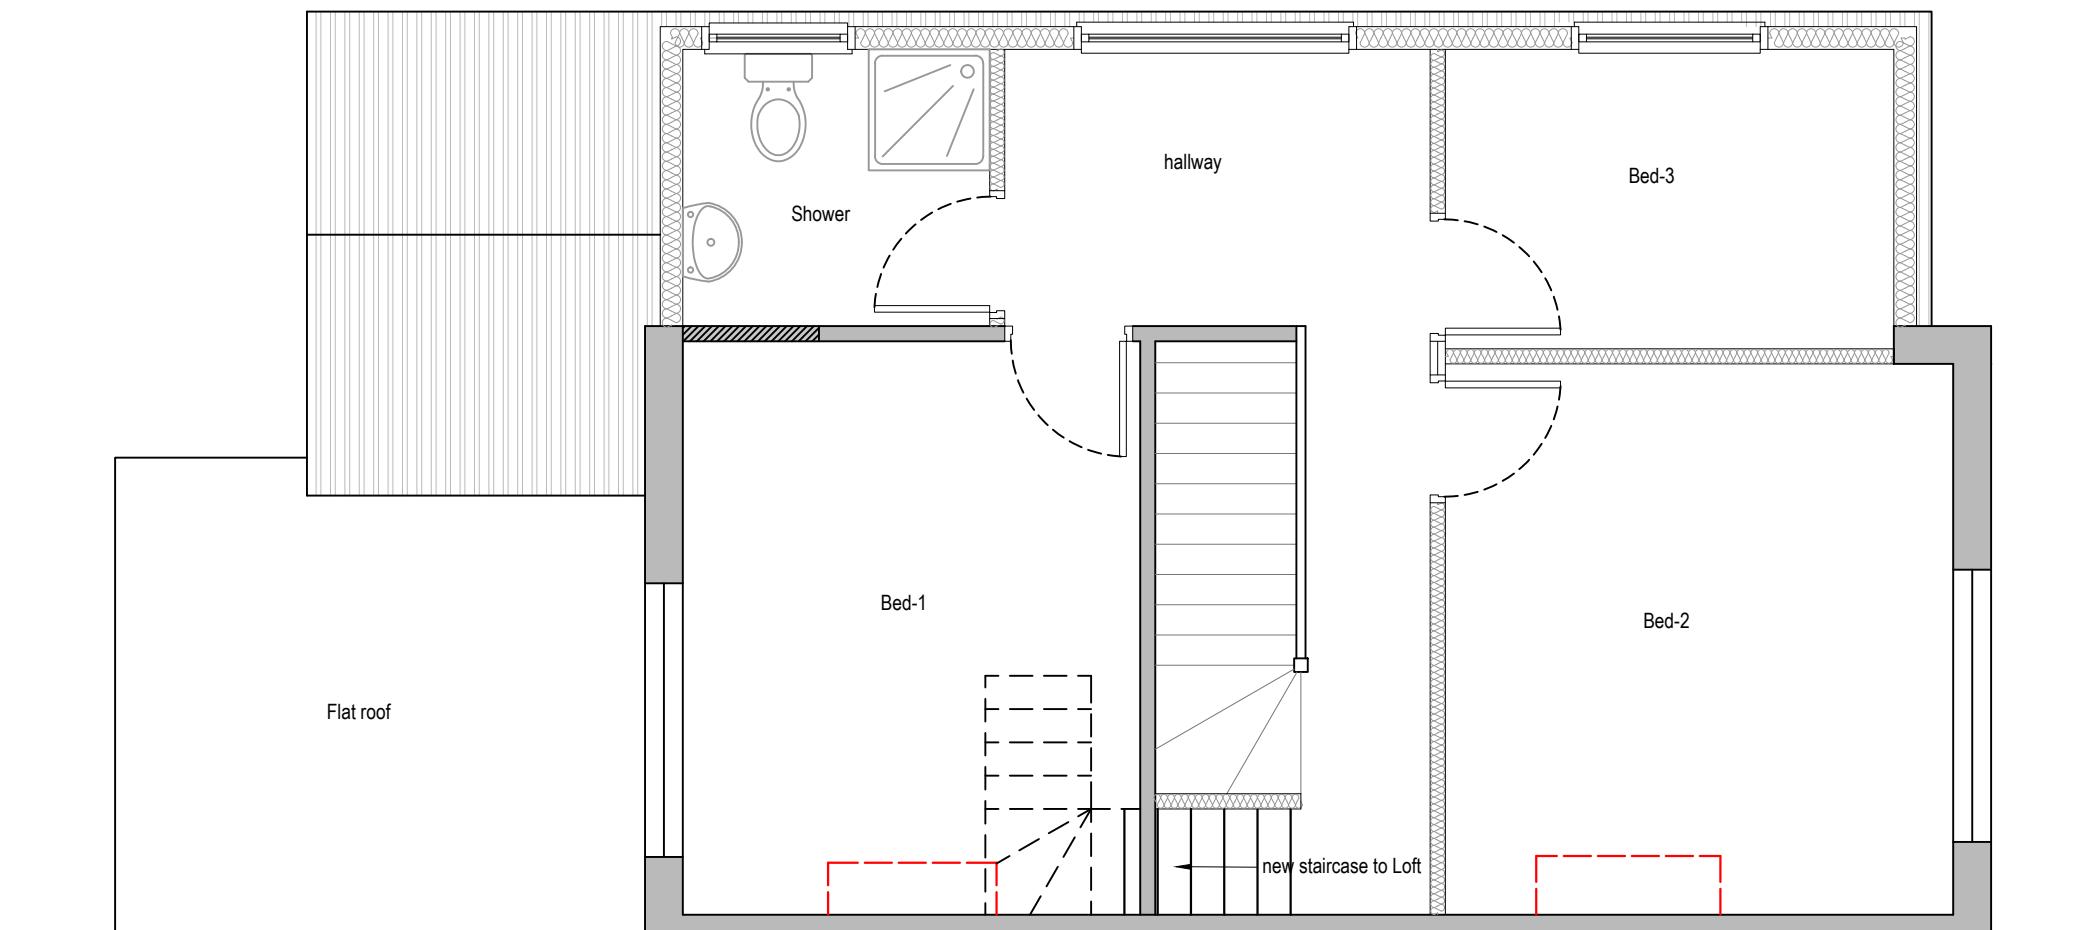

0 0.5 1.0 1.5 2.0 2.5
metres 1:50 scale

Drawn By: VG
Job Ref: 25076D
Date: June 2025
Drawing No. LW - 03

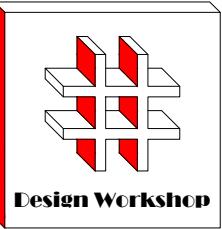

Design Workshop

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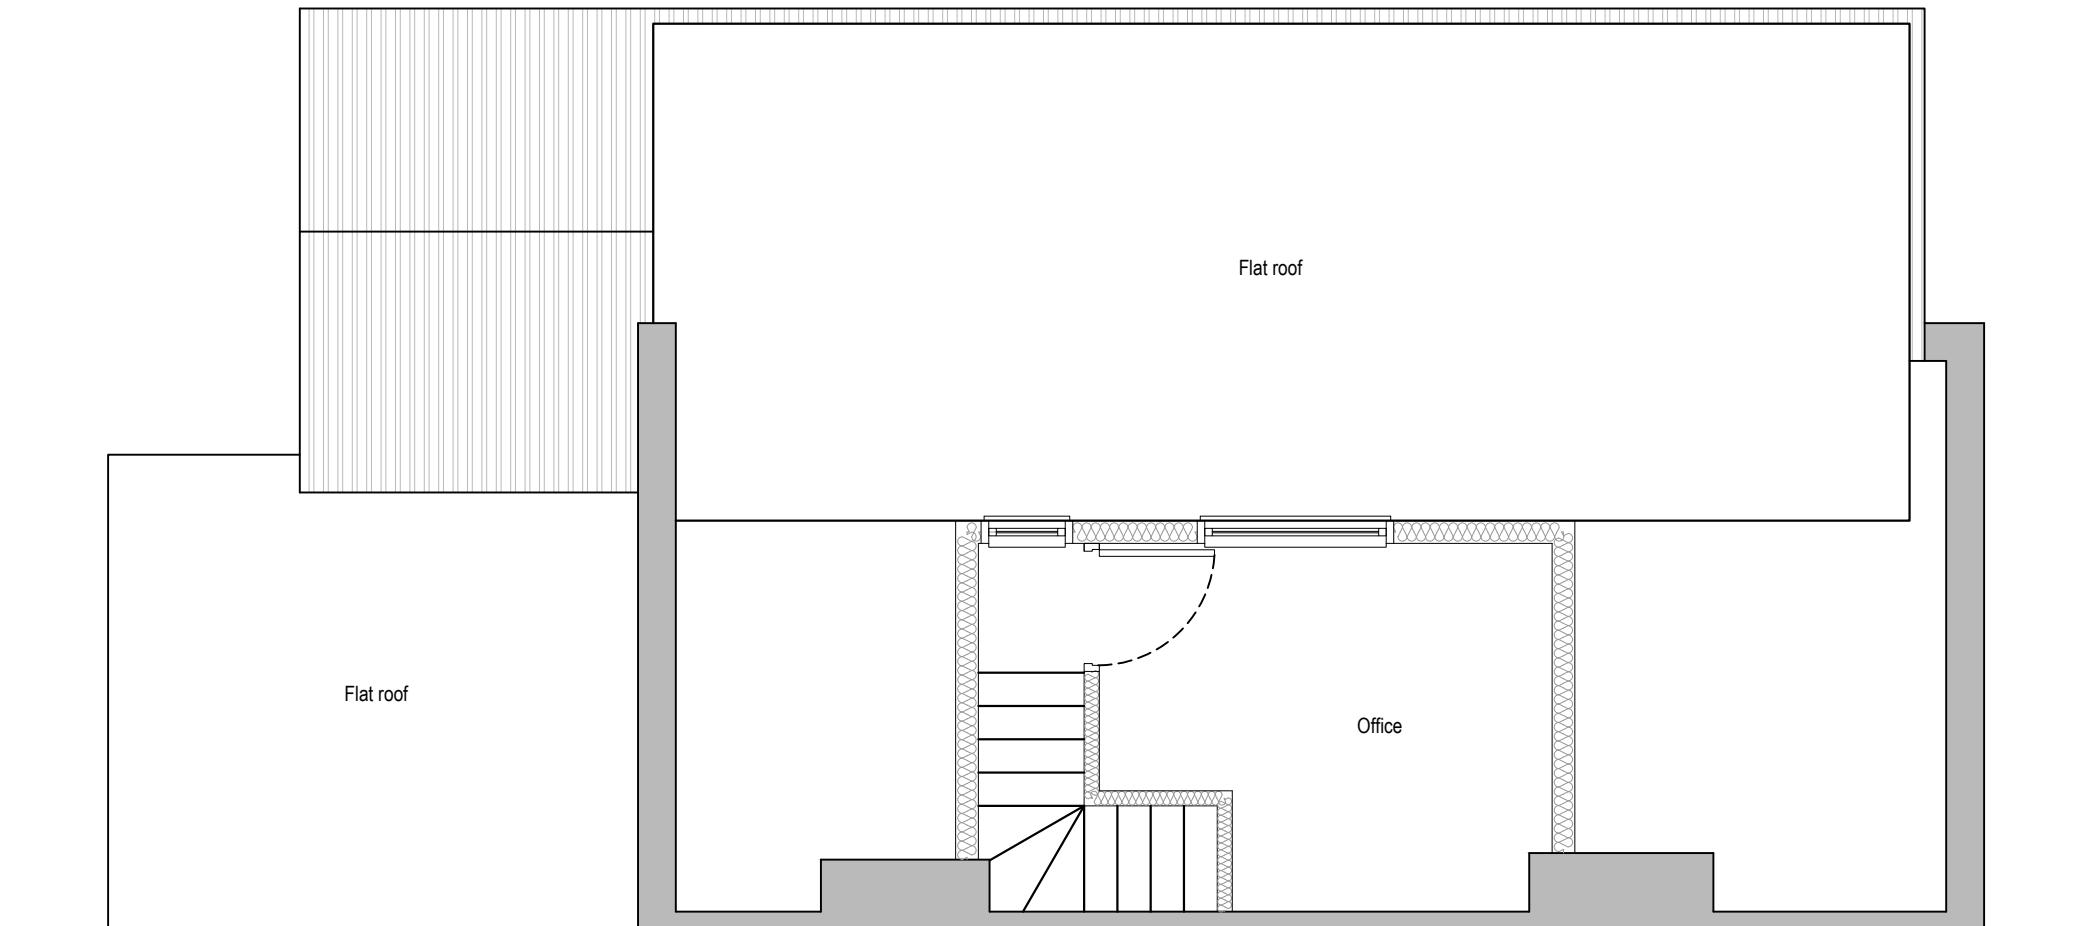
Title:

Proposed Loft Plan

Scale: 1:50

Paper Size: A3


Rev	Date	Comments



Proposed Loft Plan

0 0.5 1.0 1.5 2.0 2.5
metres 1:50 scale

Drawn By:	VG
Job Ref:	25076D
Date:	June 2025
Drawing No.	LW - 04

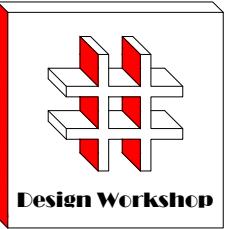

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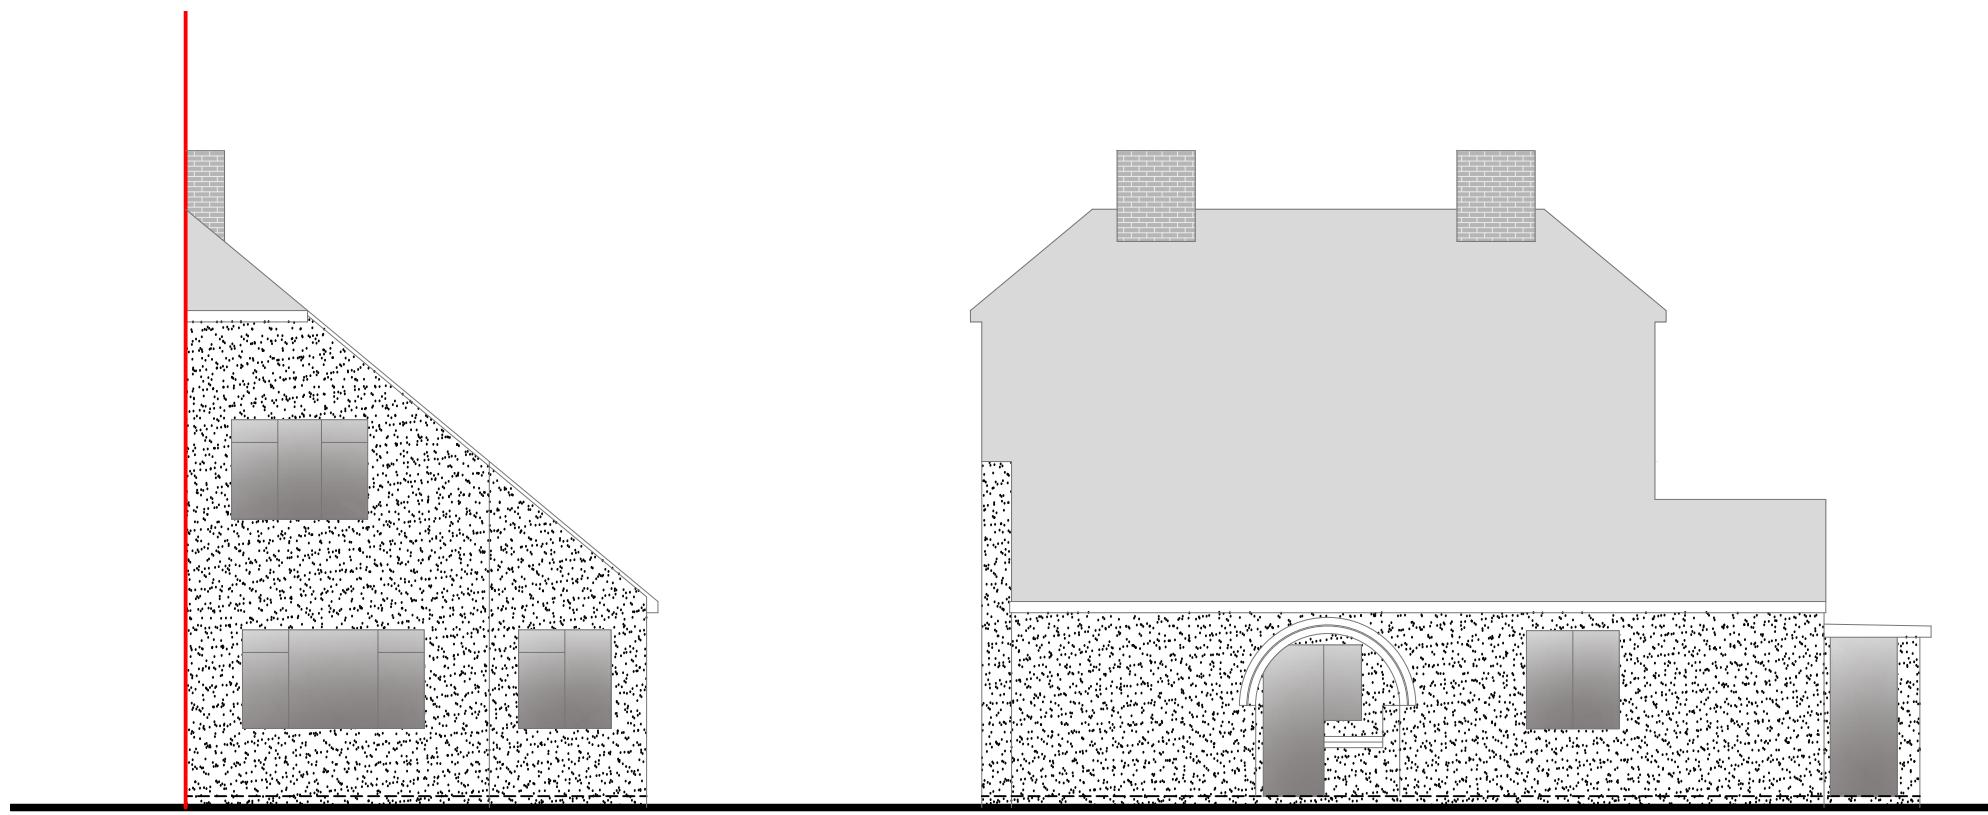
Title:

Existing Elevations

Scale: 1:100

Paper Size: A3

Rev	Date	Comments




Front Elevation

0 1 2 3 4 5
metres 1:100 scale

Side Elevation

0 1 2 3 4 5
metres 1:100 scale

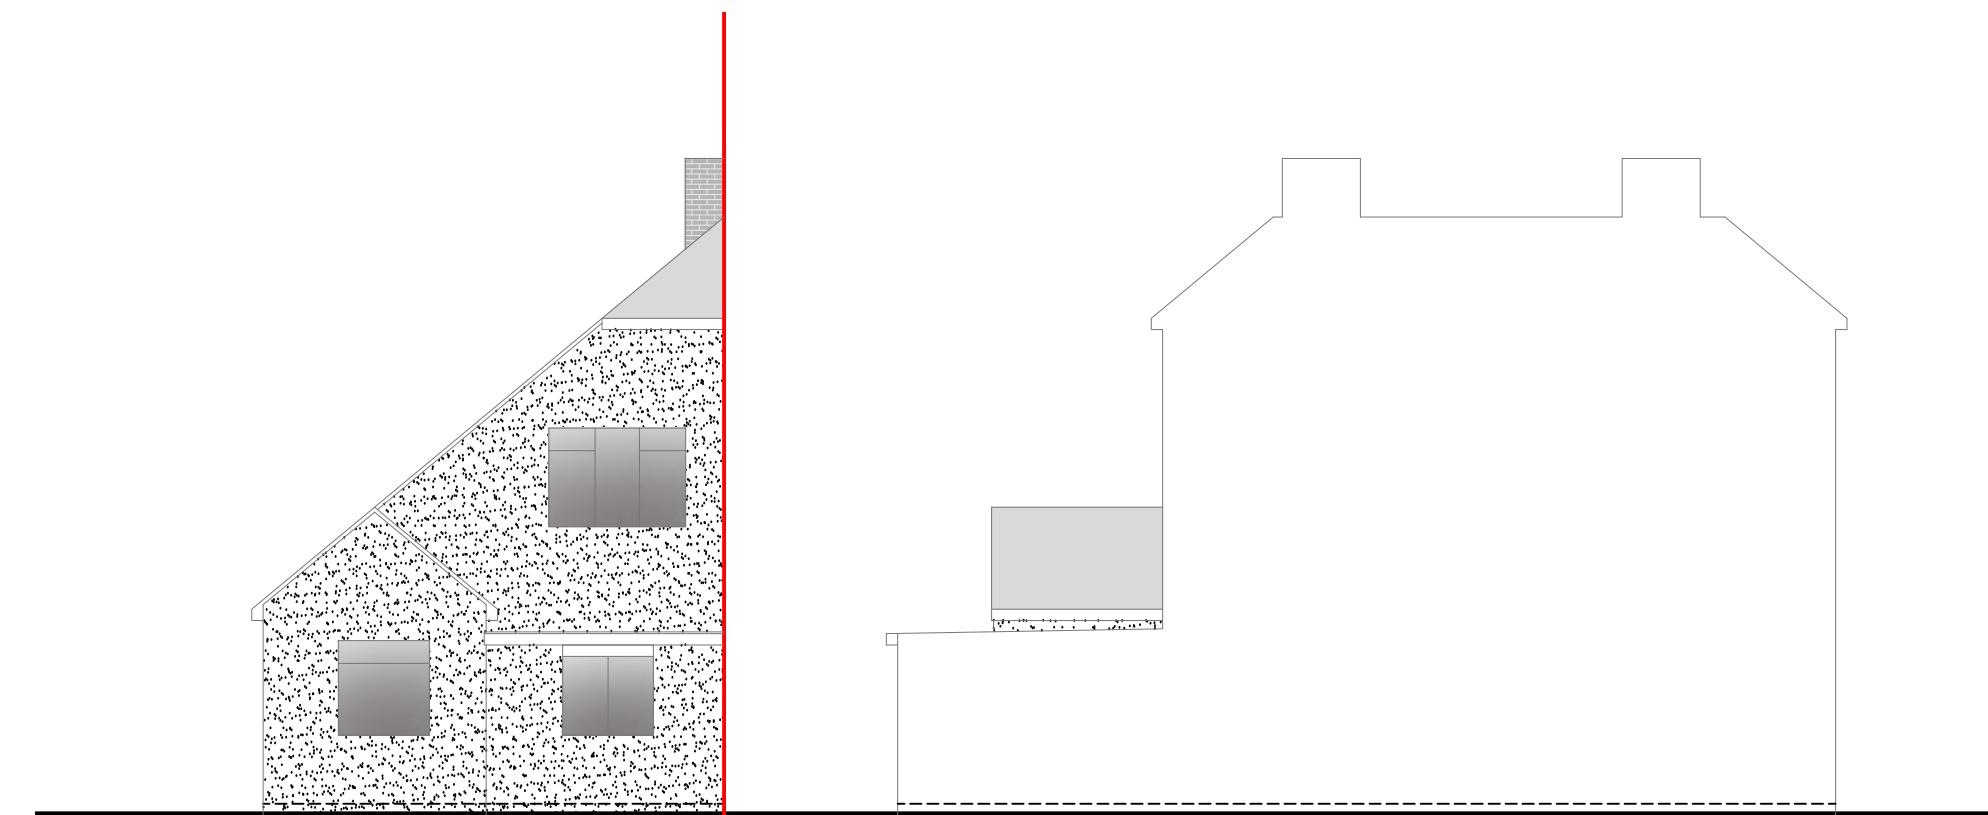

Rear Elevation

0 1 2 3 4 5
metres 1:100 scale

Side Elevation


0 1 2 3 4 5
metres 1:100 scale

Drawn By: VG

Job Ref: 25076D

Date: June 2025

Drawing No. LW - 05

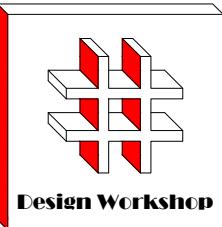

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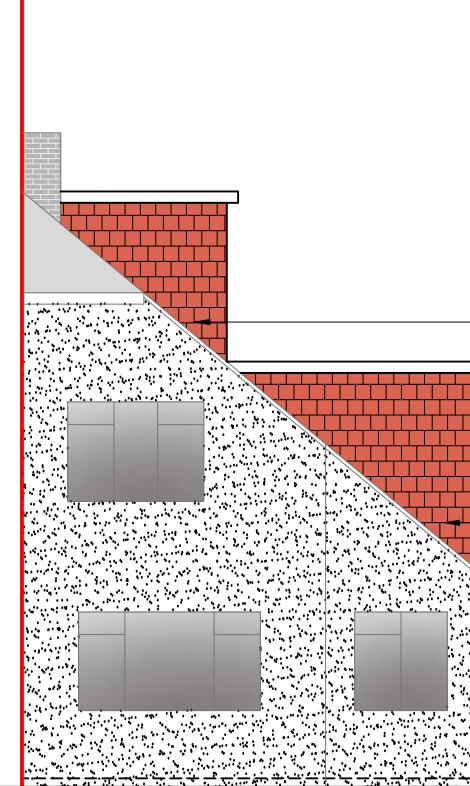
Title:

Proposed Elevations

Scale: 1:100


Paper Size: A3

Rev Date Comments




Front Elevation

0 1 2 3 4 5
metres 1:100 scale

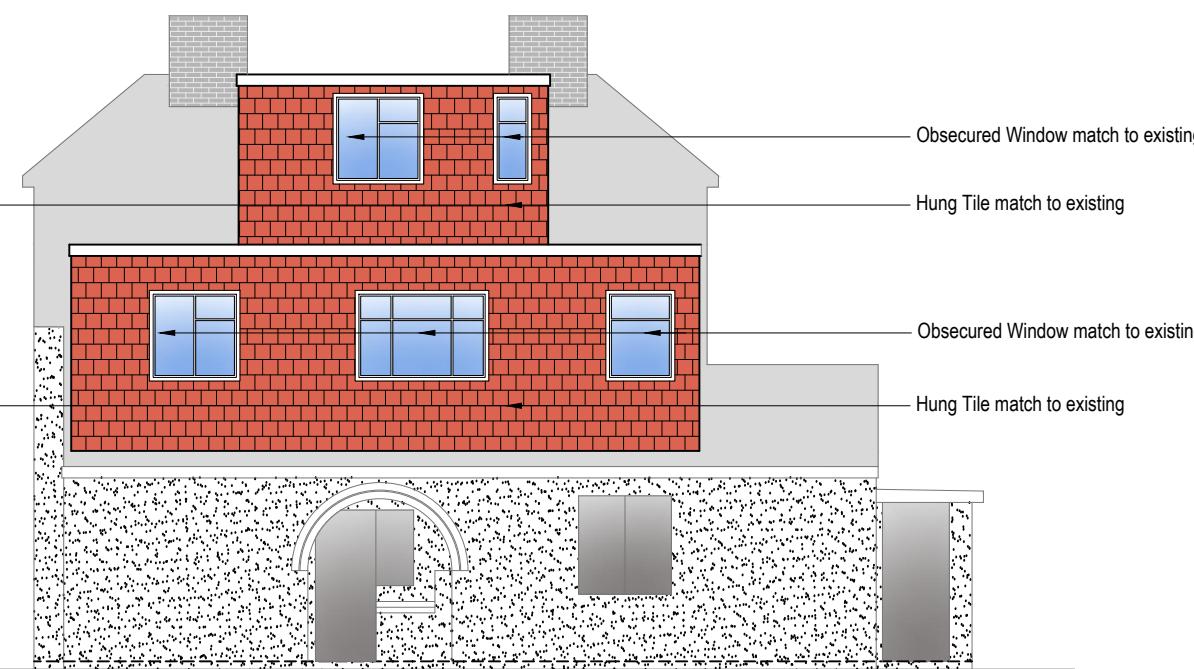

Side Elevation

0 1 2 3 4 5
metres 1:100 scale

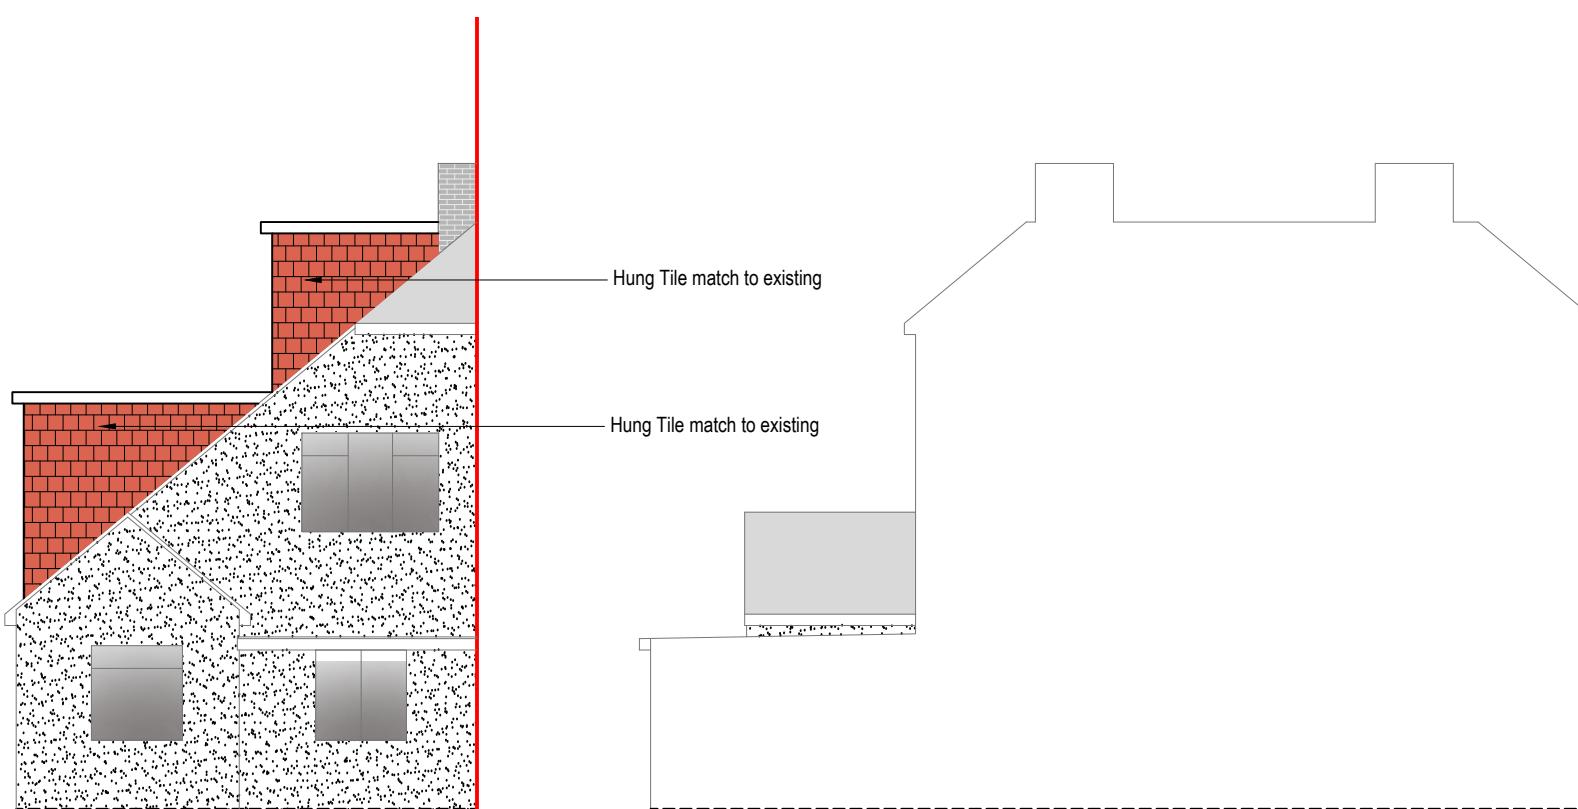

Rear Elevation

0 1 2 3 4 5
metres 1:100 scale

NOTE:

ANY WINDOW INSERTED ON WALL OR ROOF SLOPE
FORMING A SIDE ELEVATION OF THE DWELLING
SHALL BE:


1. OBSECURE P GLAZED
2. NON- OPENING UNLESS THE PARTS OF THE
WINDOW WHICH CAN BE OPENED ARE MORE
THAN 1.7 METERS ABOVE THE FLOOR OF THE
ROOM IN WHICH THE WINDOW IS INSTALLED.
3. ROOF WINDOW WILL NOT PROTRUDE MORE
THAN 150MM

Drawn By: VG

Job Ref: 25076D


Date: June 2025

Drawing No. LW - 06

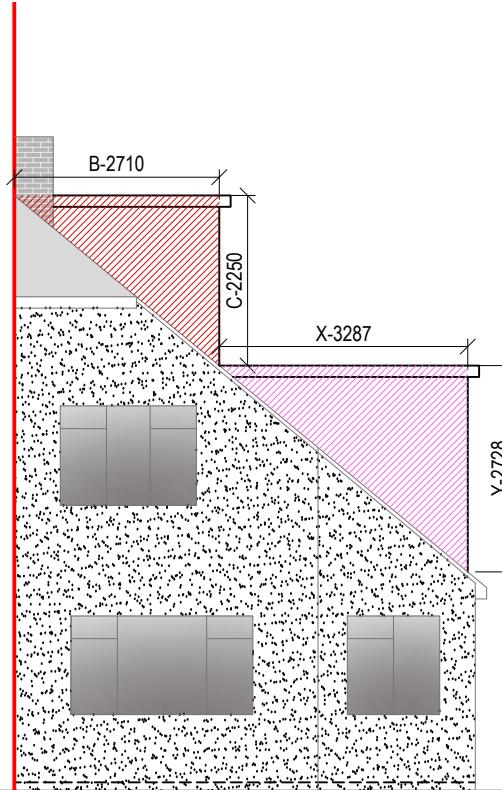


Front Elevation

0 1 2 3 4 5
metres 1:100 scale

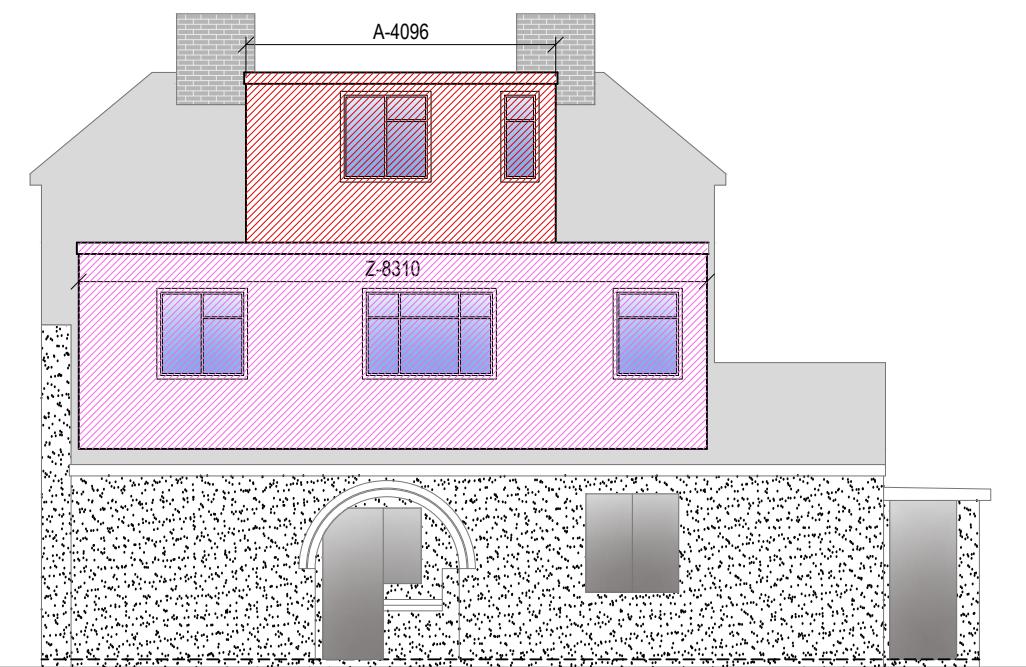


Side Elevation

0 1 2 3 4 5
metres 1:100 scale

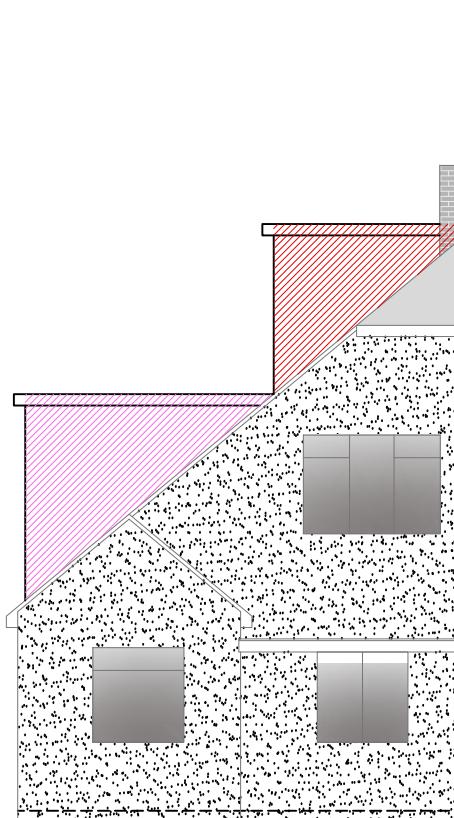

Rear Elevation

0 1 2 3 4 5
metres 1:100 scale

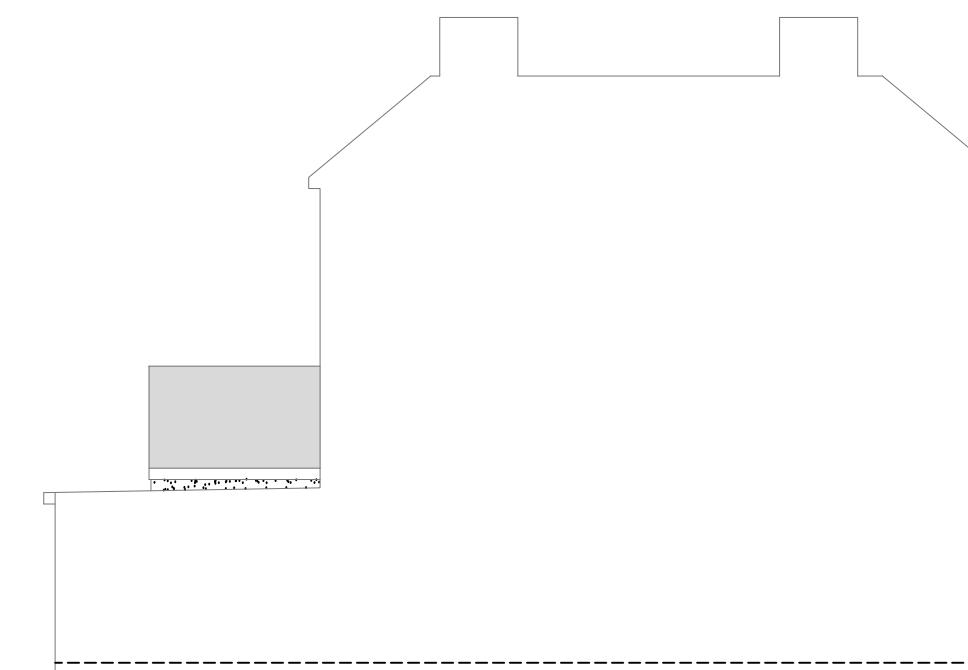

Side Elevation

0 1 2 3 4 5
metres 1:100 scale

NOTE: VOLUME CALCULATION

Site: 24, Dawley Avenue, Uxbridge UB8 3BT

Dormer 1 :




$$X - 3.287 \times Y - 2.728 \times Z - 8.310 \times \frac{1}{2} = 37.25 \text{ m}^3$$

Dormer 2 :



$$A - 4.096 \times B - 2.710 \times C - 2.250 \times \frac{1}{2} = 12.48 \text{ m}^3$$

$$\text{TOTAL VOLUME: } 37.25 + 12.48 = 49.73 \text{ M3}$$

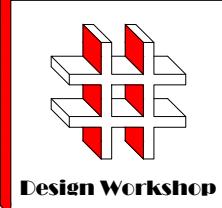

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Title:

Proposed Elevations

Scale: 1:100

Paper Size: A3

Rev Date Comments

Drawn By: VG

Job Ref: 25076D

Date: June 2025

Drawing No. LW - 07