



01  
**01 PROP ELEV FRONT**  
Scale: 1:100

JULIET BALCONY -Balcony glass to be 21.5mm laminated toughened  
Railing to be min 1.1 meter high from SILL  
Strength - handrail/glass pressure must be able to take 1.5kN/m and to meet BS 6180:2011 and be tested for impact loading in accordance with BS 6206 and BS EN 12600.  
"Frameless Juliette system, Code: FBAL 100 R from Balconette" or similar

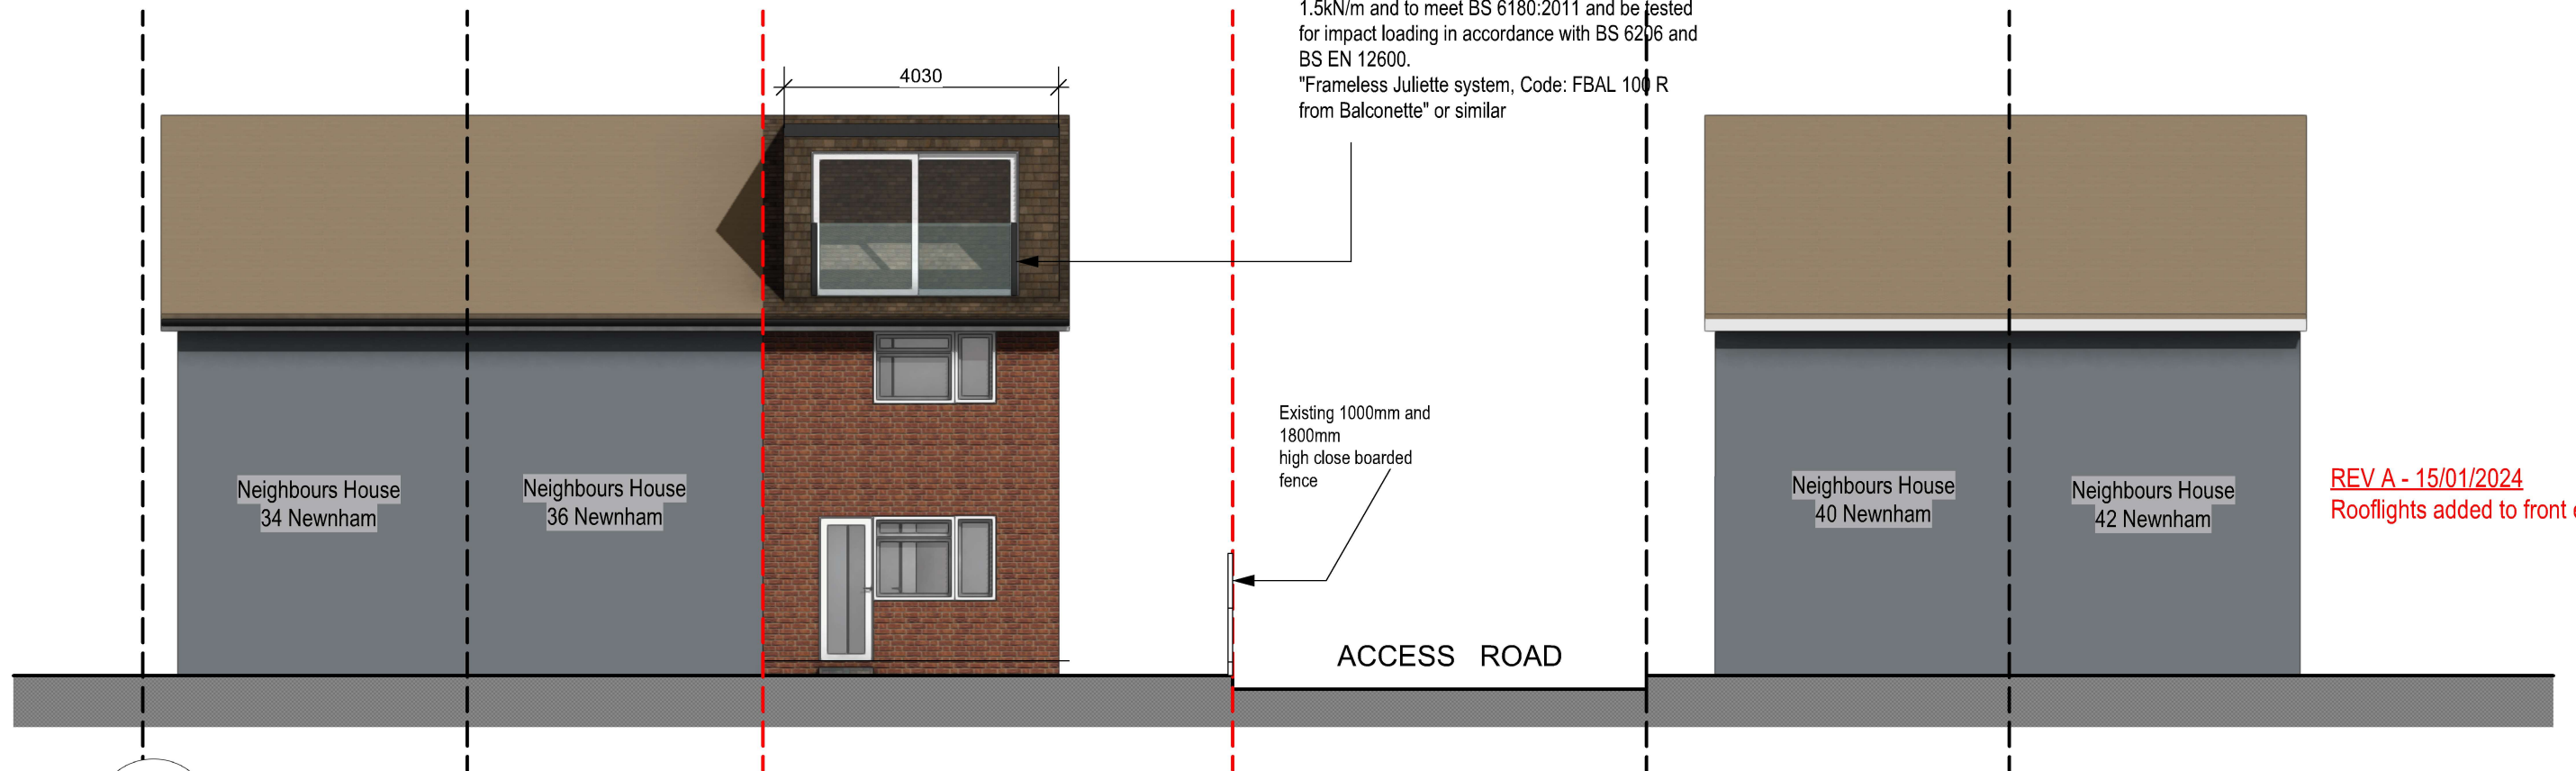

02  
**02 PROP ELEV REAR**  
Scale: 1:100

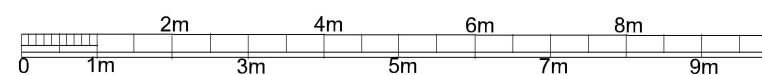

scale - 1 : 100 @ A3

REV A - 15/01/2024  
Rooflights added to front elevation

Purpose - Certificate of lawful development application

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	DWG NO: <b>PROP ELEV 13</b>	REVISION: <b>A</b>



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PROPOSED