
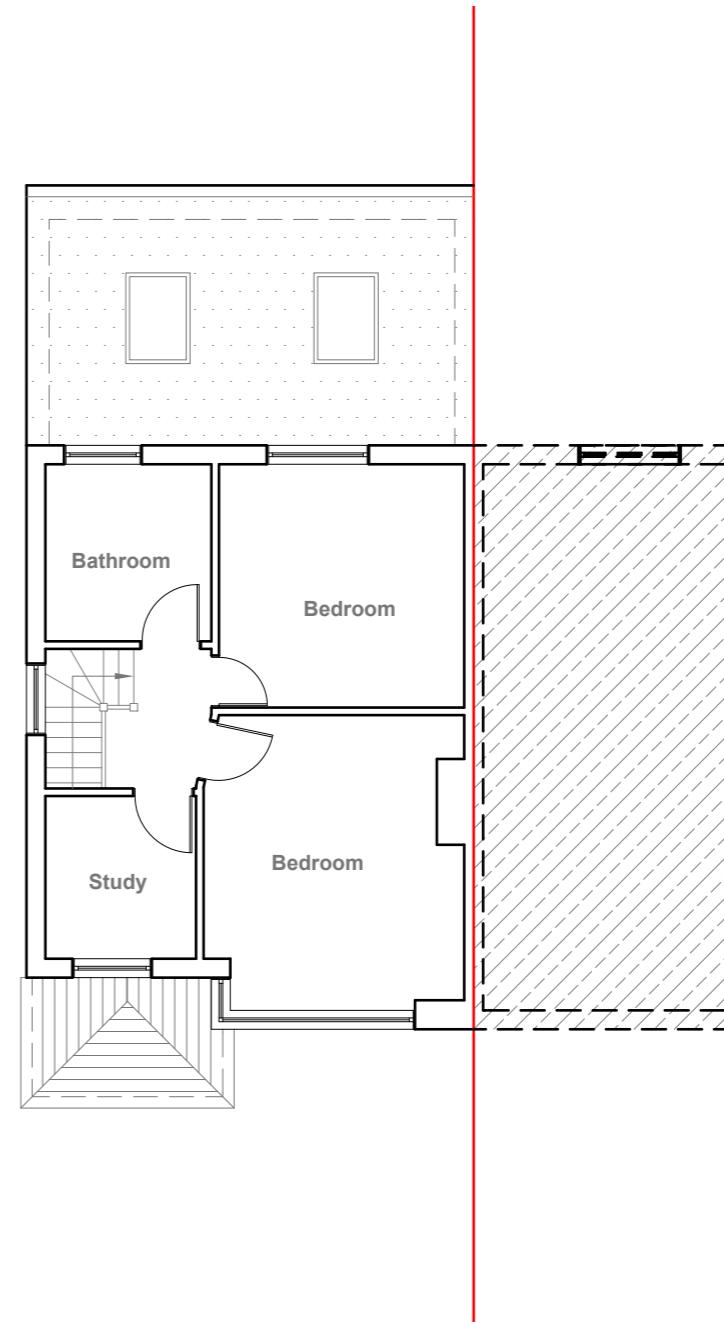


**Existing Ground Floor Plan**  
Scale 1:100

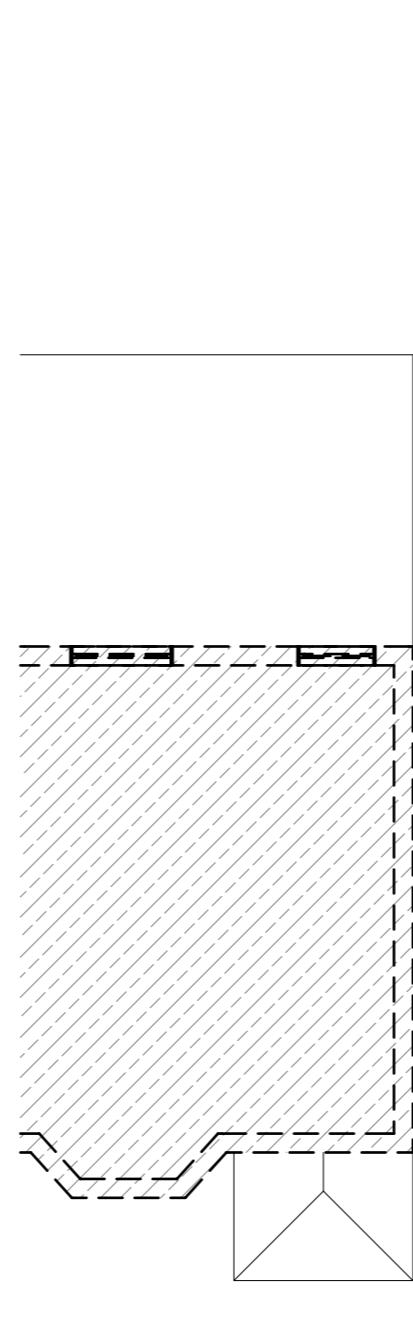

**Existing First Floor Plan**  
Scale 1:100

GENERAL NOTES:  
 1. ALL DIMENSIONS ARE IN MILLIMETER.  
 2. VERIFY ALL DIMENSIONS AND CONDITIONS BEFORE BUILDING OR  
 STARTING CONSTRUCTION. NOTIFY THE DESIGNER IMMEDIATELY OF ANY  
 DISCREPANCY OR VARIATION.  
 3. ALL WORK TO COMPLY WITH CURRENT BUILDING REGULATIONS  
 AND CODES OF PRACTICE

Title:

## Existing Floor Plans

Site Address  
9 Cerne Close,  
Hayes.  
UB4 0PR

Scale: 1:100 @A3  
Date: 18/09/2024  
Drawing No.: 2024/156 -01  
Drawn By: RO

Revision Date:  
\_\_\_\_\_  
\_\_\_\_\_  
\_\_\_\_\_  
e:mail - faluckpatel@yahoo.com  
(M) +44 (0) 7871 466 254


10 Meter  
5  
2  
1  
0  
1:100

**Faluck Patel**




## Existing Front Elevation

---

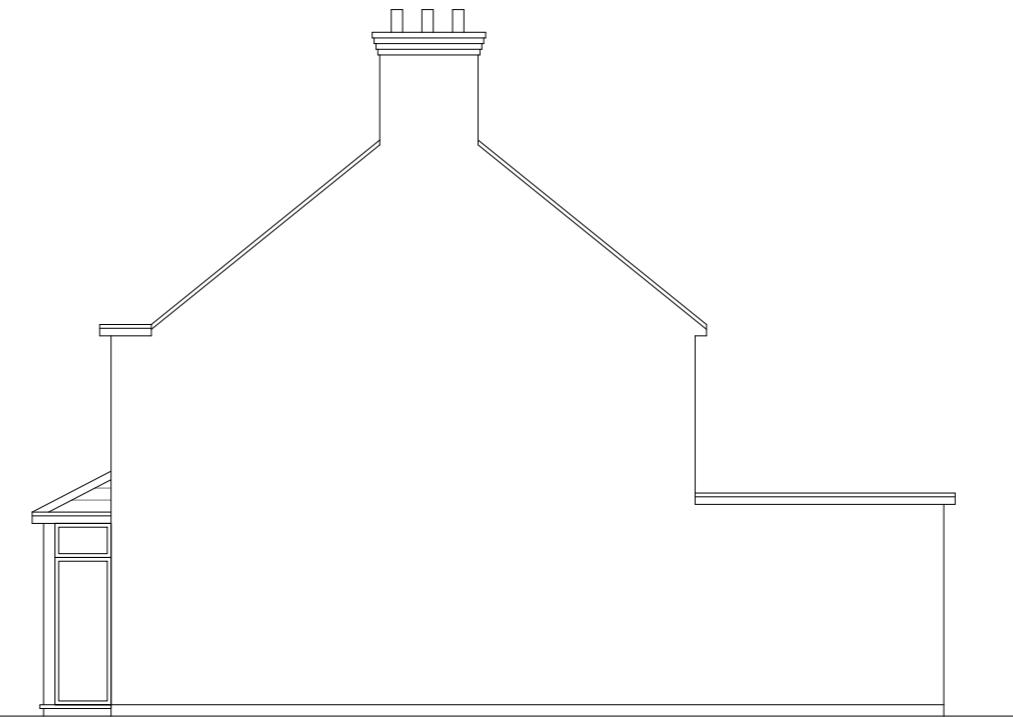

## Existing Side Elevation

---

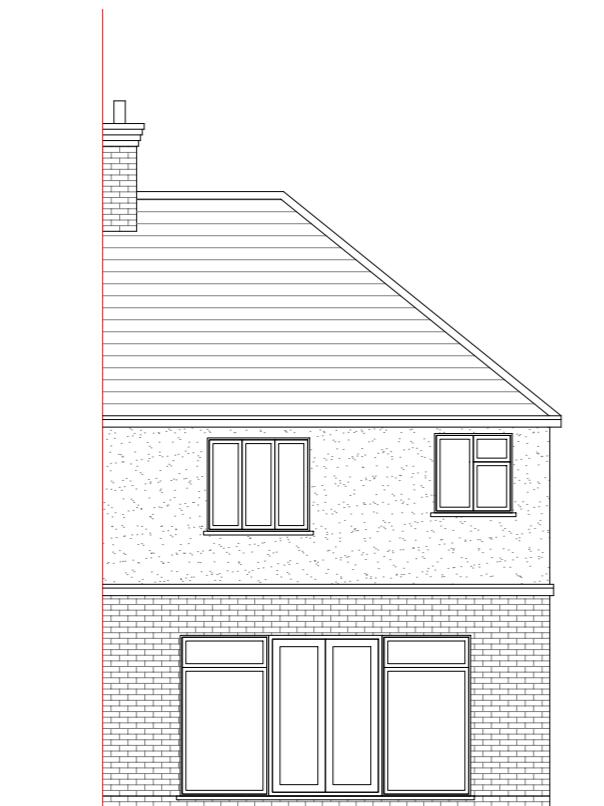

## Existing Rear Elevation

---



## Existing Side Elevation

---

#### GENERAL NOTES:

1. ALL DIMENSIONS ARE IN MILLIMETER.
2. VERIFY ALL DIMENSIONS AND CONDITIONS BEFORE BUILDING OR STARTING CONSTRUCTION. NOTIFY THE DESIGNER IMMEDIATELY OF ANY DISCREPANCY OR VARIATION.
3. ALL WORK TO COMPLY WITH CURRENT BUILDING REGULATIONS AND CODES OF PRACTICE

Title:

## Existing Elevations

Site Address  
9 Cerne Close  
Hayes.  
UB4 0PR

Scale: 1:100 @A3  
Date: 18/09/2024  
Drawing No.: 2024/156 -02

Revision Date:


---

---

---

A scale bar for a 1:100 map. It consists of a horizontal line divided into 10 equal segments, each labeled with the number '1'. To the right of the line, the text '10 Meter' is written vertically.

# Faluck Patel

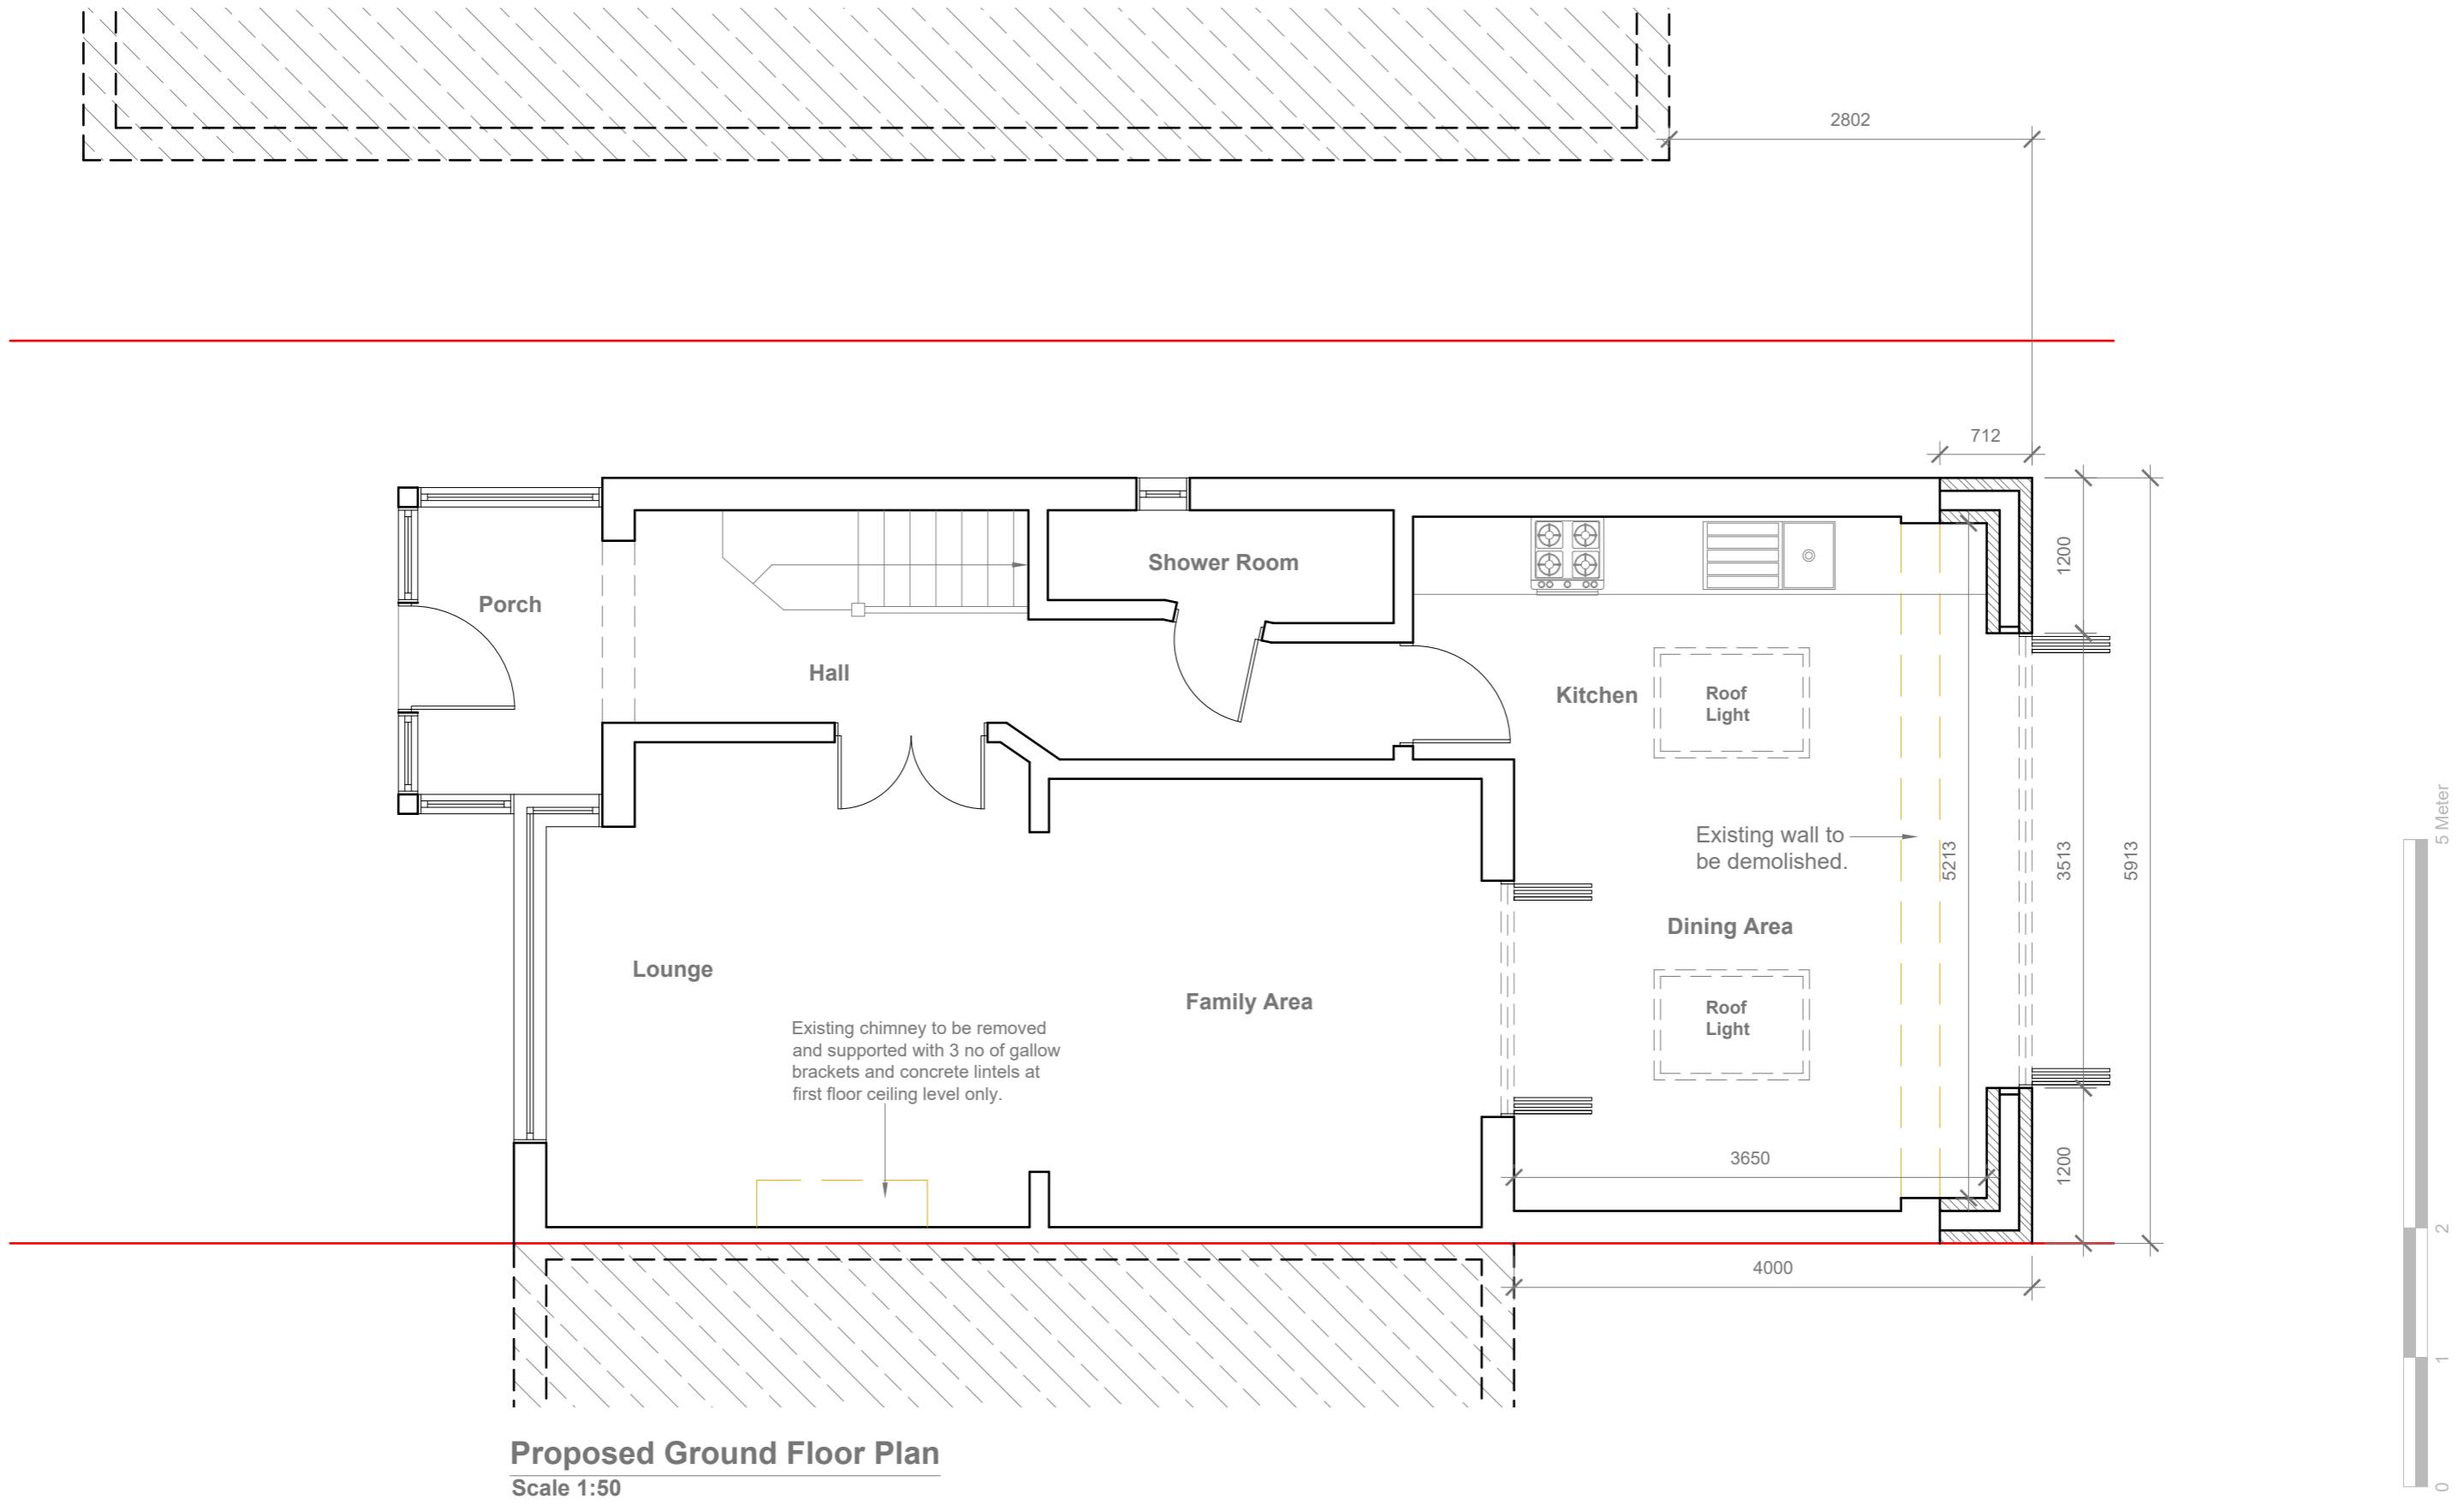

## Proposed Ground Floor Plan

Scale 1:50

#### GENERAL NOTES:

1. ALL DIMENSIONS ARE IN MILLIMETER.
2. VERIFY ALL DIMENSIONS AND CONDITIONS BEFORE BUILDING OR STARTING CONSTRUCTION. NOTIFY THE DESIGNER IMMEDIATELY OF ANY DISCREPANCY OR VARIATION.
3. ALL WORK TO COMPLY WITH CURRENT BUILDING REGULATIONS AND CODES OF PRACTICE

Title:

## Proposed Ground Floor Plan

Site Address

Scale: 1:50 @A3

Revision Date:


9 Cerne Close,  
Hayes.  
UB4 0PR

Date: 18/09/2024  
Drawing No.: 2024/156 -03


# Faluck Patel



**Proposed Front Elevation**  
Scale 1:100

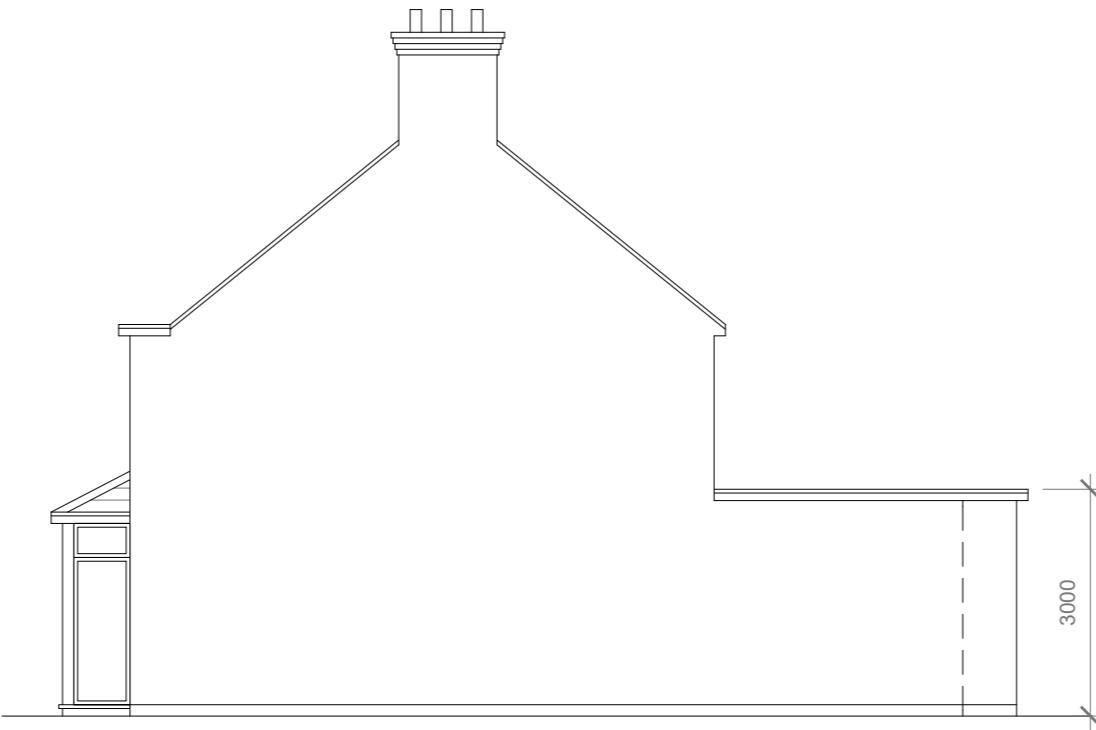

**Proposed Side Elevation**  
Scale 1:100

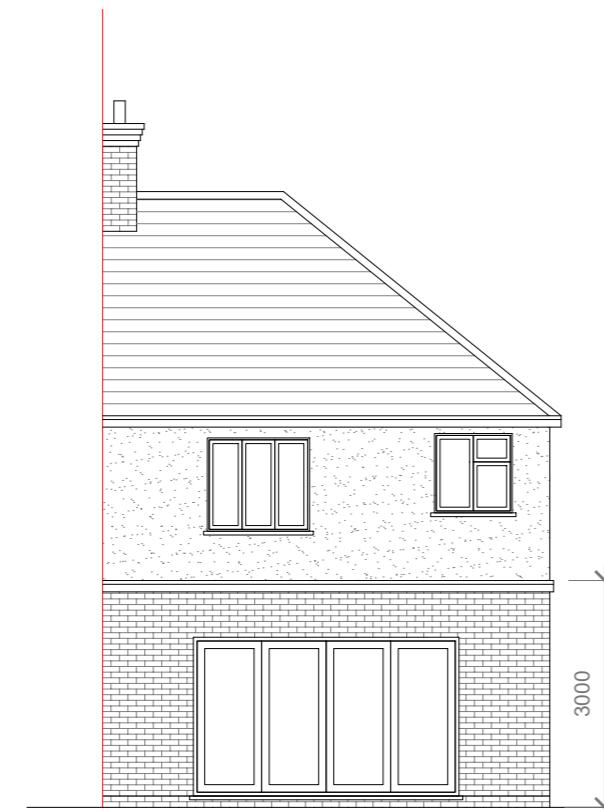

**Proposed Rear Elevation**  
Scale 1:100



**Proposed Side Elevation**  
Scale 1:100

**GENERAL NOTES:**

1. ALL DIMENSIONS ARE IN MILLIMETER.
2. VERIFY ALL DIMENSIONS AND CONDITIONS BEFORE BUILDING OR STARTING CONSTRUCTION. NOTIFY THE DESIGNER IMMEDIATELY OF ANY DISCREPANCY OR VARIATION.
3. ALL WORK TO COMPLY WITH CURRENT BUILDING REGULATIONS AND CODES OF PRACTICE

**Title:**

## Proposed Elevations

**Site Address**  
9 Cerne Close,  
Hayes.  
UB4 0PR

**Scale: 1:100 @A3**  
Date: 18/09/2024  
Drawing No.: 2024/156-04  
Drawn By: RO

**Revision Date:**  
e:mail - faluckpatel@yahoo.com  
(M) +44 (0) 7871 466 254

