



Existing Ground Floor Plan
Scale 1:100

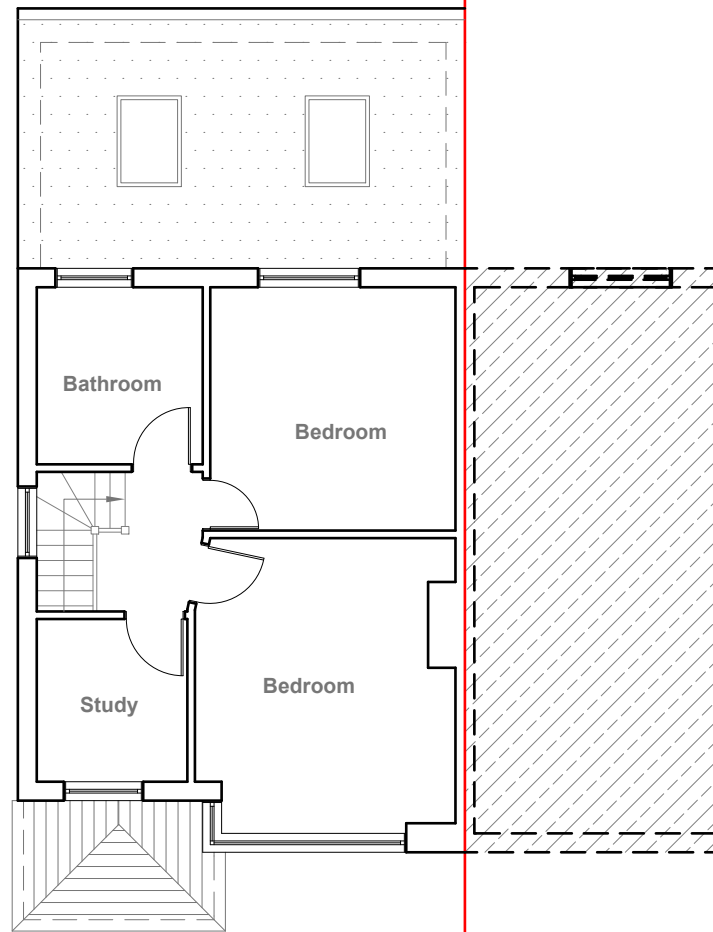

Existing First Floor Plan
Scale 1:100

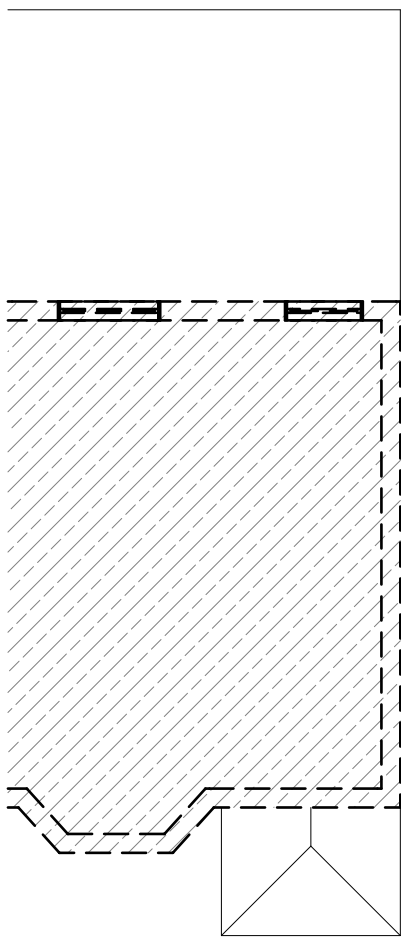

GENERAL NOTES:
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2. VERIFY ALL DIMENSIONS AND CONDITIONS BEFORE BUILDING OR STARTING CONSTRUCTION. NOTIFY THE DESIGNER IMMEDIATELY OF ANY DISCREPANCY OR VARIATION.
3. ALL WORK TO COMPLY WITH CURRENT BUILDING REGULATIONS AND CODES OF PRACTICE

Title:

Existing Floor Plans


Site Address
9 Cerne Close,
Hayes.
UB4 0PR

Scale: 1:100 @A3
Date: 18/09/2024
Drawing No.:
2024/156 -01
Drawn By:
RO


Revision Date:

e:mail -
faluckpatel@yahoo.com
(M) +44 (0) 7871 466 254



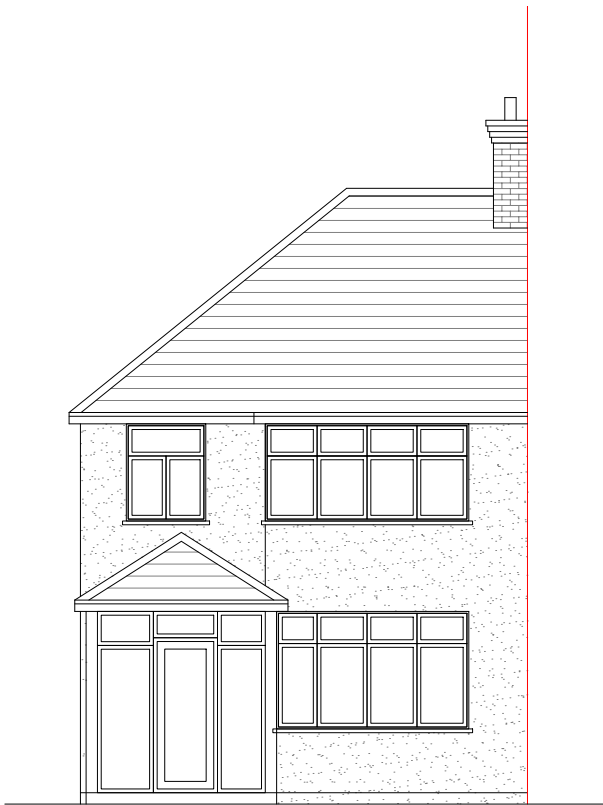

Existing Front Elevation
Scale 1:100

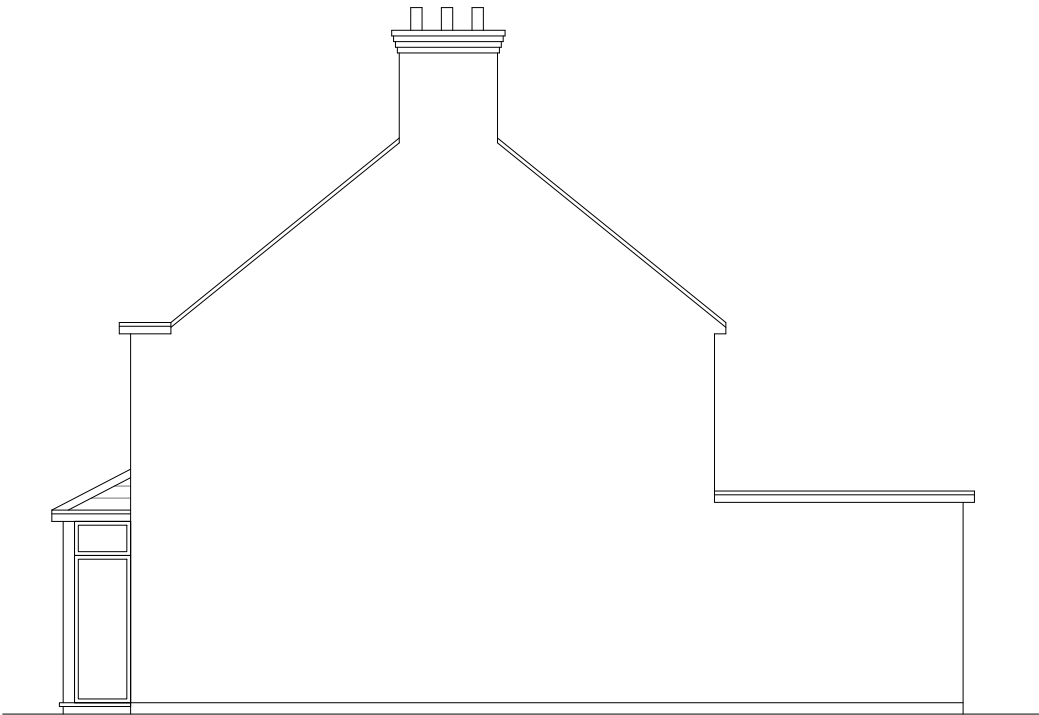

Existing Side Elevation
Scale 1:100



Existing Rear Elevation
Scale 1:100



Existing Side Elevation
Scale 1:100



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Title:

Existing Elevations

Site Address

9 Cerne Close,
Hayes.
UB4 0PR

Scale: 1:100 @A3

Date: 18/09/2024

Drawing No.:
2024/156 -02

Drawn By:
RO

Revision Date:


e:mail -
faluckpatel@yahoo.com
(M) +44 (0) 7871 466 254



Velux Window to be installed as per manufacturer specification, not projected more than 150mm from the plane of roof slope.



Proposed Front Elevation
Scale 1:100

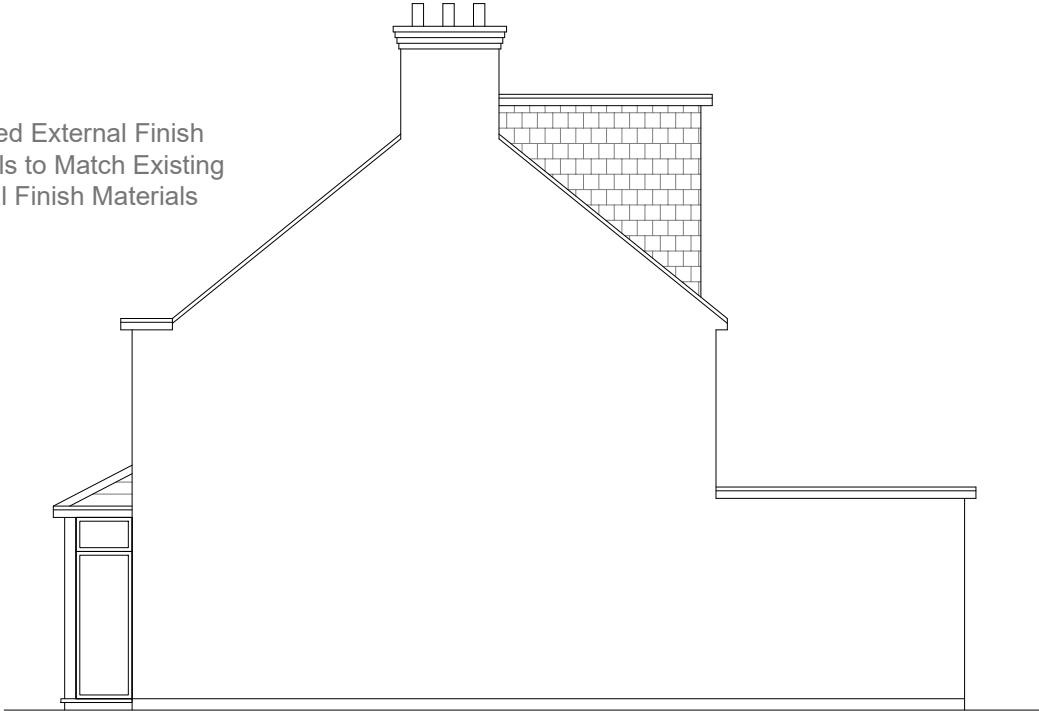

Proposed Side Elevation
Scale 1:100


REAR DORMER VOLUME = $W \times H \times L / 2$
 $5.638 \times 2.682 \times 3.320 / 2$
 $50.20 / 2$
 $V1 = 25.10 \text{ CU.MT.}$

HIP TO GABLE ROOF VOLUME = $W1 \times H1 \times L1 / 6$
 $7.340 \times 3.115 \times 3.520 / 6$
 $80.48 / 6$
 $V2 = 13.41 \text{ CU.MT.}$

TOTAL ROOF VOLUME = $V1 + V2$
 $25.10 + 13.41$
 $38.51 \text{ CU.MT.} < 50.00 \text{ CU.MT}$



Proposed Rear Elevation
Scale 1:100

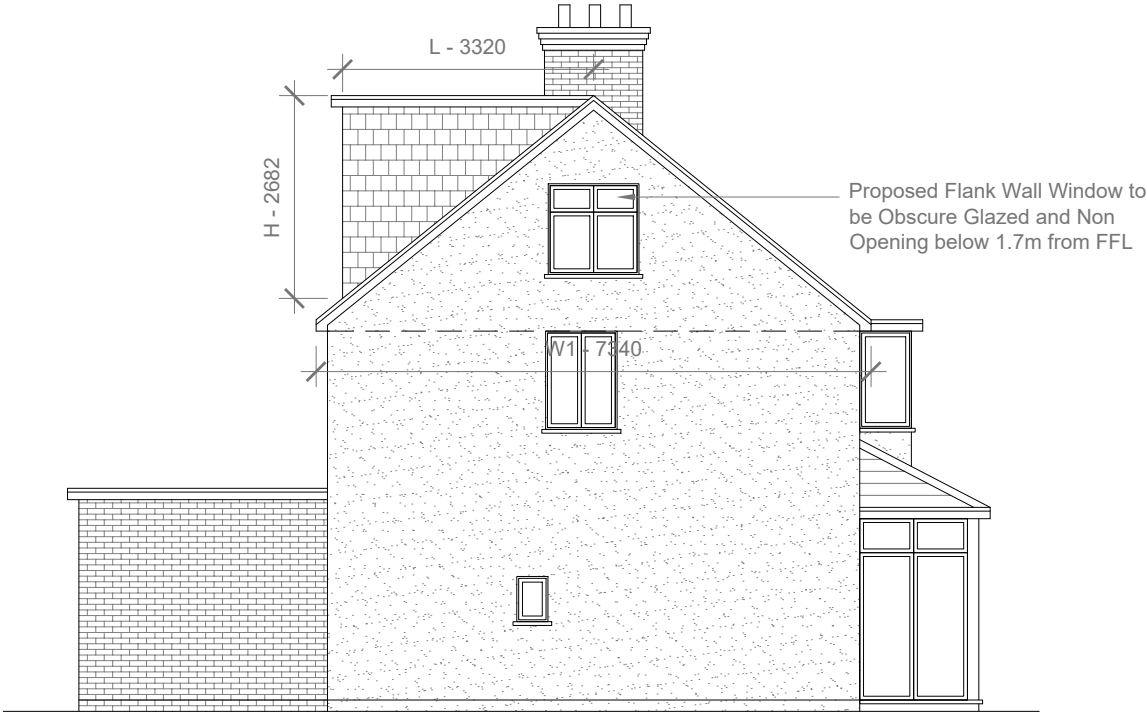

Proposed Side Elevation
Scale 1:100



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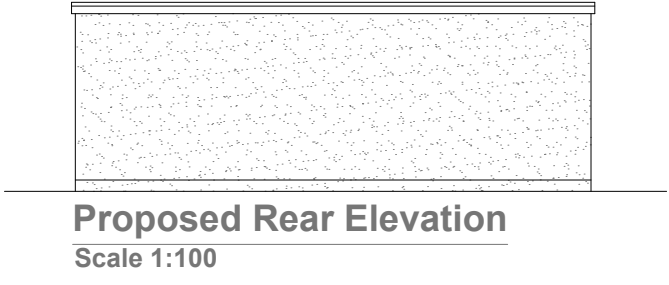
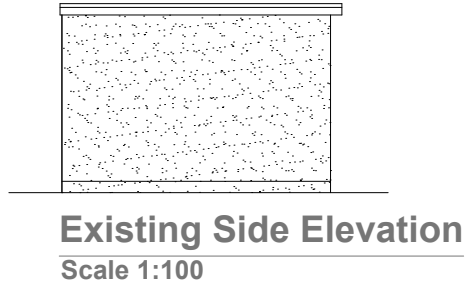
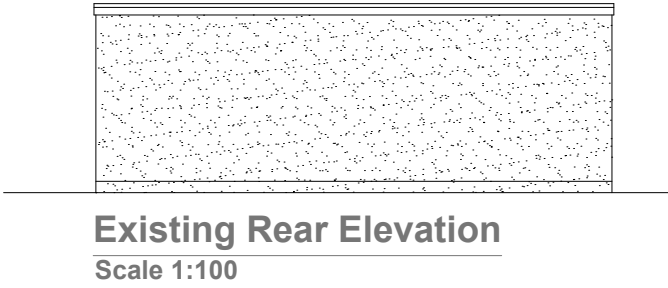
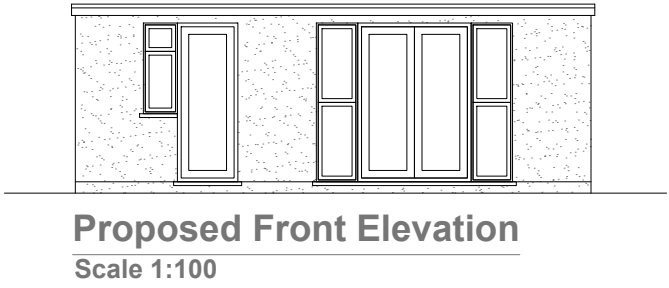
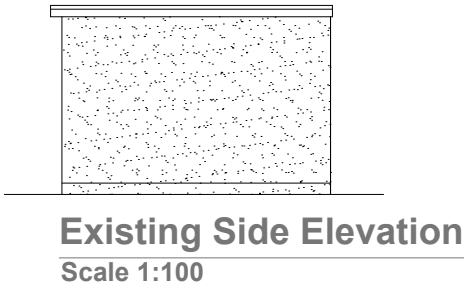
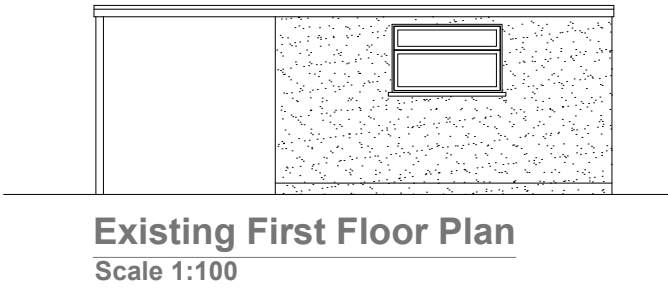
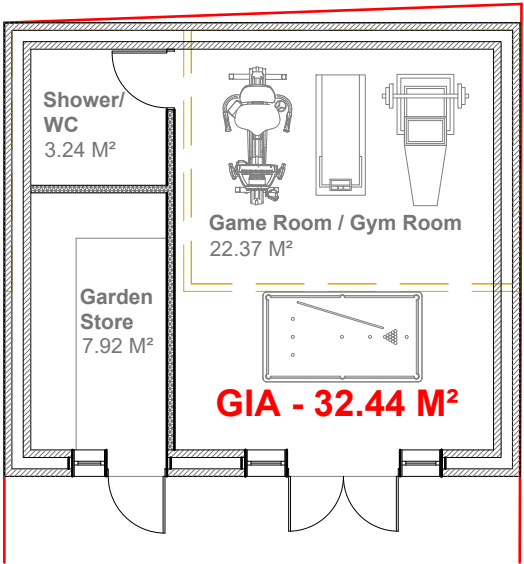
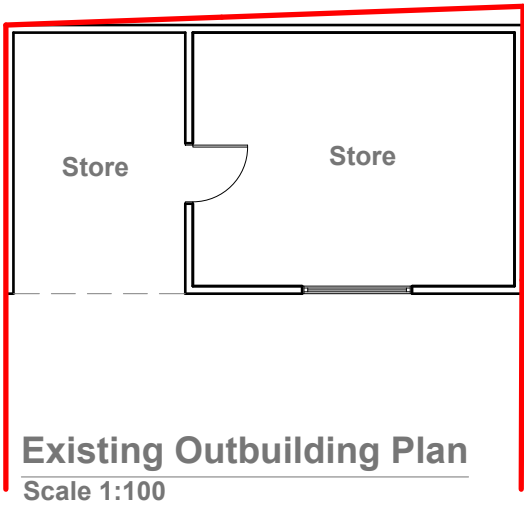
Title:

Proposed Elevations

Site Address	Scale: 1:100 @A3	Revision Date:
9 Cerne Close, Hayes. UB4 0PR	Date: 18/09/2024	
	Drawing No.: 2024/156 -04	
	Drawn By: RO	e:mail - faluckpatel@yahoo.com (M) +44 (0) 7871 466 254



Proposed External Finish
Materials to Match Existing
External Finish Materials



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Title:

Proposed Elevations

Site Address
9 Cerne Close,
Hayes.
UB4 0PR

Scale: 1:100 @A3
Date: 18/09/2024
Drawing No.:
2024/156 -05PD
Drawn By:
RO

Revision Date:

e:mail -
faluckpatel@yahoo.com
(M) +44 (0) 7871 466 254

