



Existing Ground Floor Plan
Scale 1:100



Existing First Floor Plan
Scale 1:100

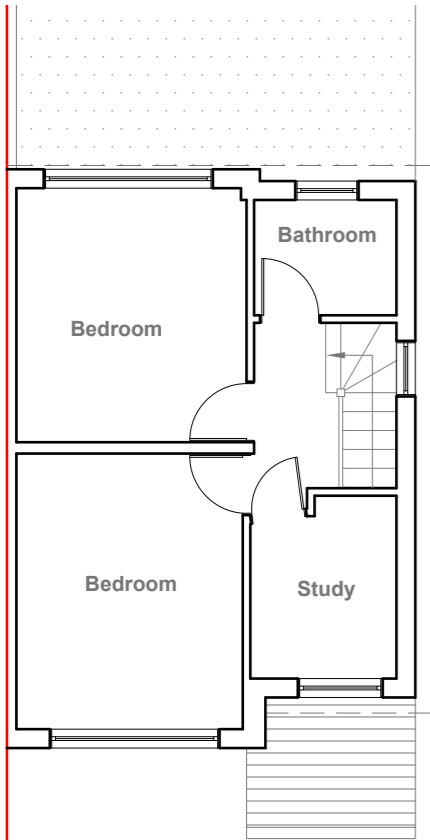


Existing Front Elevation
Scale 1:100

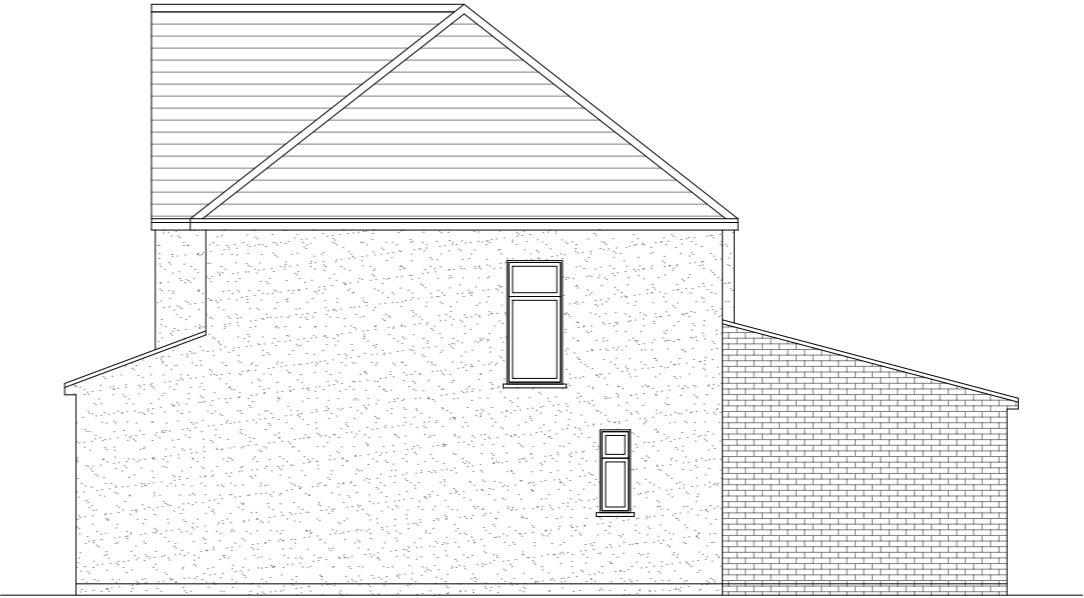

Existing Side Elevation
Scale 1:100




Existing Rear Elevation
Scale 1:100

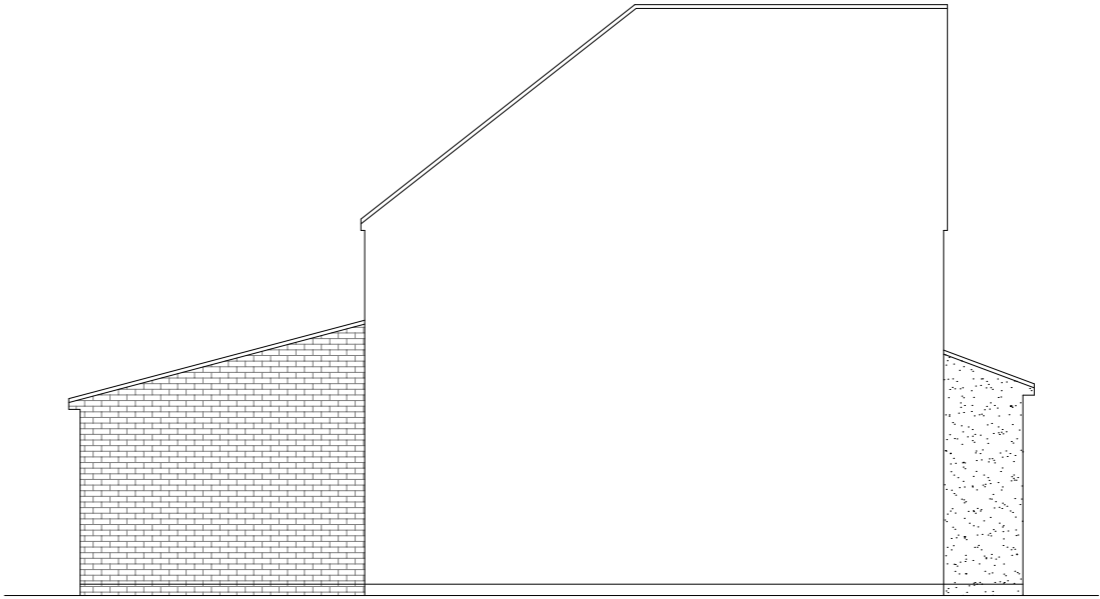


Existing Side Elevation
Scale 1:100



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|-------------------------------------------------------------------------------------------------------------------------------------------------------------------------------------------------------------------------------------------------------------------------------------------------------------------------------------------------------------|-------------------------------------------------------------------|-----------------------------------------------------------------|----------------------------------|--------------------------------------------------------------------|----------------------------|
| <p>GENERAL NOTES:</p> <ol style="list-style-type: none">1. ALL DIMENSIONS ARE IN MILLIMETER.2. VERIFY ALL DIMENSIONS AND CONDITIONS BEFORE BUILDING OR STARTING CONSTRUCTION. NOTIFY THE DESIGNER IMMEDIATELY OF ANY DISCREPANCY OR VARIATION.3. ALL WORK TO COMPLY WITH CURRENT BUILDING REGULATIONS AND CODES OF PRACTICE | <p>Title:</p> <p>Existing Floor Plans & Elevations</p> | <p>Site Address</p> <p>6 Phelps Way, Hayes. UB3 4LH</p> | <p>Scale: 1:100 @A3</p> | <p>Revision Date:</p> | <p>Faluck Patel</p> |
| | | | <p>Date: 12/08/2025</p> | | |
| | | | <p>Drawing No.: 2025/116 -01</p> | | |
| | | | <p>Drawn By: RO</p> | | |
| | | | | <p>e:mail - faluckpatel@yahoo.com (M) +44 (0) 7871 466 254</p> | |

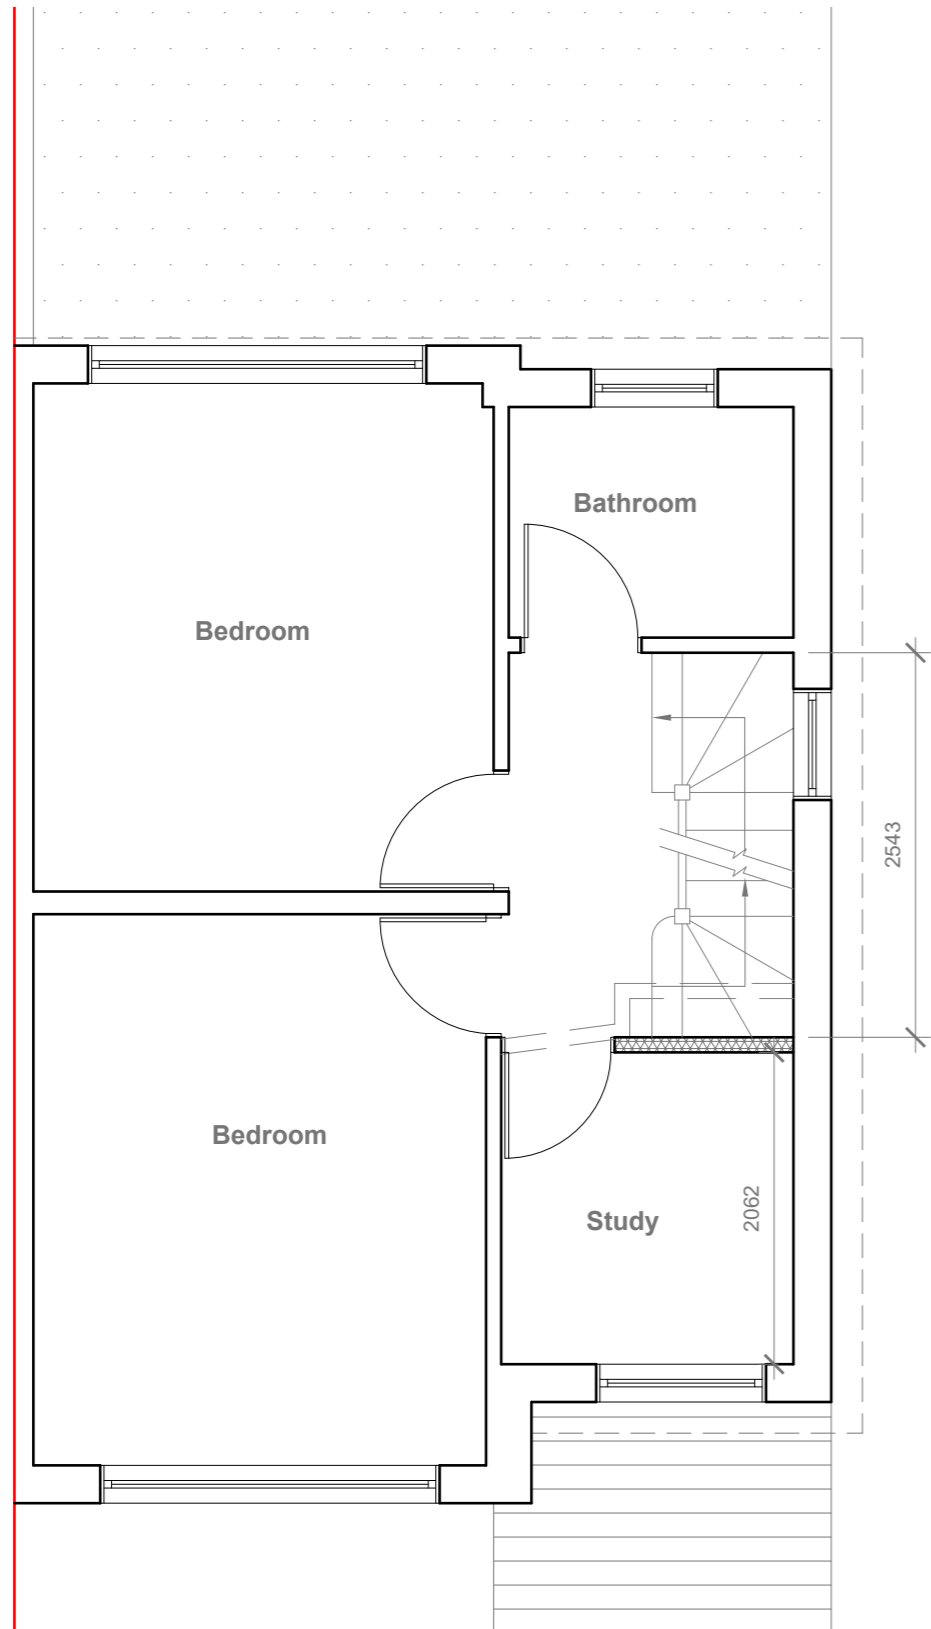

Proposed First Floor Plan
Scale 1:50

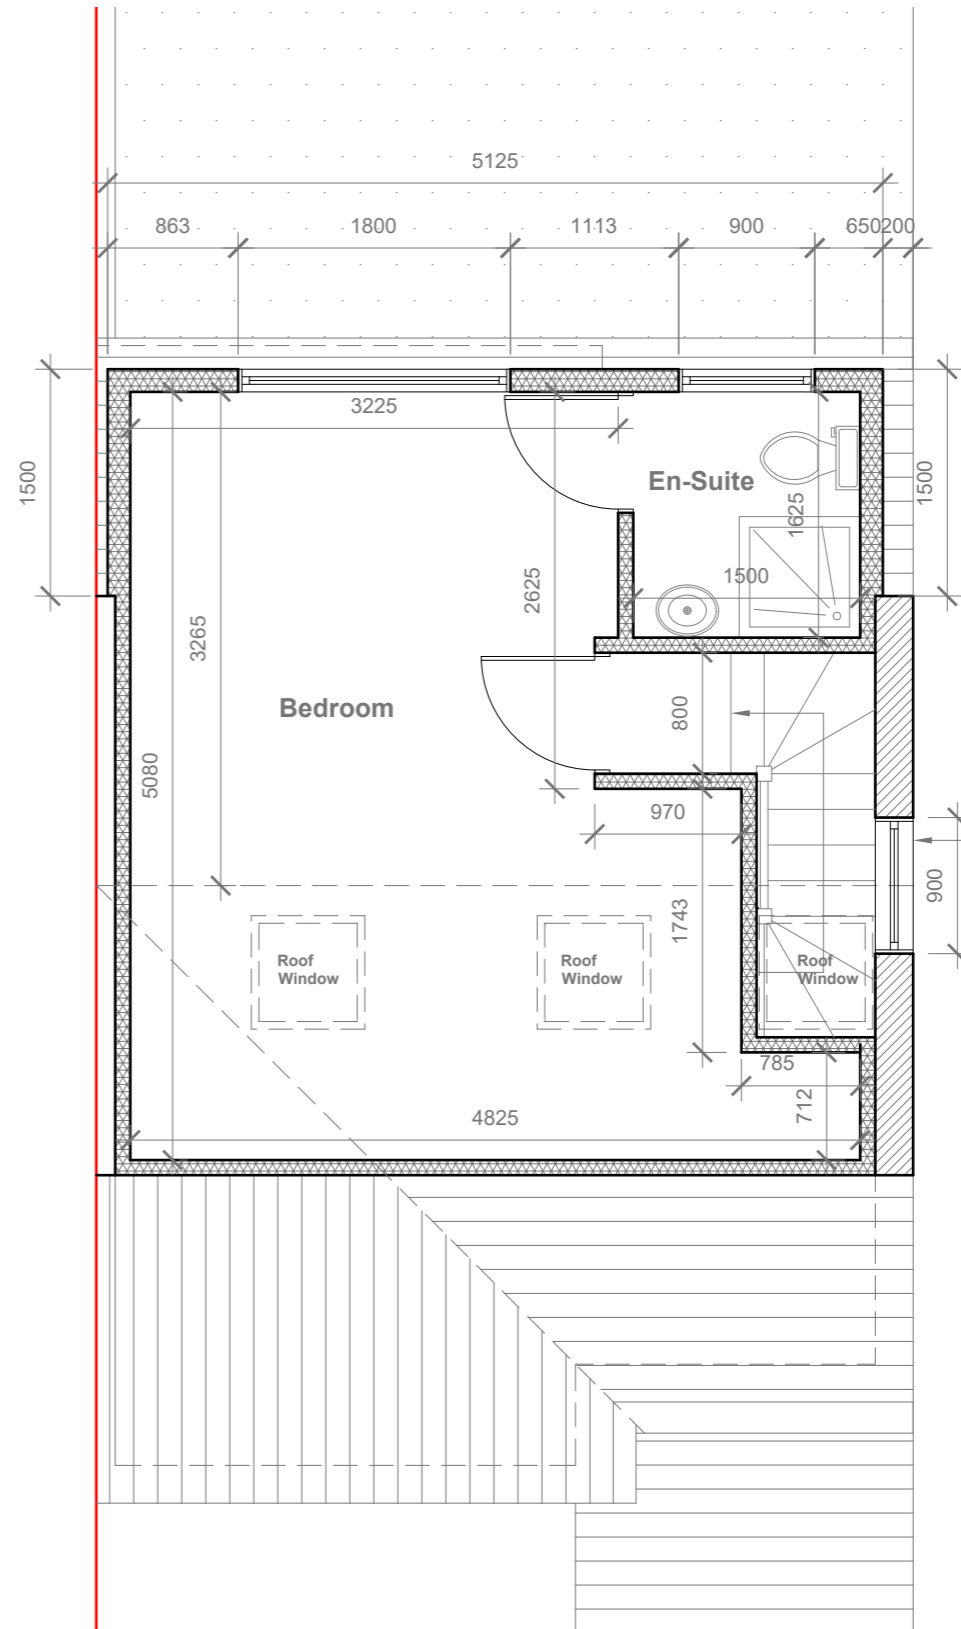

Proposed Loft Floor Plan
Scale 1:50

Proposed Flank Wall Window to be Obscure Glazed and Non Opening below 1.7m from FFL

Velux Window to be installed as per manufacturer specification, not projected more than 150mm from the plane of roof slope



- GENERAL NOTES:
1. ALL DIMENSIONS ARE IN MILLIMETER.
 2. VERIFY ALL DIMENSIONS AND CONDITIONS BEFORE BUILDING OR STARTING CONSTRUCTION. NOTIFY THE DESIGNER IMMEDIATELY OF ANY DISCREPANCY OR VARIATION.
 3. ALL WORK TO COMPLY WITH CURRENT BUILDING REGULATIONS AND CODES OF PRACTICE

Title:

Proposed First Floor & Loft Plans

Site Address

6 Phelps Way,
Hayes.
UB3 4LH

Scale: 1:50 @A3

Date: 12/08/2025

Drawing No.:
2025/116 -02

Drawn By:

RO

Revision Date:

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(M) +44 (0) 7871 466 254

**Faluck
Patel**

Velux Window to be installed as per manufacturer specification, not projected more than 150mm from the plane of roof slope



Proposed Front Elevation
Scale 1:100

Proposed Flank Wall Window to be Obscure Glazed and Non Opening below 1.7m from FFL



Proposed Side Elevation
Scale 1:100

REAR DORMER VOLUME = $W \times H \times L / 2$
 $5.125 \times 2.675 \times 3.415 / 2$
 $46.81 / 2$
V1 = 23.40 CU.MT.


HIP TO GABLE ROOF VOLUME = $W1 \times H1 \times L1 / 6$
 $7.242 \times 2.986 \times 3.415 / 6$
 $73.84 / 6$
V2 = 12.30 CU.MT.

TOTAL ROOF VOLUME = $V1 + V2$
 $23.40 + 12.30$
35.70 CU.MT.< 50.00 CU.MT



Proposed Rear Elevation
Scale 1:100

Proposed External Finish Materials to Match Existing External Finish Materials

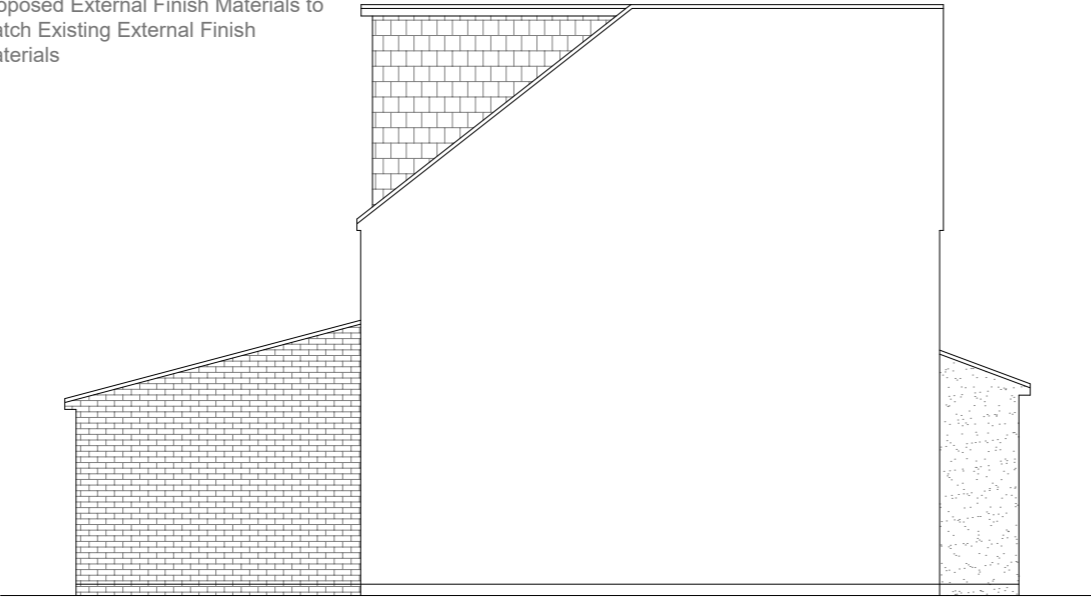

Proposed Side Elevation
Scale 1:100



- GENERAL NOTES:
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 2. VERIFY ALL DIMENSIONS AND CONDITIONS BEFORE BUILDING OR STARTING CONSTRUCTION. NOTIFY THE DESIGNER IMMEDIATELY OF ANY DISCREPANCY OR VARIATION.
 3. ALL WORK TO COMPLY WITH CURRENT BUILDING REGULATIONS AND CODES OF PRACTICE

Title:

Proposed Elevations

| | | |
|------------------------------------|------------------------------|---------------------------------------------------------------|
| Site Address | Scale: 1:100 @A3 | Revision Date: |
| 6 Phelps Way, Hayes. UB3 4LH | Date: 12/08/2025 | |
| | Drawing No.: 2025/116 -03 | |
| | Drawn By: RO | e:mail - faluckpatel@yahoo.com (M) +44 (0) 7871 466 254 |

