

Notes:**Proposal:**

To remove the existing porch and build the proposed toilet and shower room, moving the front wall toward the road, by 350mm extending the hall within the proposed porch area only.

Fenestration:

Double glazed door to conform to safety glazing BS6206
Windows in white uPVC to visually match existing, windows and door to 'A' rated heat retention.
Trickle ventilation to be provided to conform with regulations. (Building control)

Walls:
Brickwork up to sill level and roughcast render (pebbledash) above to match existing.
Brickwork on house trimmed back and pebble dashed

Wall construction:
Provide 'catnic' lintels type CN7 or CN45 (closed eaves type) over all external openings.

Cavity 102mm thick facing brickwork to match the existing property, with a 75mm wide cavity filled with 'rockwool' 75mm insulation batts. 100mm thick 'colcon' block work inner leaf and 13mm thick lightweight plaster finish.

Provide pitch polymer damp proof course 150mm min above finished ground level.

Both leaves in brickwork below D.P.C. down to top of foundation.

Tie walls together with mild steel galvanised cavity wall ties at 450mm c/c vertically and 900mm c/c horizontally in a staggered fashion, double at corners and reveals. Tie walls to existing property with 'furfix' metal profiles, provide vertical damp proof courses at all new external wall openings.

Floor construction: Solid.

Minimum thickness of 75mm PIR or 100mm Jablite is to be provided below floor slab level.
50mm thick cement/sand screed (1:3 mix) with 1200 gauge polythene damp proof membrane to underside of 100mm thick concrete floor slab (1:2:4) mix on a 150mm thick layer of hardcore well banded with soft sand.

Turn D.P.M. up and into walls and lap well with D.P.C.s
Concrete doorstep to suit new floor height

Foundations:

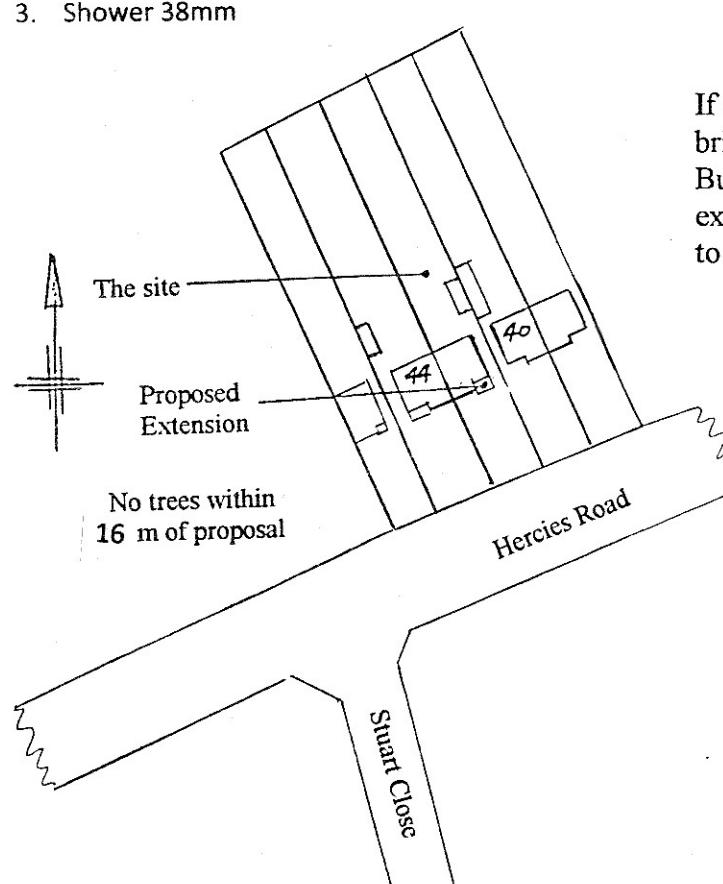
500mm wide trench fill concrete (1:2:4 mix) at 1.2 meter minimum below ground level.

Plumbing:

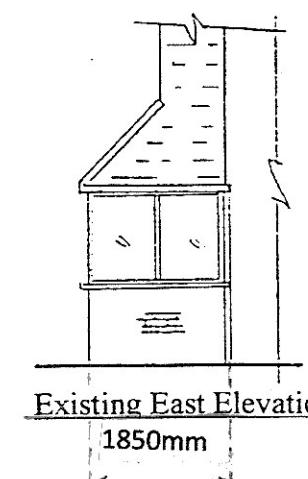
All plumbing works to be carried out in accordance with B.S. 5572.
Wastes to be fitted with 75mm deep seal water traps with eyes fitted at all bends.

Minimum waste diameters:

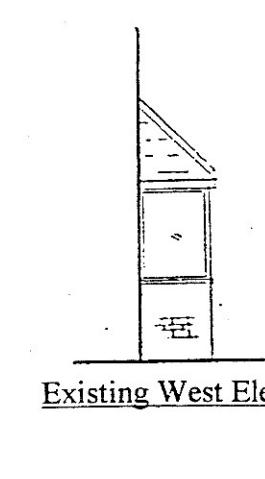
1. W.C 100mm
2. W.H. basin 32mm
3. Shower 38mm

**Site location Plan 1:1250****Proposed Front Elevation**
900mm x 2100mm door frame size
Allow for low threshold sill

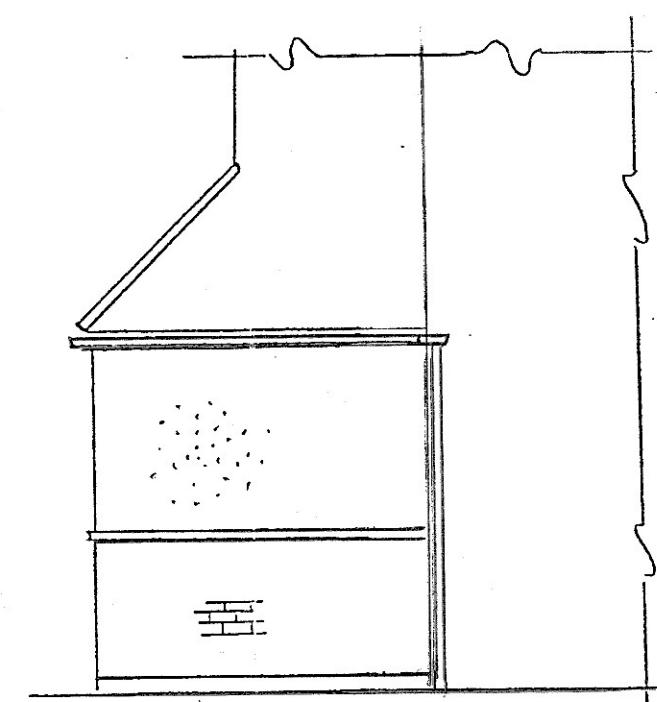
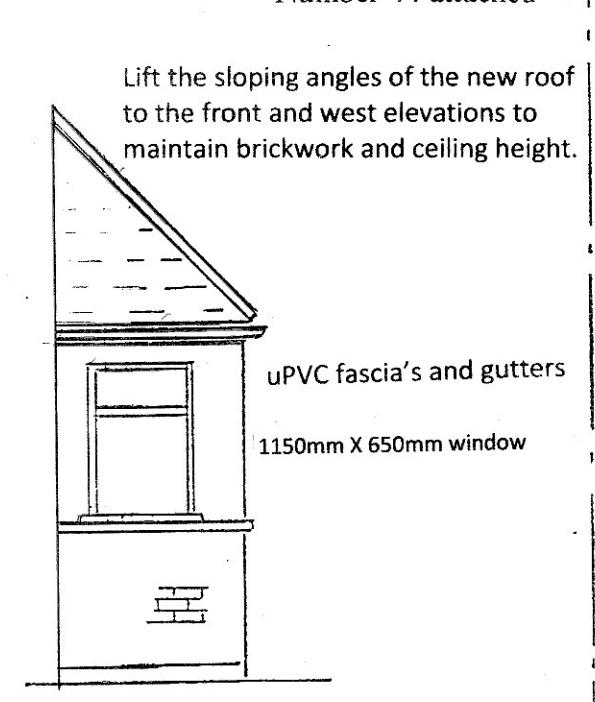
1150mm X 700mm window
High security windows & entrance door.
Obscure glazing in windows & entrance door.

Existing Front Elevation

1850mm
40 metres to rear boundary.



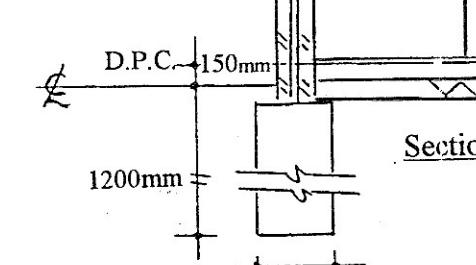
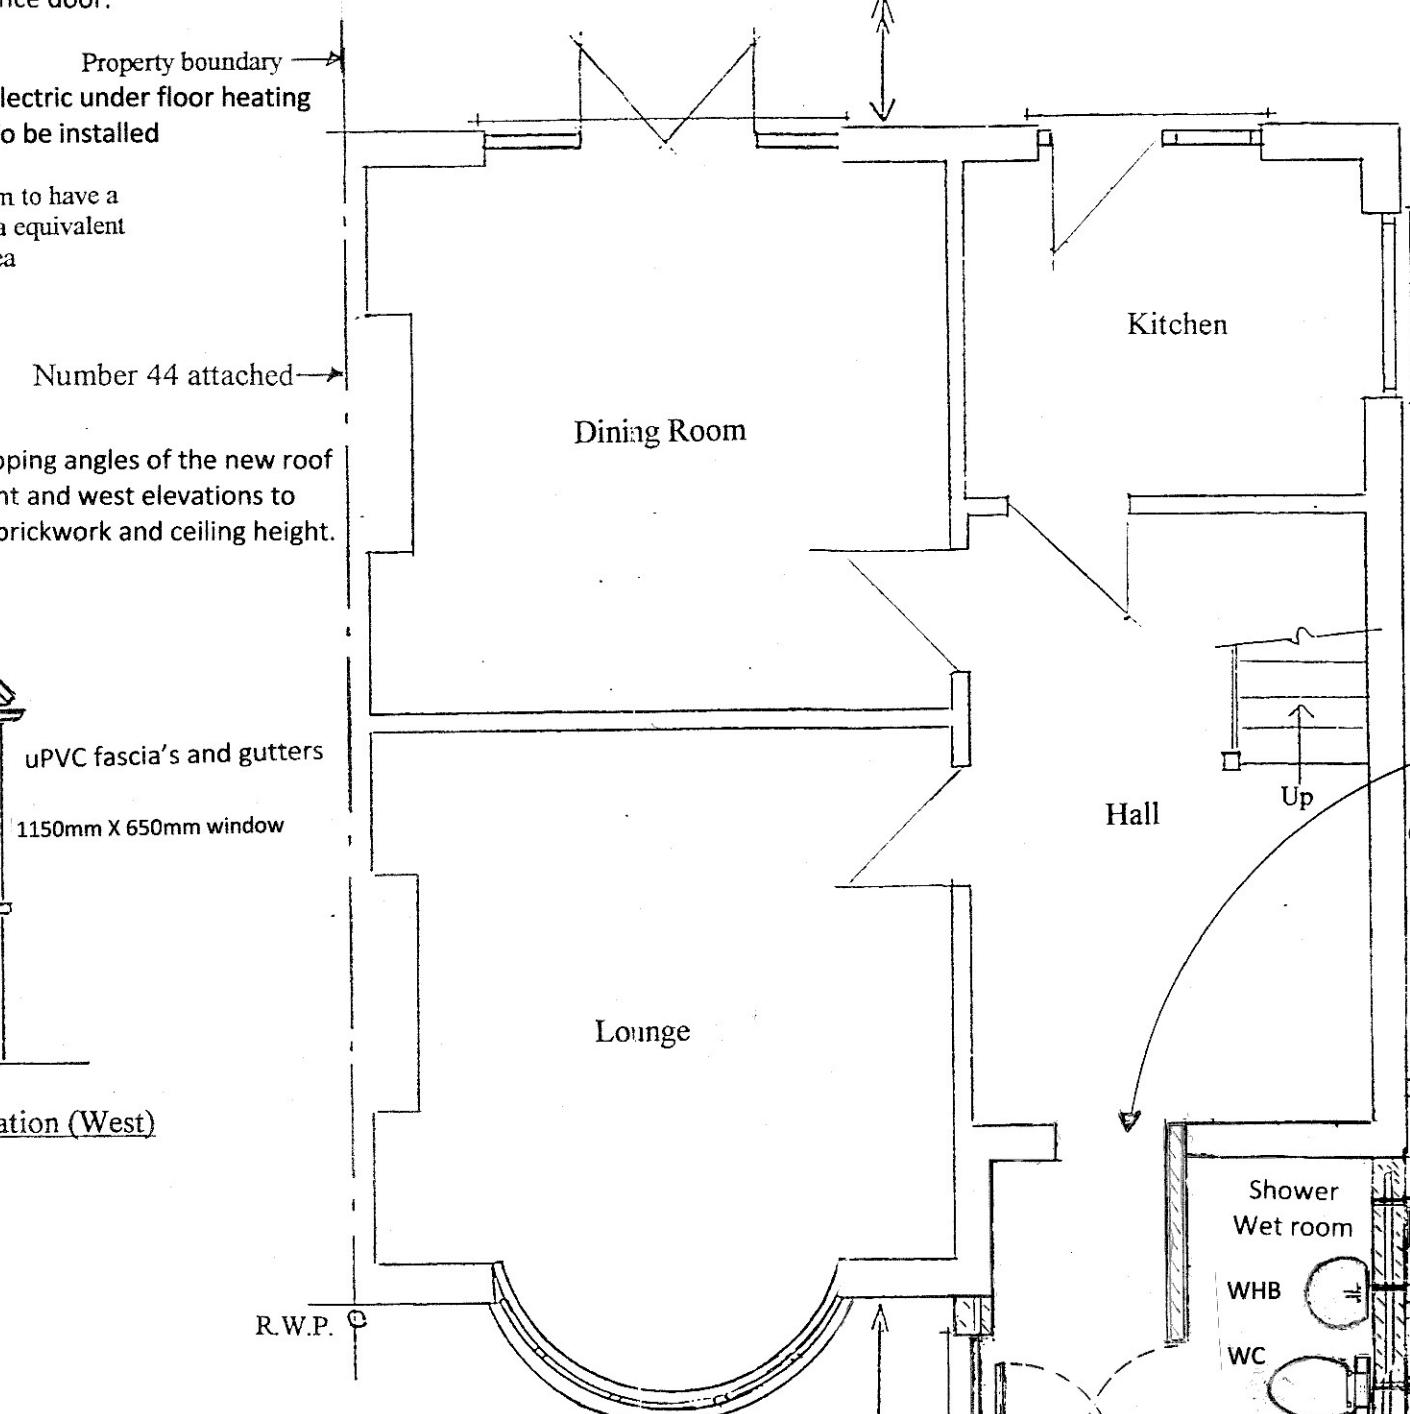
Existing West Elevation

**Proposed Side Elevation (East)****Proposed Side Elevation (West)**

If necessary support for existing brickwork over is not found.
Build in lintel to span from existing front elevation brickwork to new cavity wall.

SC3 Grade timber ceiling joists to be 50mm x 100mm S.W. at 400mm C/C (if not already) built into wall or hung on M.S. galv hangers.
Ceiling 9.5mm thick plasterboard plus skim finish.
There is to be a minimum of 270mm Rockwool provided between and Over the new crown roof to the front extension. (Building control)

Existing and new floors
To line through

**Section****Proposed Ground Floor Plan**

Drainage:-
All works to be carried out to B.S.8301:1985 new drain runs to be 100mm dia U.P.V.C pipe surrounded in pea shingle and laid to a minimum fall of 1in 40.
Existing and new runs to be protected over with reinforced concrete lintels where runs pass through foundations.
Encase runs in concrete where below extension.

Surface water collection unaltered -ie to existing gutters and R.W.P. located on flank wall.
(no surface water I.C.'s found at time of survey).

Take down windows, doors and 100mm thick brickwork to existing porch, rebuild wall in cavity construction and realign roof as necessary.

New inspection chamber to be installed in accordance with the manufacturers details/ recommendations.

Provide mechanical extractor fan to wet room (in addition to opening window) giving 20 litres per second air change, external wall mounted.
Provide suitable lighting to wet room and hallway.

All electrical work under Part P (electrical safety) must be designed, installed, inspected and tested by a person competent to do so. (Building control) Builder to supply and fit stainless steel towel radiator to new wet room. Wet room walls lined with waterproof board of the "Multipanel" type

Revisions Building Regulations 01/09/03

All measurements to be verified on site prior to commencement. This drawing is subject to Local Authority approval

SINGLE STOREY FRONT EXTENSION Drawing issue 3 Scale 1:50 , 1:100
At 42 Hercies Road, Hillingdon, Middx. 1 of 2
Date 05/12/19

For Mr Mrs Levett Tel No 01895 235918 Drawing no. M50