




EXISTING FRONT ELEVATION 1:100 SCALE

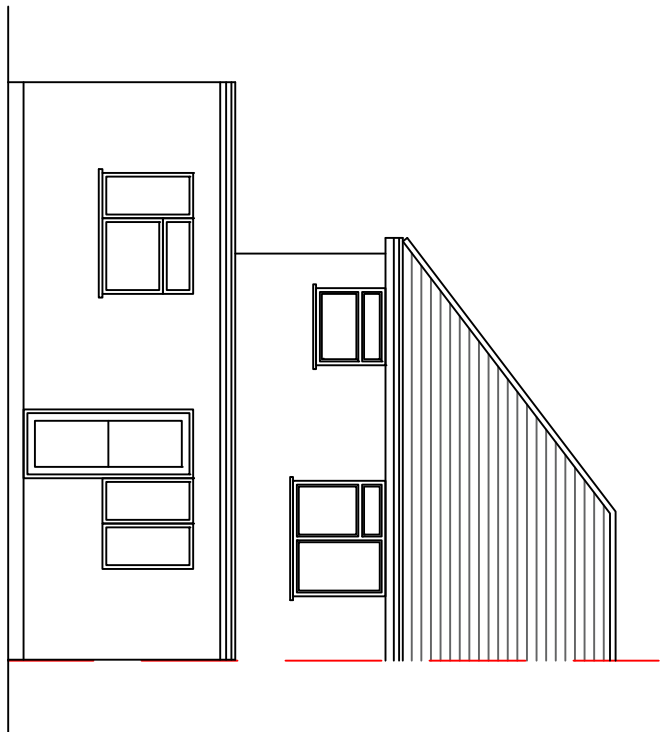

EXISTING REAR ELEVATION 1:100 SCALE

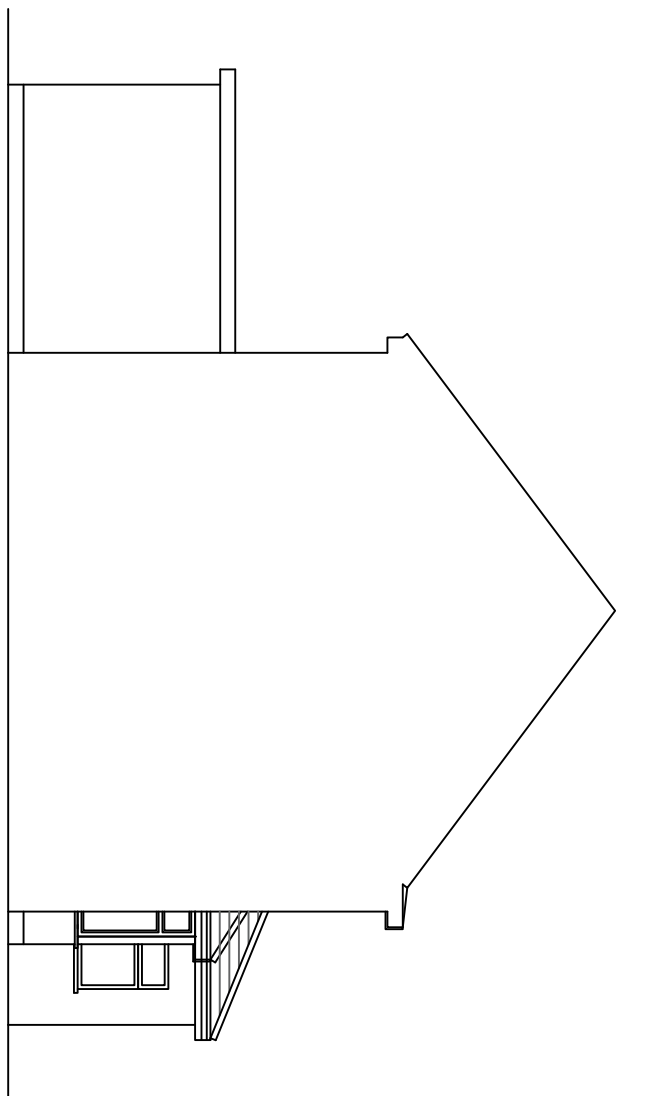

EXISTING LEFT HAND SIDE ELEVATION 1:100 SCALE

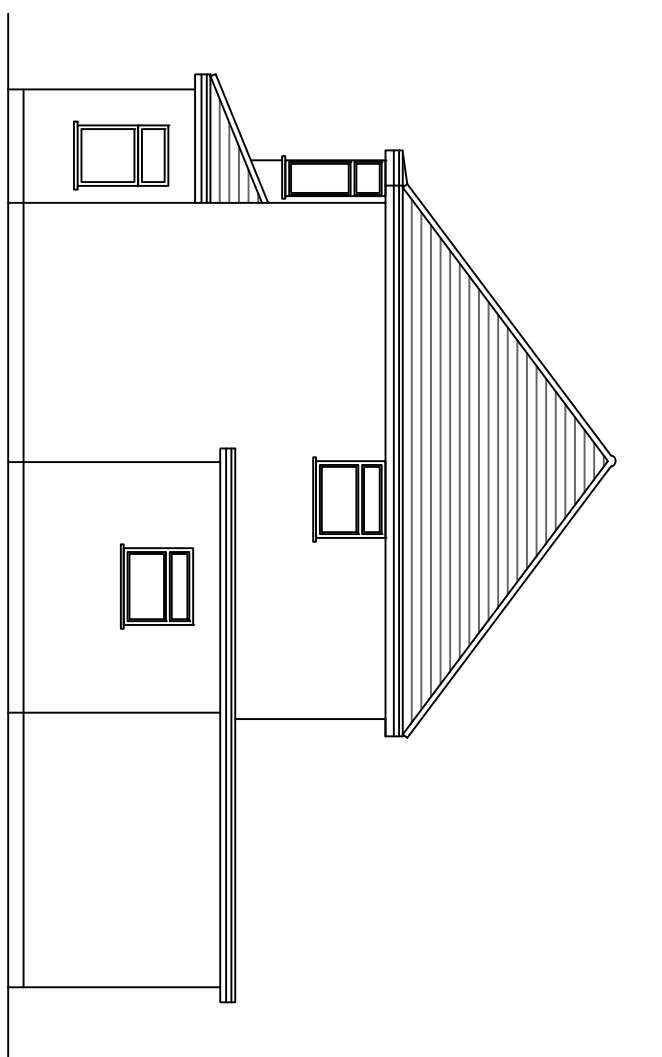

EXISTING RIGHT HAND SIDE ELEVATION 1:100 SCALE

HIP TO GABLE CONVERSION VOLUME

$\frac{1}{2} ((7.286 \times 2.756) / 2) \times 3.620 = 12.115m^3$


DORMER VOLUME

$(3.292 \times 2.415) / 2 = 3.975m^3$


$3.975 \times 5.389 = 21.421m^3$

TOTAL VOLUME


$12.115 + 21.421 = 33.536m^3$

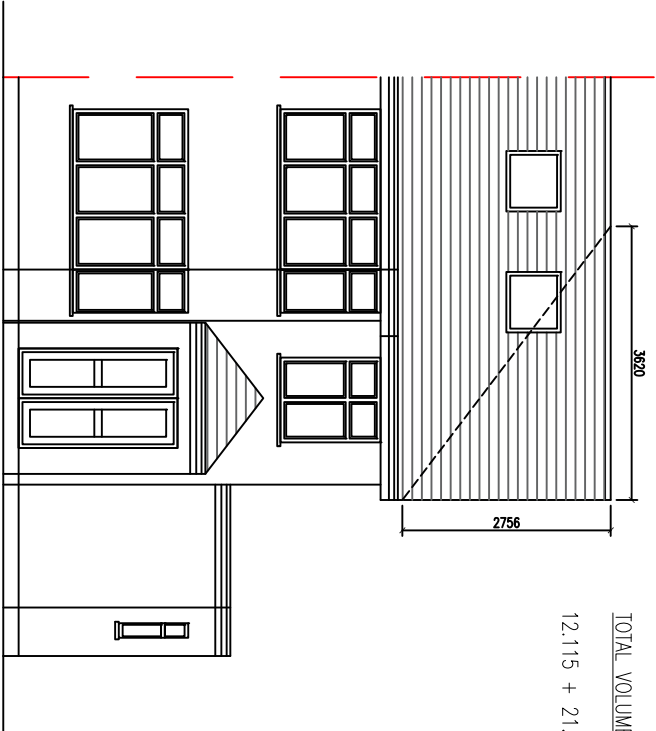


PROPOSED FRONT ELEVATION 1:100 SCALE

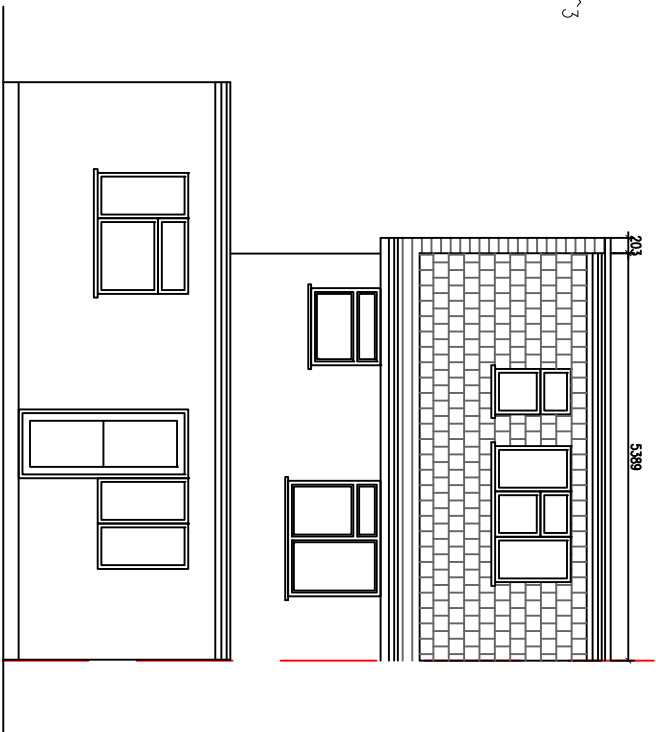

PROPOSED REAR ELEVATION 1:100 SCALE

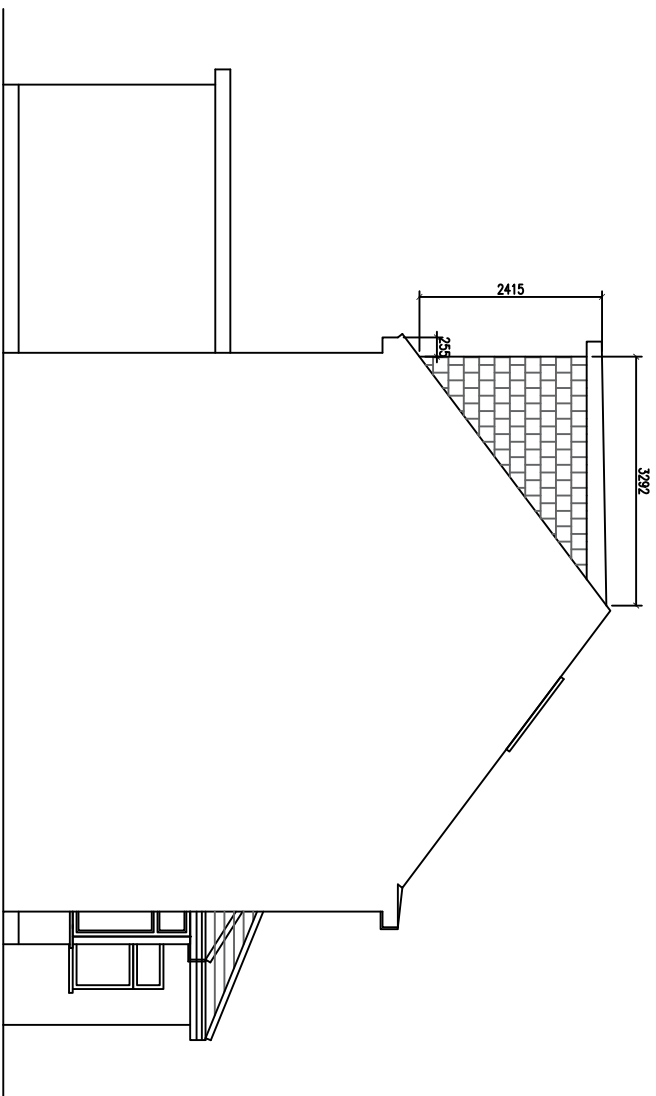

PROPOSED LEFT SIDE ELEVATION 1:100 SCALE

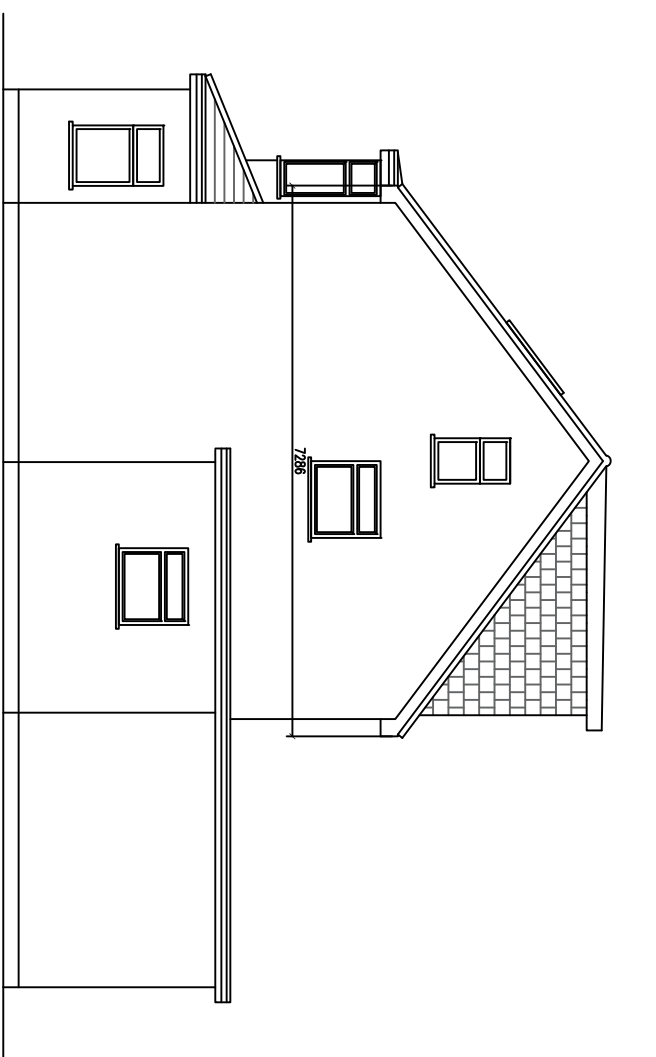

PROPOSED RIGHT SIDE ELEVATION 1:100 SCALE

DESCRIPTION:

PROPOSED LOFT CONVERSION WITH
REAR DORMER FRONT SKYLIGHTS AND
HIP TO GABLE CONVERSION

CLIENT: MR SANDEEP JOHAL

SITE ADDRESS:

18 SWANAGE WAYE

HAYES


UB4 0NY

SCALE: 1:100 @A1

DRAWING NUMBER: PDASB/1

DATE: MAR 2024

REVISIONS:

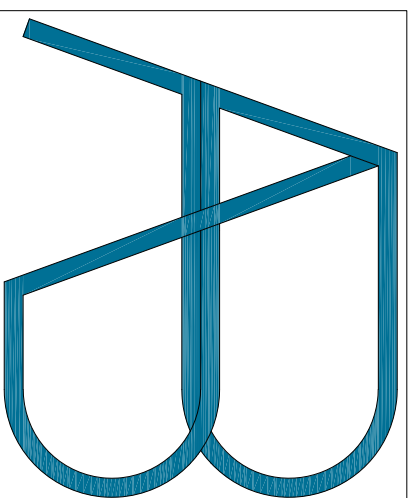

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DISCLAIMER:
THESE DRAWING SHOULD BE APPROVED
BY LOCAL AUTHORITY OR APPROVED
INSPECTOR BEFORE WORK CAN START.

DO NOT SCALE FROM DRAWING
MEASUREMENTS TO BE TAKEN ON SITE.

PARTY WALL(ECT) ACT 1997 TO BE
AGREED WITH ADJOINING NEIGHBORS BY
CLIENT BEFORE COMMENCING WORKS.

ALL WORKS INCLUDING FOUNDATIONS,
WASTE LINES, ETC. ARE TO BE WITH IN
BOUNDARY LINES OF SITE.

1:100 scale bar

