



Scale 1:100

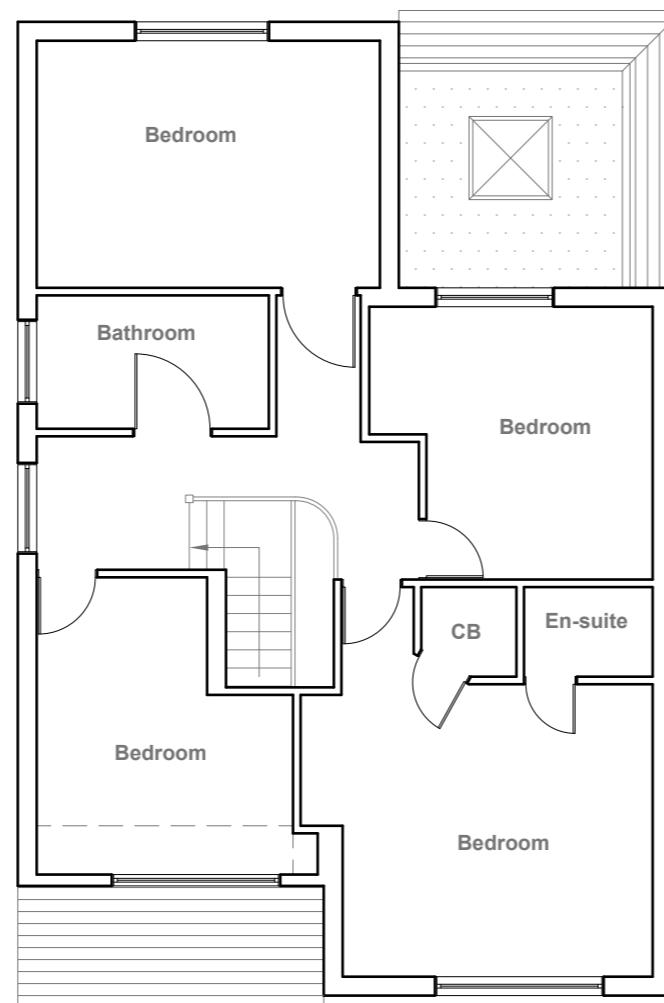

Scale 1:100

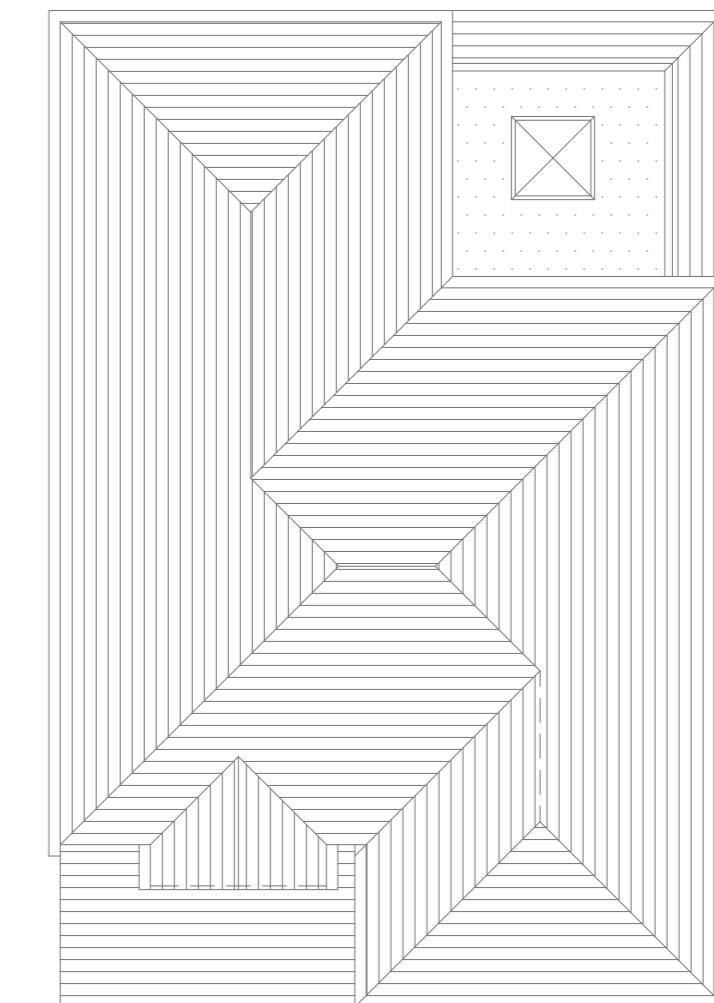

Scale 1:100

10 Meter
5
2
1
0
1:100

GENERAL NOTES:
 1. ALL DIMENSIONS ARE IN MILLIMETER.
 2. VERIFY ALL DIMENSIONS AND CONDITIONS BEFORE BUILDING OR
 STARTING CONSTRUCTION. NOTIFY THE DESIGNER IMMEDIATELY OF ANY
 DISCREPANCY OR VARIATION.
 3. ALL WORK TO COMPLY WITH CURRENT BUILDING REGULATIONS
 AND CODES OF PRACTICE

Title:

Existing Floor Plans

Site Address
92 Evelyn Avenue,
Ruislip.
HA4 8AJ

Scale: 1:100 @A3
Date: 24/05/2024
Drawing No.:
2024/085 -01
Drawn By:
RO

Revision Date:


e:mail -
faluckpatel@yahoo.com
(M) +44 (0) 7871 466 254

**Faluck
Patel**



Existing Front Elevation

Scale 1:100

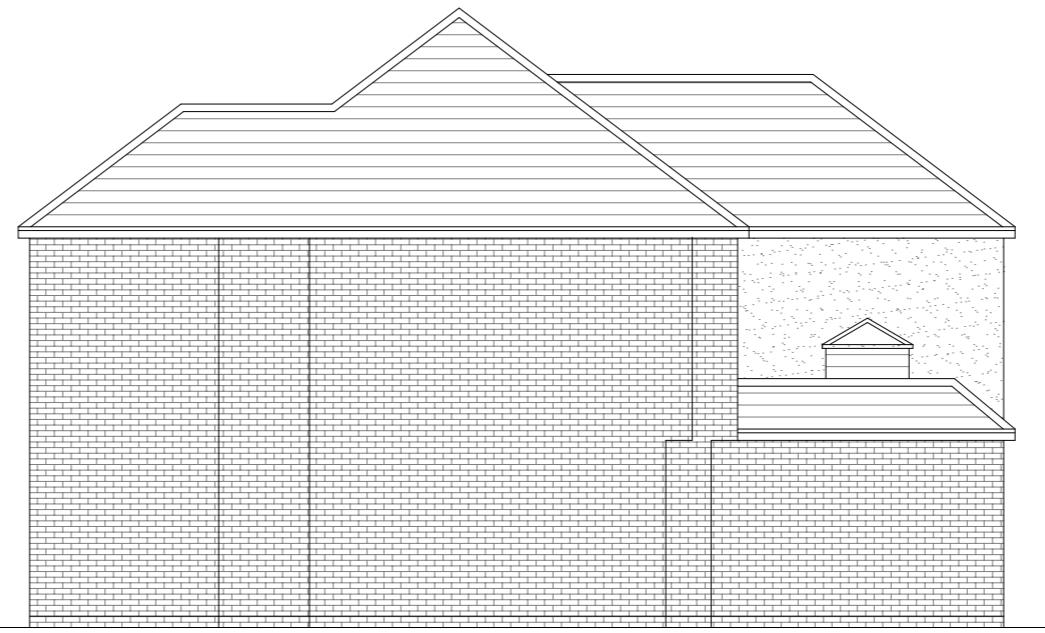

Existing Side Elevation

Scale 1:100



Existing Rear Elevation

Scale 1:100



Existing Side Elevation

Scale 1:100

10 Meter
5
2
1
0
1:100

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Title:

Existing Elevations


Site Address
92 Evelyn Avenue,
Ruislip.
HA4 8AJ

Scale: 1:100 @A3
Date: 24/05/2024
Drawing No.:
2024/085 -02
Drawn By:
RO

Revision Date:


e:mail -
faluckpatel@yahoo.com
(M) +44 (0) 7871 466 254

**Faluck
Patel**

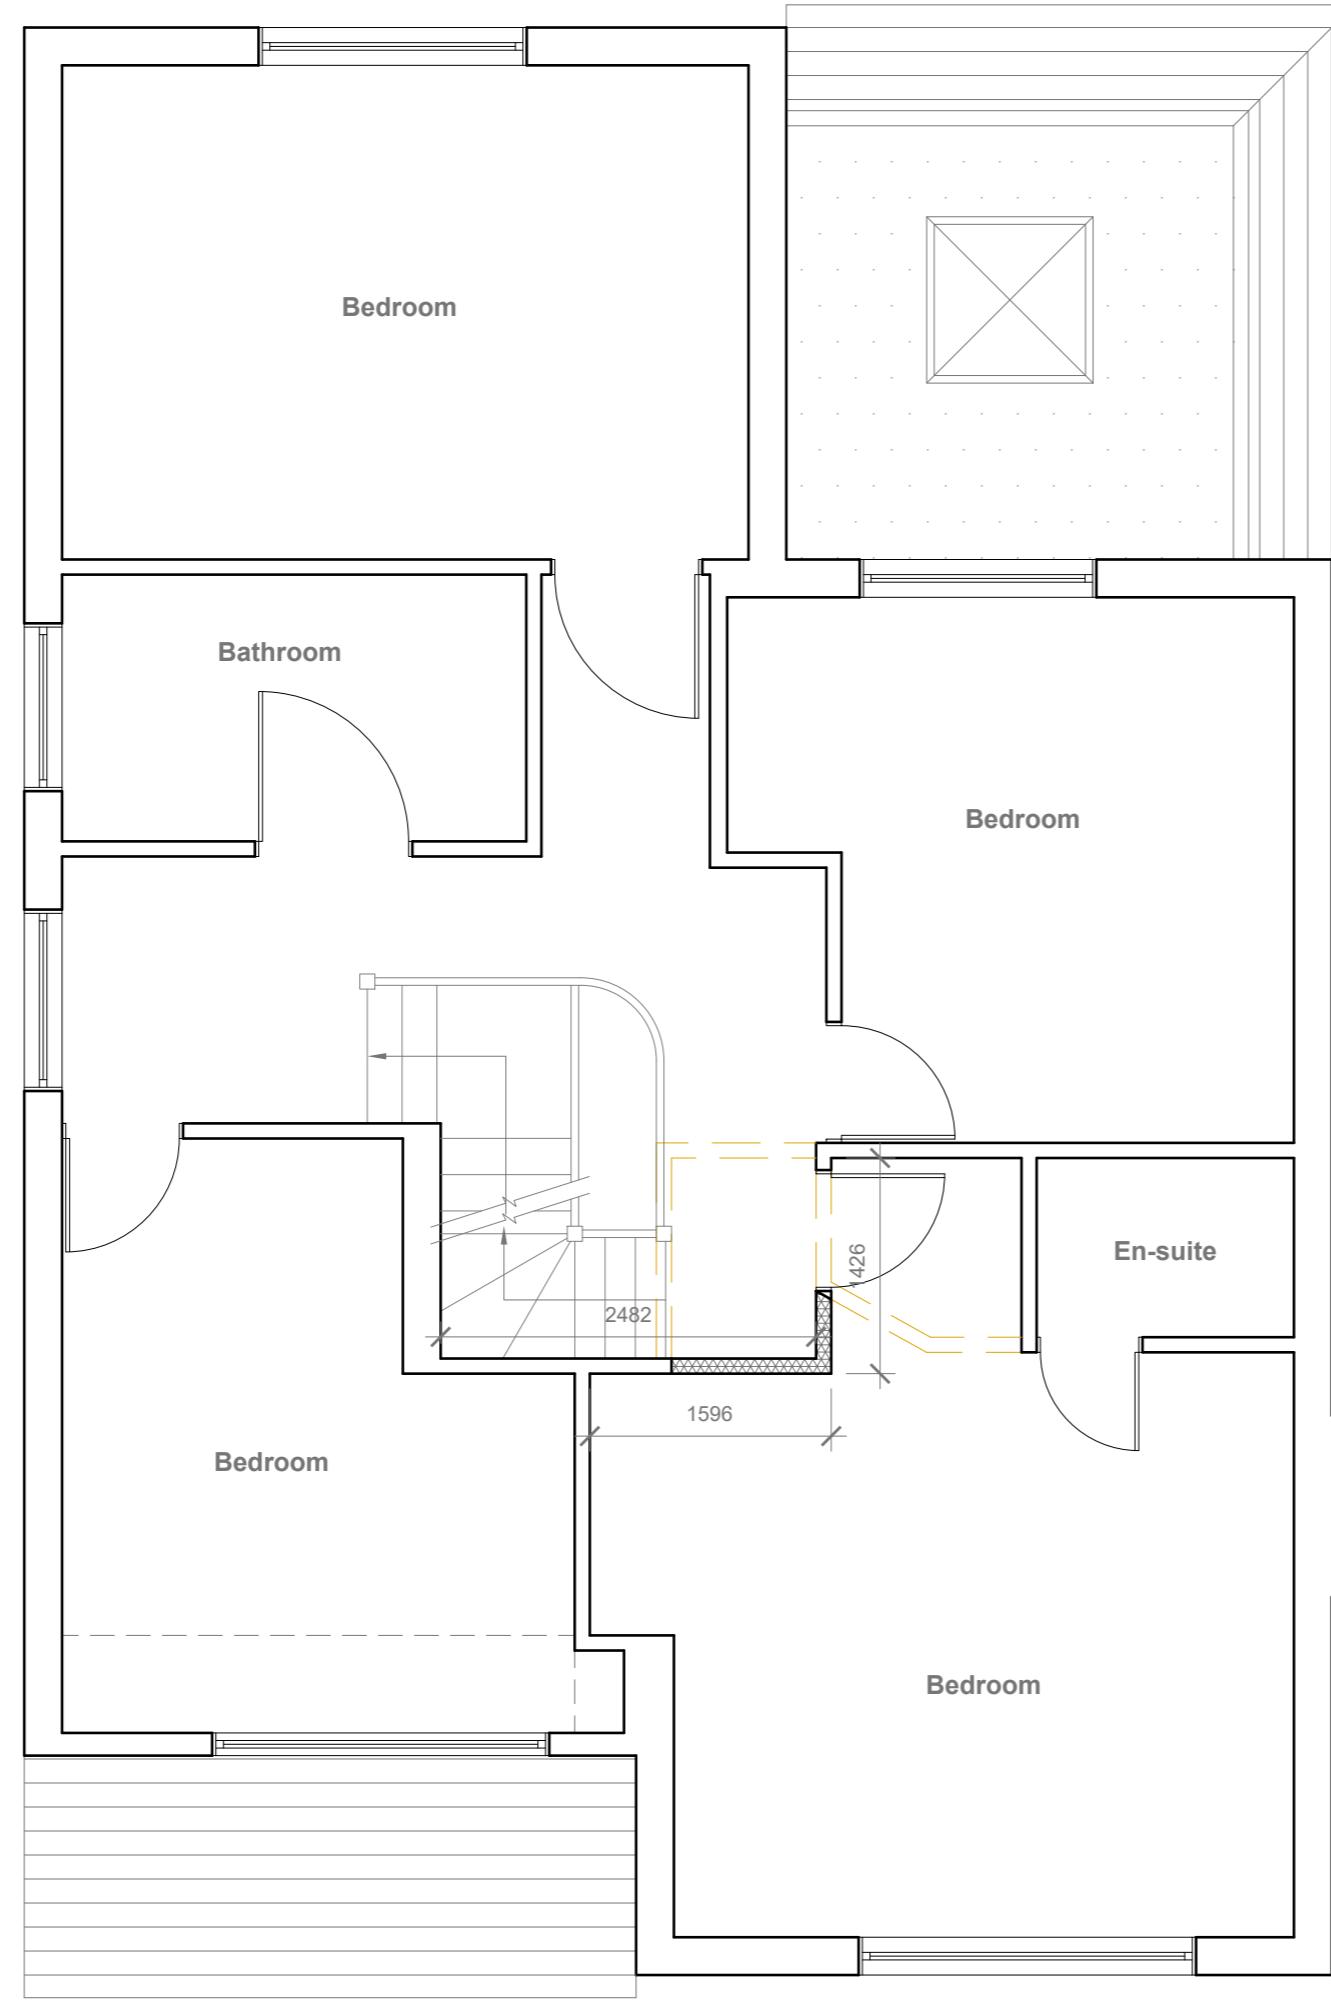

GENERAL NOTES:


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Title:

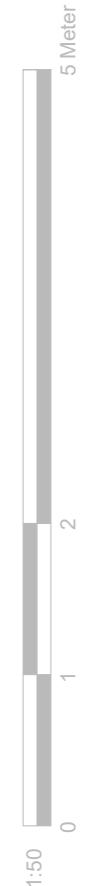
Proposed First Floor Plan

Site Address	Scale: 1:50 @A3
92 Evelyn Avenue, Ruislip. HA4 8AJ	Date: 24/05/2024
	Drawing No.: 2024/085 -03
	Drawn By: RO
Revision Date:	
e:mail -	faluckpatel@yahoo.com
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Title:


Proposed Loft Plan

Site Address	Scale: 1:50 @A3
92 Evelyn Avenue, Ruislip. HA4 8AJ	Date: 24/05/2024
	Drawing No.: 2024/085 -04
	Drawn By: RO
Revision Date:	
e:mail -	faluckpatel@yahoo.com
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Proposed Front Elevation

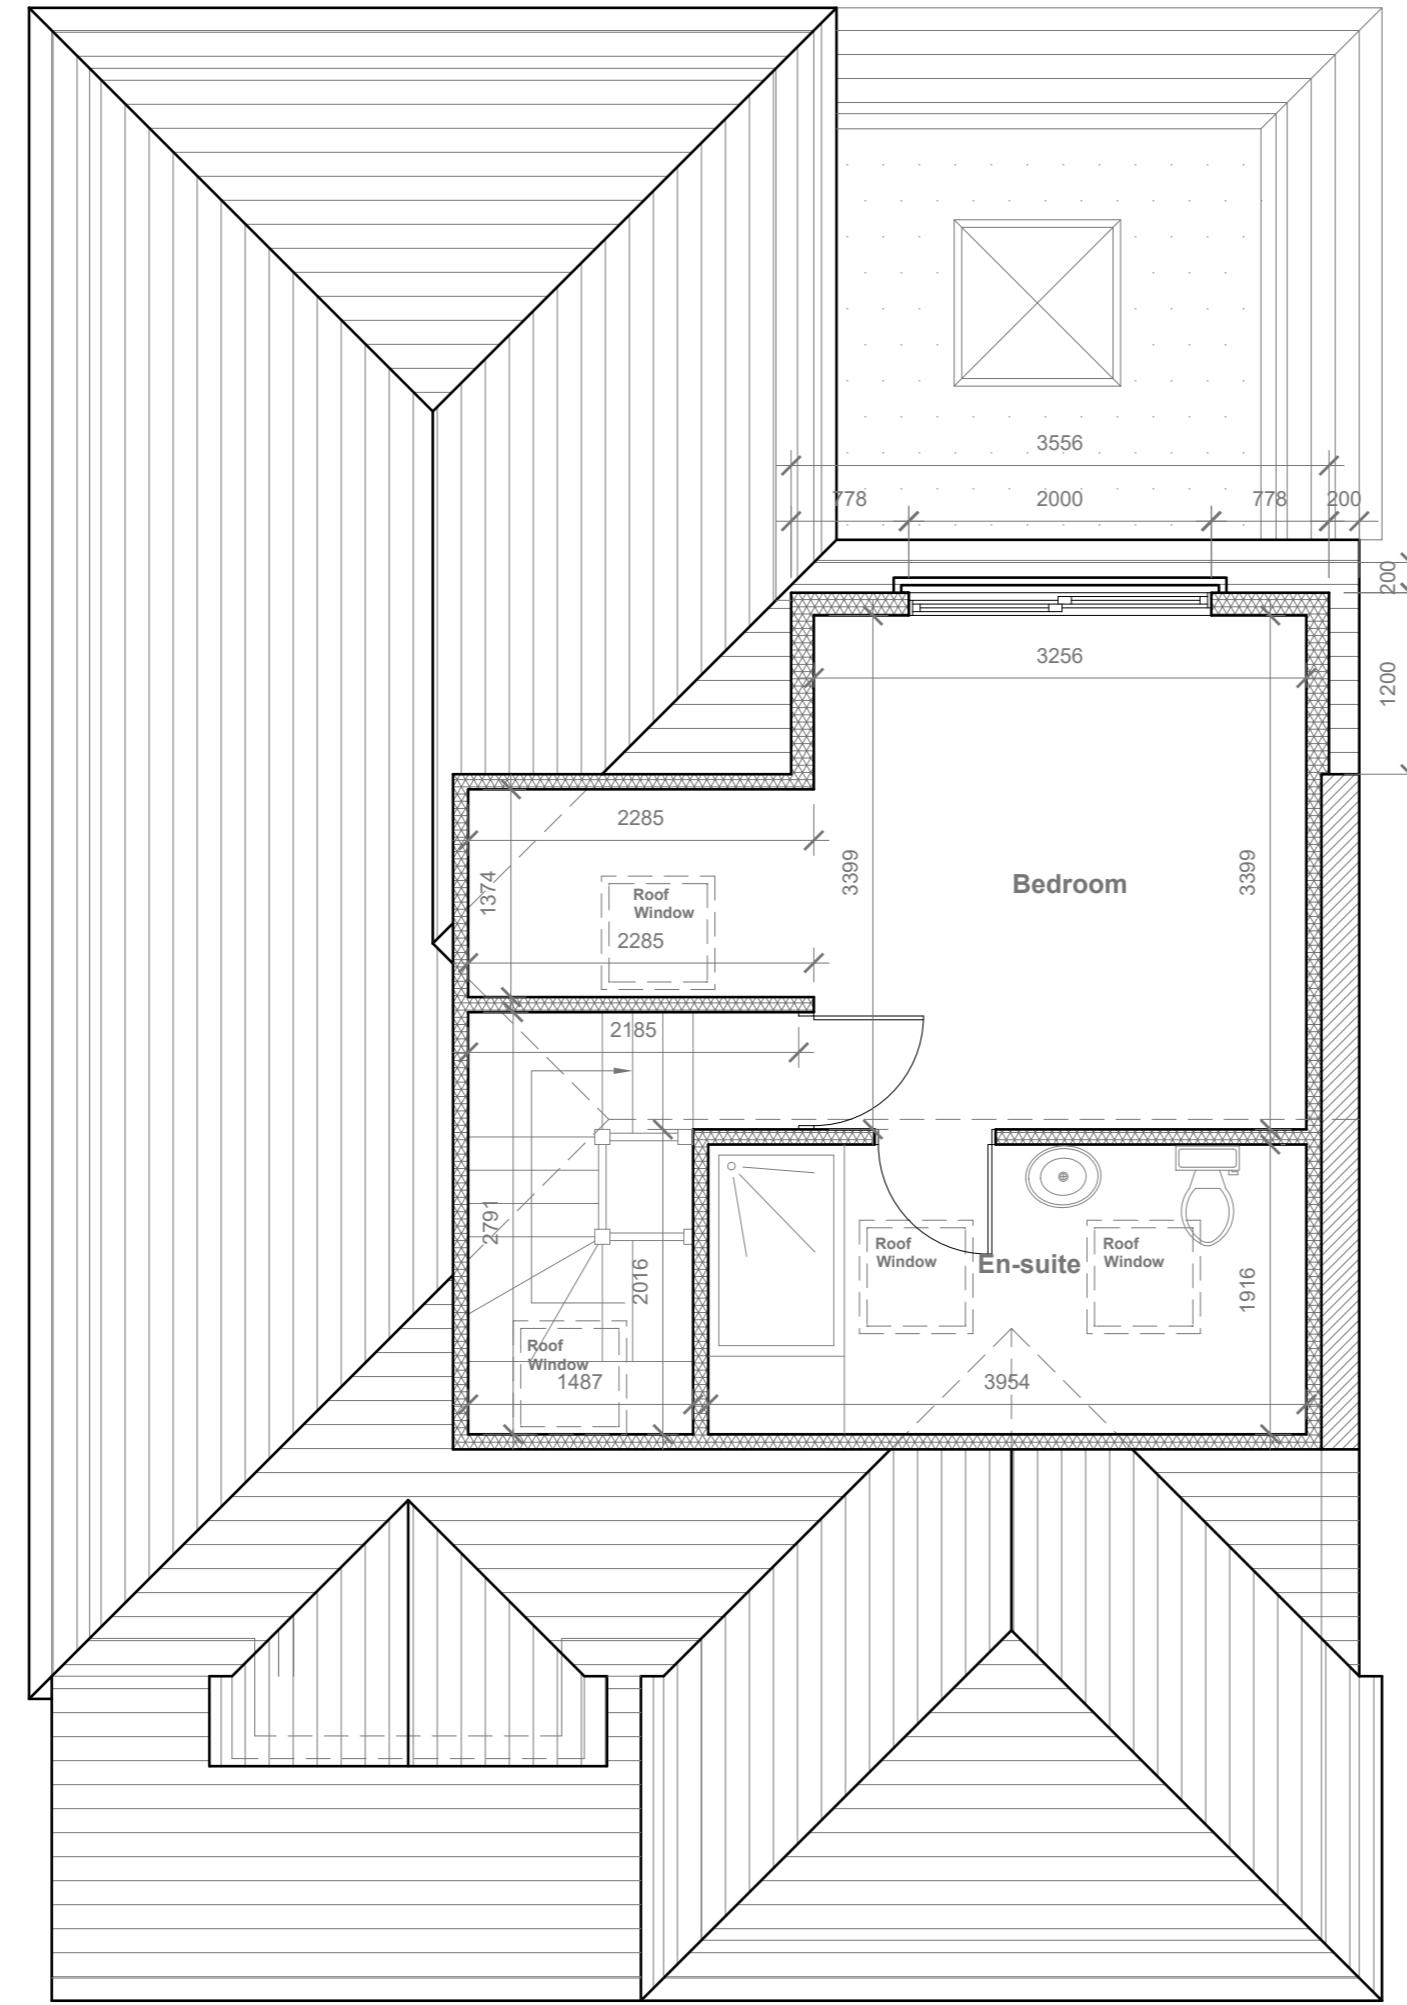Scale 1:100

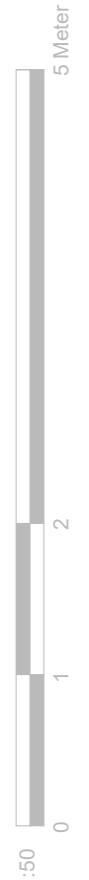

Proposed Side Elevation

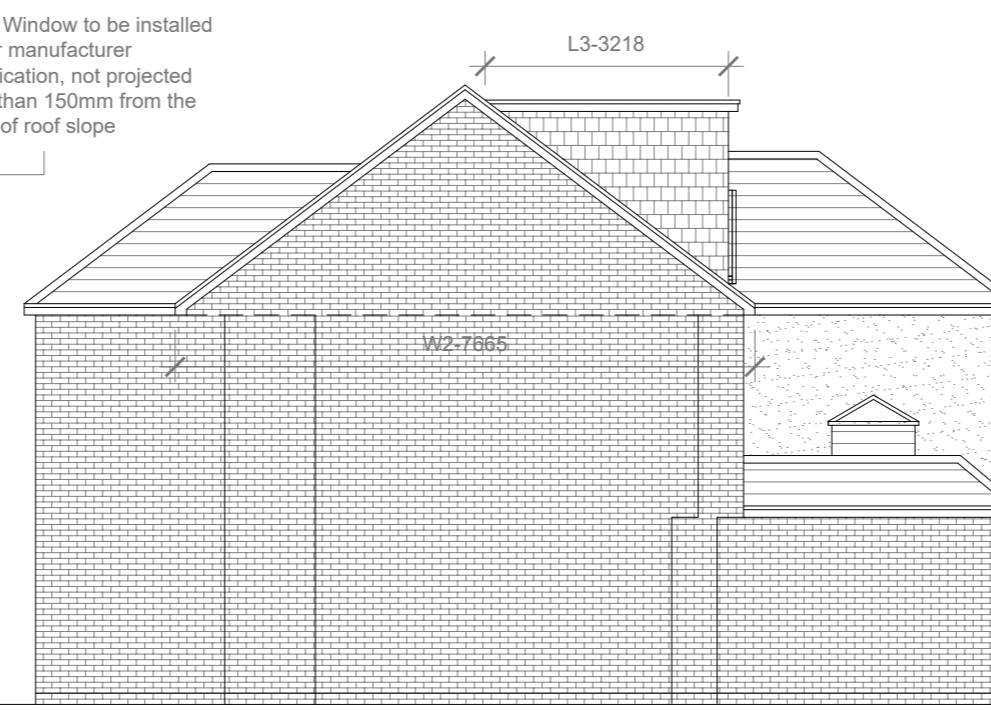Scale 1:100



Proposed Rear Elevation

Scale 1:100



Proposed Side Elevation

Scale 1:100

FRONT WINDOW = ROOF VOLUME	$W \times H \times L / 6$ 2.629 X 1.245 X 2.085 / 6 6.82 / 6 V = 1.13 CU.MT.
REAR PITCH ROOF = V1 =	$W1 \times H1 \times L1 / 2$ 5.338 X 2.165 X 3.513 / 2 40.59 / 2 20.25 CU.MT.
HIP TO GABLE ROOF VOLUME = V2 =	$W2 \times H2 \times L2 / 6$ 7.665 X 3.043 X 3.682 / 6 85.88 / 6 14.31 CU.MT.
REAR DORMER VOLUME = V3 =	$W3 \times H3 \times L3 / 2$ 3.556 X 2.429 X 3.218 / 2 27.79 / 2 13.89 CU.MT.
TOTAL ROOF VOLUME =	$V + V1 + V2 + V3$ 1.13 + 20.25 + 14.31 + 13.89 49.58 CU.MT. < 50.00 CU.MT

Proposed External Finish
Materials to Match Existing
External Finish Materials

Velux Window to be installed
as per manufacturer
specification, not projected
more than 150mm from the
plane of roof slope



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Title:

Proposed Elevations

Site Address	Scale: 1:100 @A3	Revision Date:
92 Evelyn Avenue, Ruislip. HA4 8AJ	Date: 24/05/2024	
	Drawing No.: 2024/085 -05	
	Drawn By:	
	RO	e:mail - faluckpatel@yahoo.com (M) +44 (0) 7871 466 254