



Existing Ground Floor Plan
Scale 1:100

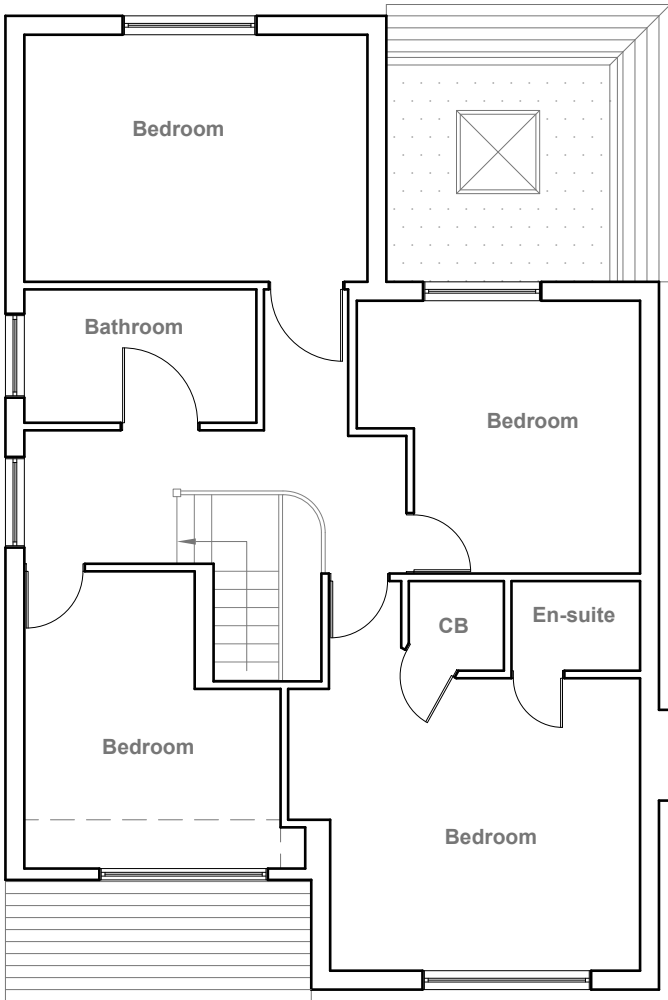

Existing First Floor Plan
Scale 1:100

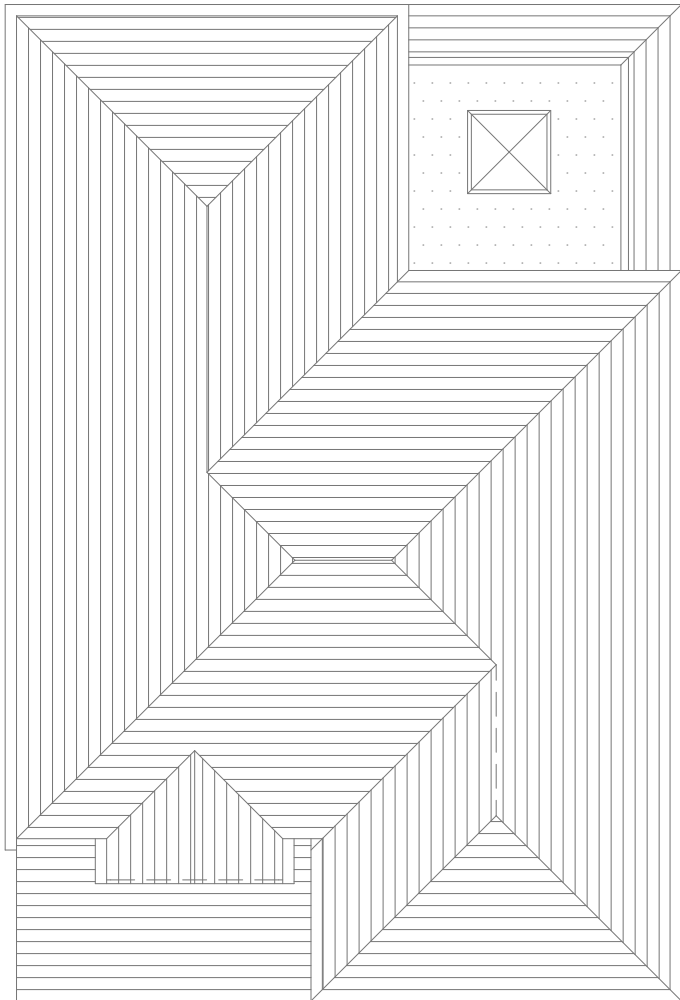

Existing Roof Floor Plan
Scale 1:100



GENERAL NOTES:
1. ALL DIMENSIONS ARE IN MILLIMETER.
2. VERIFY ALL DIMENSIONS AND CONDITIONS BEFORE BUILDING OR STARTING CONSTRUCTION. NOTIFY THE DESIGNER IMMEDIATELY OF ANY DISCREPANCY OR VARIATION.
3. ALL WORK TO COMPLY WITH CURRENT BUILDING REGULATIONS AND CODES OF PRACTICE

Title:


Existing Floor Plans

Site Address	Scale: 1:100 @A3	Revision Date:
92 Evelyn Avenue, Ruislip. HA4 8AJ	Date: 24/05/2024	
	Drawing No.: 2024/085 -01	
	Drawn By: RO	e:mail - faluckpatel@yahoo.com (M) +44 (0) 7871 466 254





Existing Front Elevation
Scale 1:100

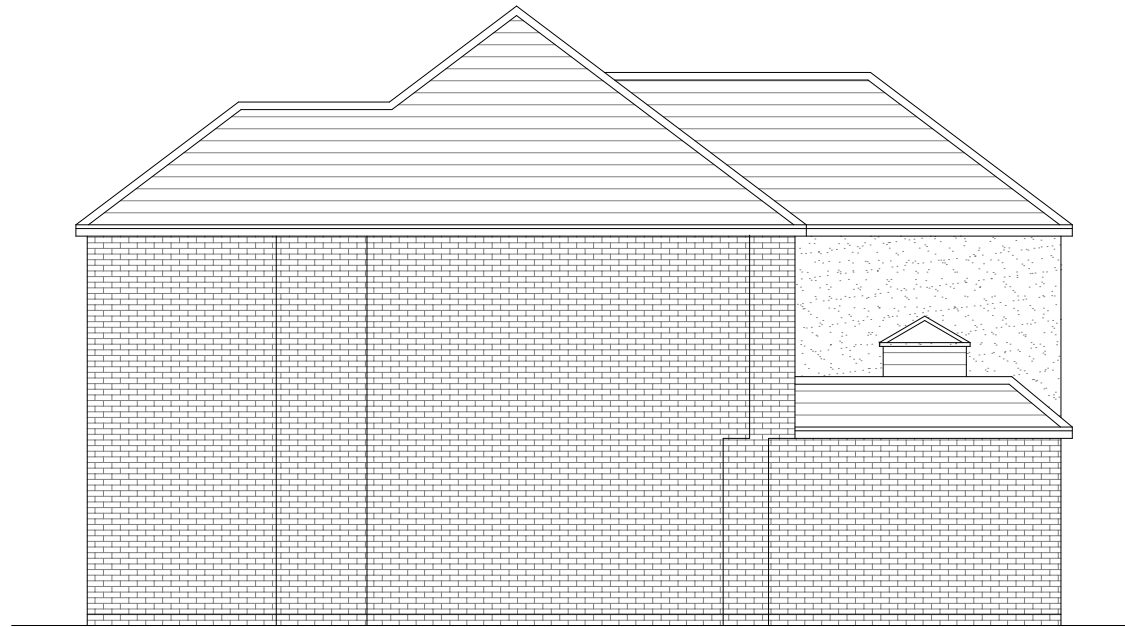

Existing Side Elevation
Scale 1:100



Existing Rear Elevation
Scale 1:100



Existing Side Elevation
Scale 1:100



GENERAL NOTES:
1. ALL DIMENSIONS ARE IN MILLIMETER.
2. VERIFY ALL DIMENSIONS AND CONDITIONS BEFORE BUILDING OR STARTING CONSTRUCTION. NOTIFY THE DESIGNER IMMEDIATELY OF ANY DISCREPANCY OR VARIATION.
3. ALL WORK TO COMPLY WITH CURRENT BUILDING REGULATIONS AND CODES OF PRACTICE

Title:


Existing Elevations

Site Address
92 Evelyn Avenue,
Ruislip,
HA4 8AJ

Scale: 1:100 @A3
Date: 24/05/2024
Drawing No.:
2024/085 -02
Drawn By:
RO

Revision Date:
e:mail -
faluckpatel@yahoo.com
(M) +44 (0) 7871 466 254

**Faluck
Patel**

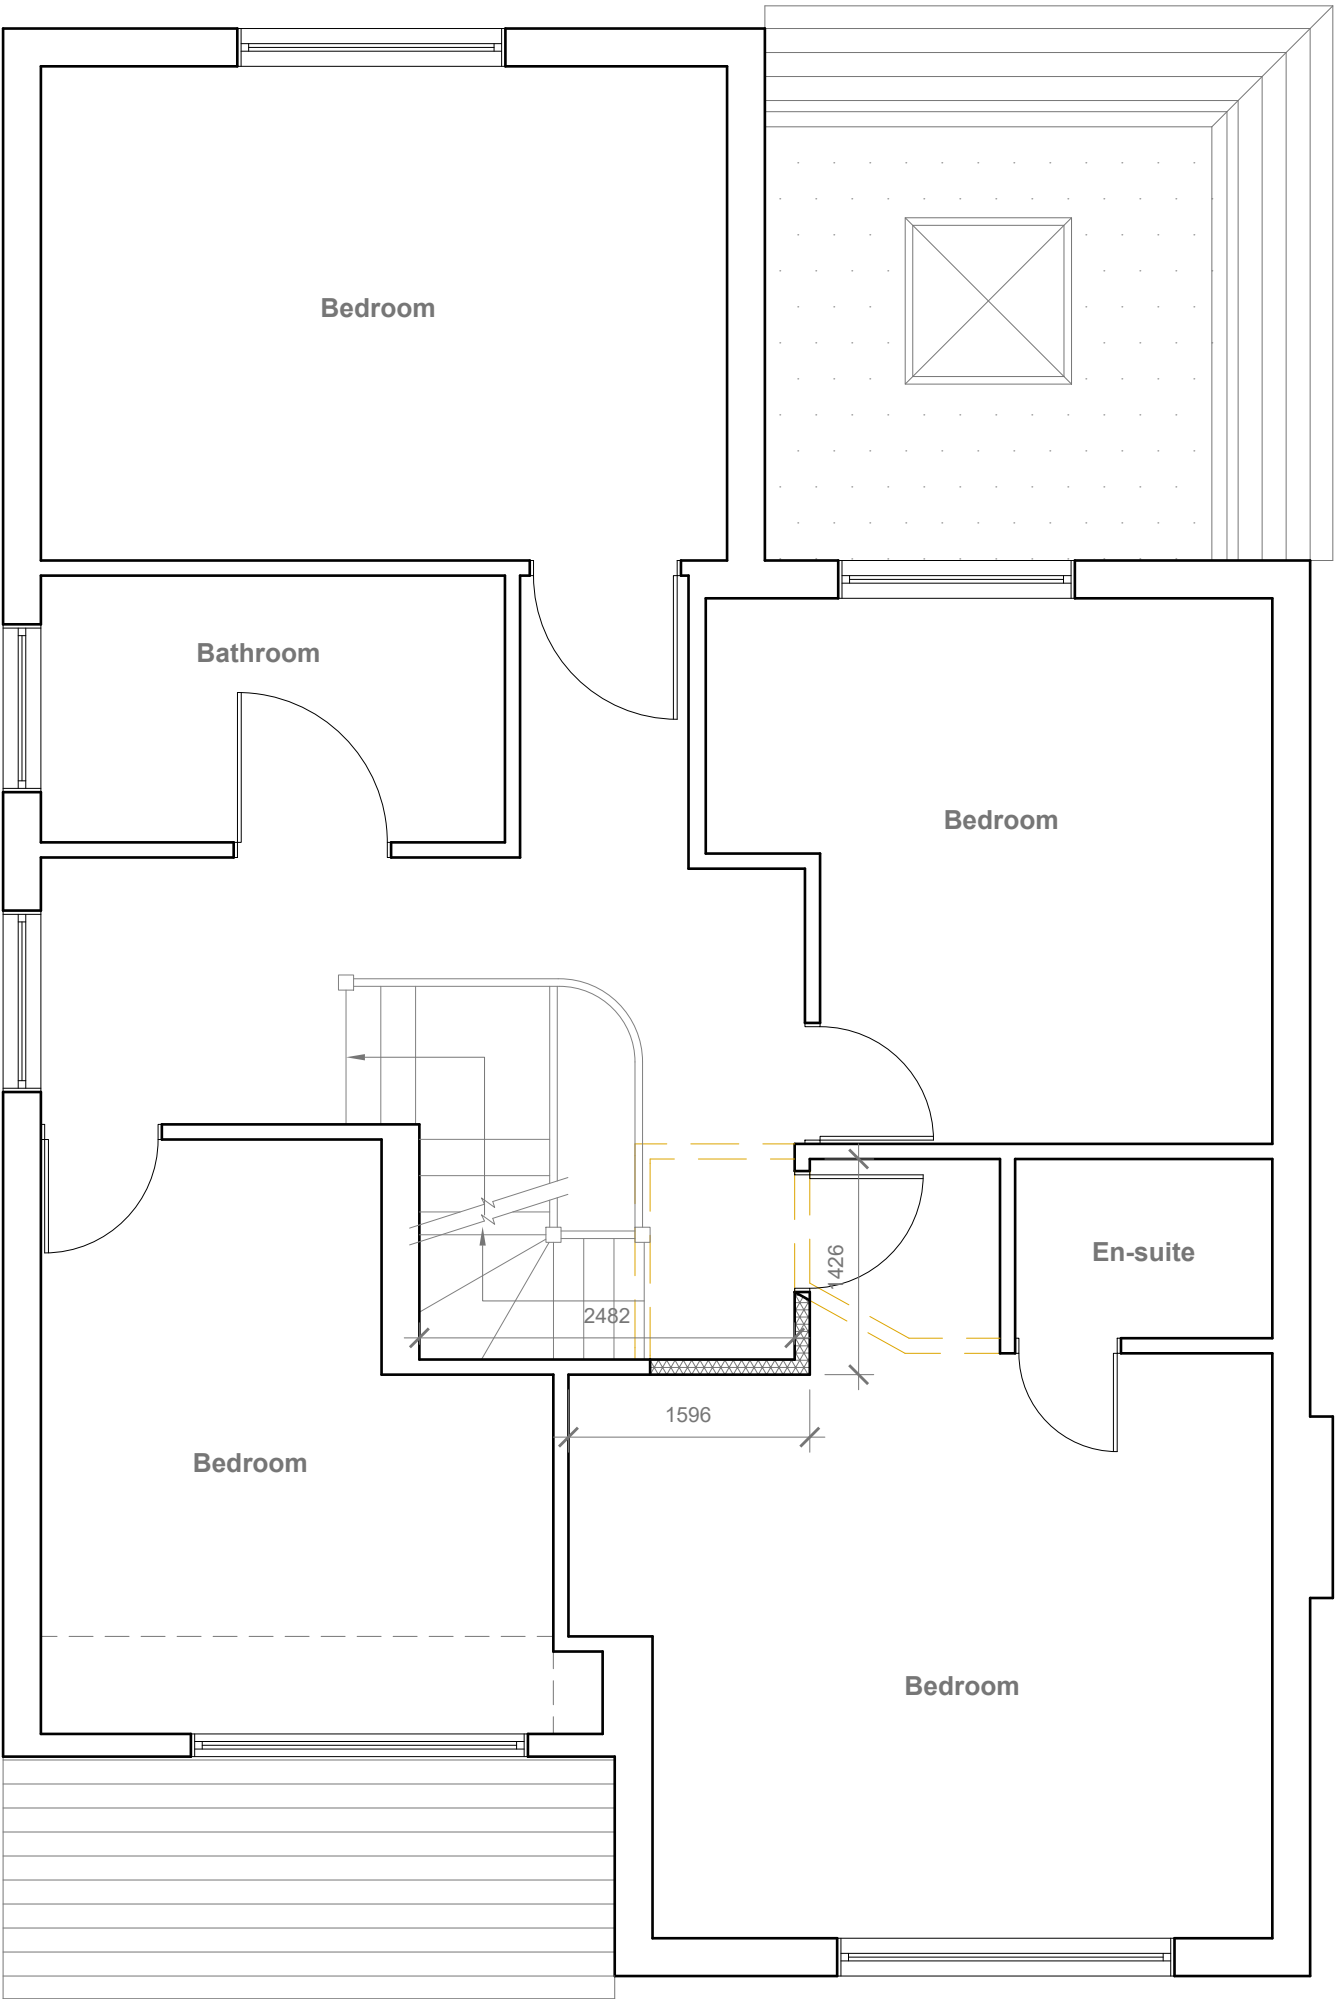

Proposed First Floor Plan
Scale 1:50

- GENERAL NOTES:
1. ALL DIMENSIONS ARE IN MILLIMETER.
 2. VERIFY ALL DIMENSIONS AND CONDITIONS BEFORE BUILDING OR STARTING CONSTRUCTION. NOTIFY THE DESIGNER IMMEDIATELY OF ANY DISCREPANCY OR VARIATION.
 3. ALL WORK TO COMPLY WITH CURRENT BUILDING REGULATIONS AND CODES OF PRACTICE.




Title:

Proposed First Floor Plan

Site Address	Scale: 1:50 @A3
92 Evelyn Avenue, Ruislip. HA4 8AJ	Date: 24/05/2024
	Drawing No.: 2024/085 -03
	Drawn By: RO

Revision Date:	Faluck Patel
e:mail - faluckpatel@yahoo.com (M) +44 (0) 7871 466 254	

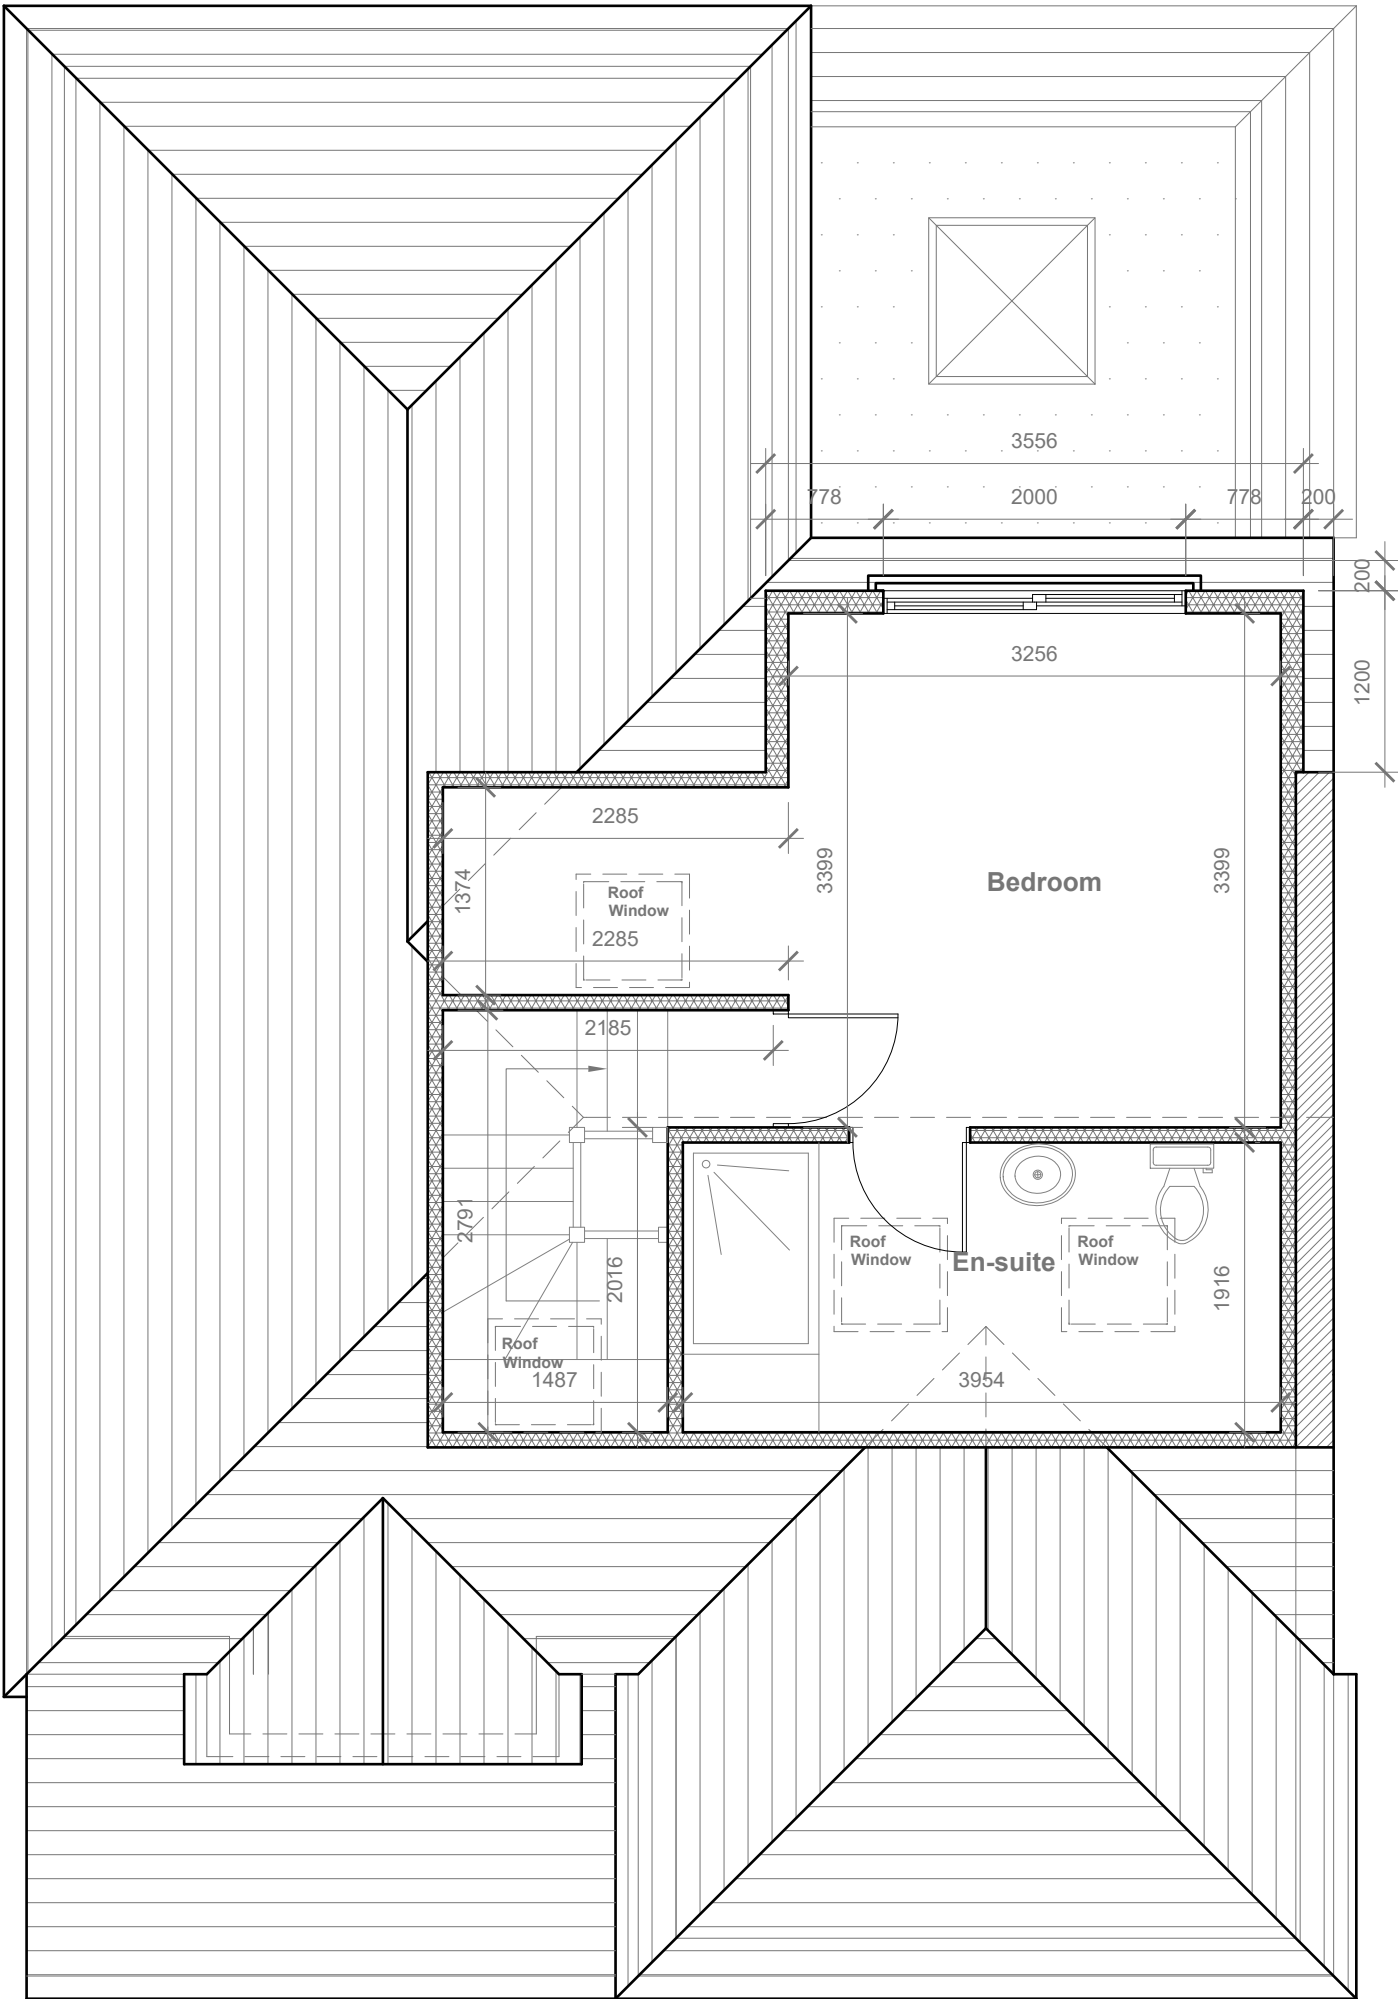

Proposed Loft Floor Plan
Scale 1:50

- GENERAL NOTES:
1. ALL DIMENSIONS ARE IN MILLIMETER.
 2. VERIFY ALL DIMENSIONS AND CONDITIONS BEFORE BUILDING OR STARTING CONSTRUCTION. NOTIFY THE DESIGNER IMMEDIATELY OF ANY DISCREPANCY OR VARIATION.
 3. ALL WORK TO COMPLY WITH CURRENT BUILDING REGULATIONS AND CODES OF PRACTICE.



Title:


Proposed Loft Plan

Site Address	Scale: 1:50 @A3
92 Evelyn Avenue, Ruislip. HA4 8AJ	Date: 24/05/2024
	Drawing No.: 2024/085 -04
	Drawn By: RO

Revision Date:	Faluck Patel
e:mail - faluckpatel@yahoo.com (M) +44 (0) 7871 466 254	



Proposed Front Elevation
Scale 1:100

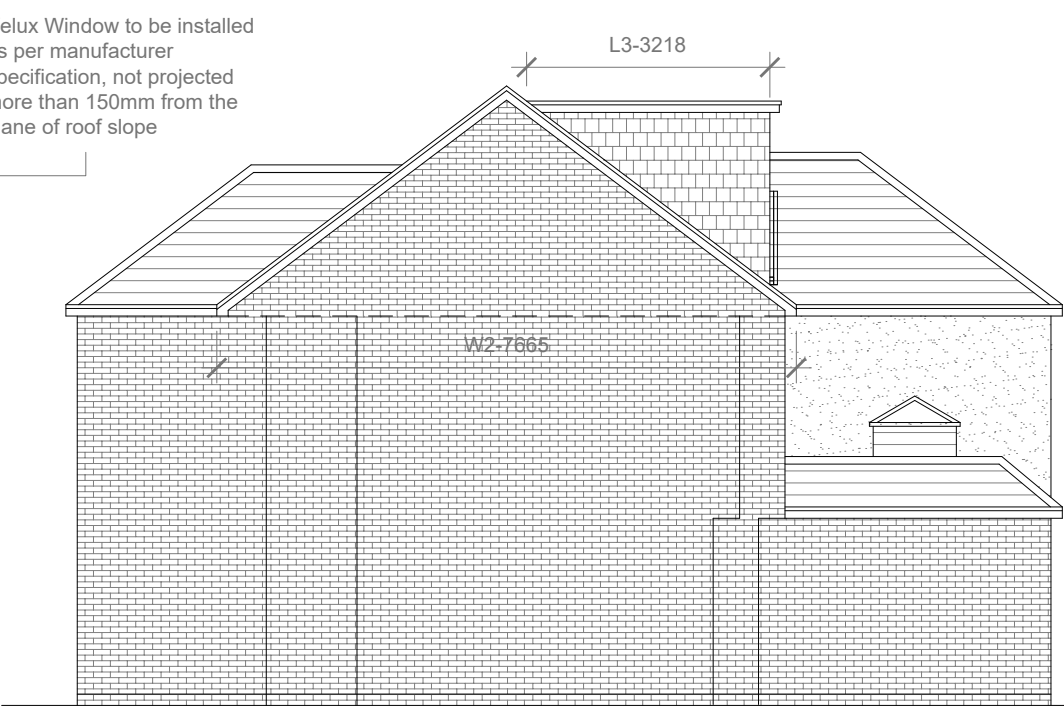

Proposed Side Elevation
Scale 1:100



Proposed Rear Elevation
Scale 1:100



Proposed Side Elevation
Scale 1:100

FRONT WINDOW = $W \times H \times L / 6$
ROOF VOLUME = $2.629 \times 1.245 \times 2.085 / 6$
 $V = 6.82 / 6$
 $V = 1.13 \text{ CU.MT.}$

REAR PITCH ROOF = $W1 \times H1 \times L1 / 2$
 $5.338 \times 2.165 \times 3.513 / 2$
 $V1 = 40.59 / 2$
 $V1 = 20.25 \text{ CU.MT.}$

HIP TO GABLE ROOF VOLUME = $W2 \times H2 \times L2 / 6$
 $7.665 \times 3.043 \times 3.682 / 6$
 $V2 = 85.88 / 6$
 $V2 = 14.31 \text{ CU.MT.}$

REAR DORMER VOLUME = $W3 \times H3 \times L3 / 2$
 $3.556 \times 2.429 \times 3.218 / 2$
 $V3 = 27.79 / 2$
 $V3 = 13.89 \text{ CU.MT.}$

TOTAL ROOF VOLUME = $V + V1 + V2 + V3$
 $1.13 + 20.25 + 14.31 + 13.89$
 $49.58 \text{ CU.MT.} < 50.00 \text{ CU.MT}$

Proposed External Finish
Materials to Match Existing
External Finish Materials

Velux Window to be installed
as per manufacturer
specification, not projected
more than 150mm from the
plane of roof slope



- GENERAL NOTES:
- 1. ALL DIMENSIONS ARE IN MILLIMETER.
 - 2. VERIFY ALL DIMENSIONS AND CONDITIONS BEFORE BUILDING OR STARTING CONSTRUCTION. NOTIFY THE DESIGNER IMMEDIATELY OF ANY DISCREPANCY OR VARIATION.
 - 3. ALL WORK TO COMPLY WITH CURRENT BUILDING REGULATIONS AND CODES OF PRACTICE

Title:

Proposed Elevations

Site Address	Scale: 1:100 @A3	Revision Date:
92 Evelyn Avenue, Ruislip. HA4 8AJ	Date: 24/05/2024	
	Drawing No.: 2024/085 -05	
	Drawn By:	e:mail - faluckpatel@yahoo.com (M) +44 (0) 7871 466 254
	RO	

