


NOTES


- Dimensions are not to be scaled from this drawing by contractors. The contractor is requested to check all dimensions before the work started.
- Report any discrepancies to the client or architect before undertaking the work described in the drawings.
- Dimensions are approximate site dimensions and are to be verified by the contractor on site before any fabrication/site works i.e foundations etc occur
- Contractor is responsible for all temporary propping to existing structure



01 - FRONT ELEVATION

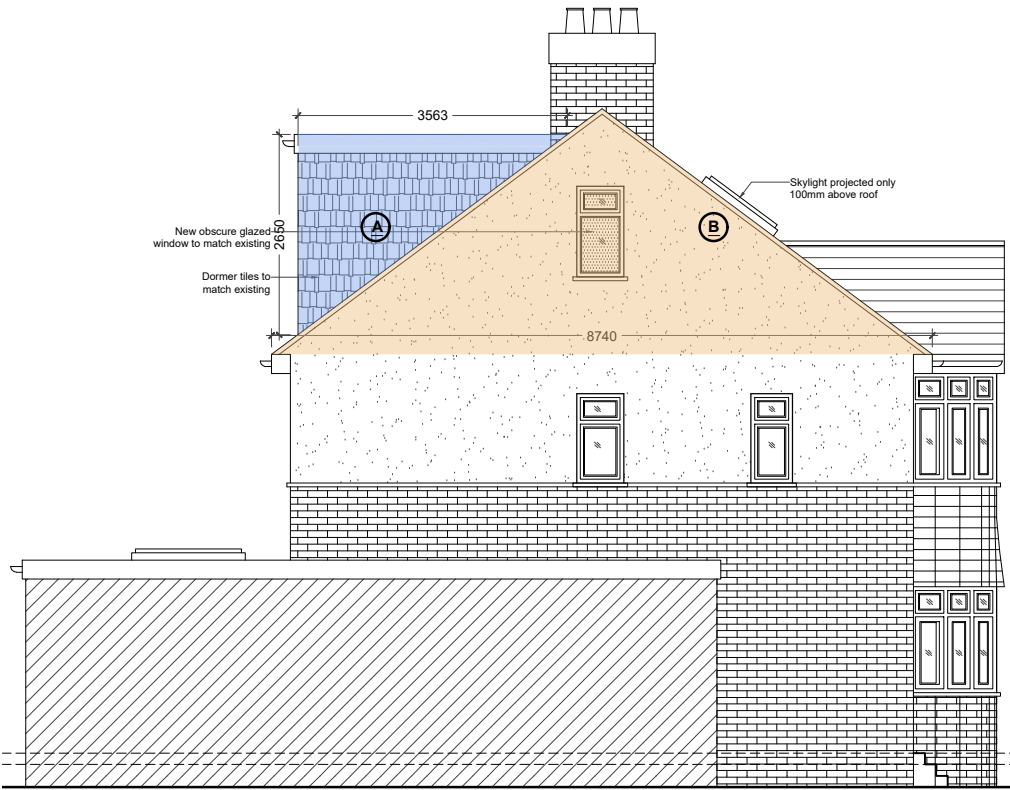

02 - SIDE ELEVATION

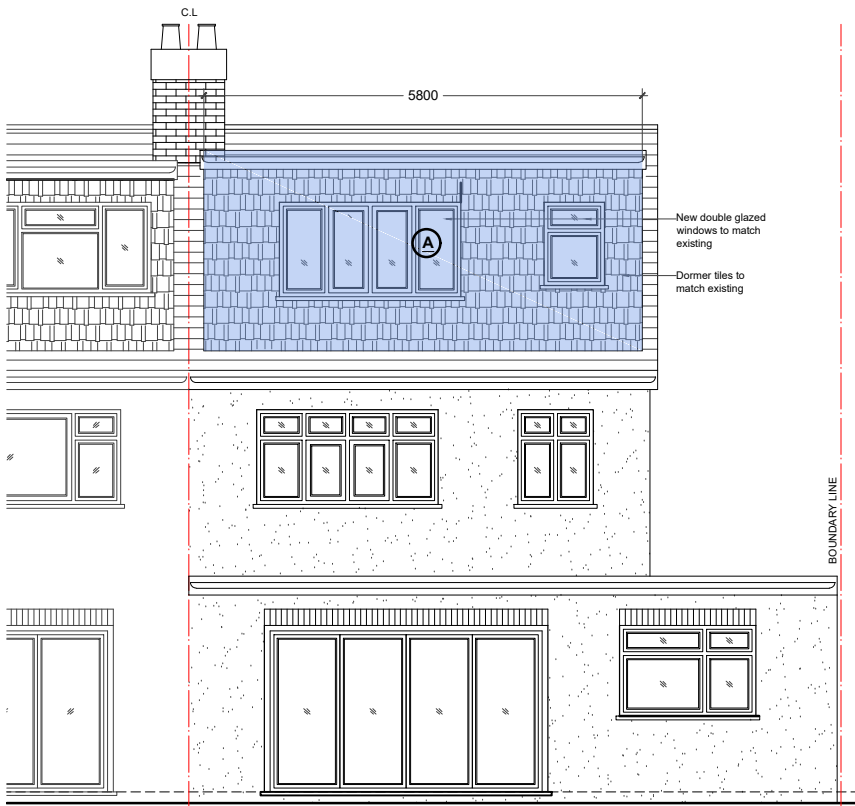

03 - REAR ELEVATION

LOFT VOLUME:

Loft Dormer Volume (A) - $(3.563 \times 5.800 \times 2.65) / 2 = 27.30 \text{ cub.m}$
Hip To Gable (B) - $(5.446 \times 8.740 \times 2.608) / 6 = 20.70 \text{ cub.m}$

Total Volume - Volume A + Volume B = 24.70cub.m + 20.70 cub.m = 48.08 cub.m < 50 cub.m

0 1 2m 3 4 5m
Scale

REVISIONS			
NO.	DESCRIPTION	DATE	BY

**LAWFULNESS
CERTIFICATE**

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Project 15 ARLINGTON DRIVE RUISLIP
LONDON, HA4 7RJ

Title PROPOSED ELEVATIONS

Scale 1:100@A3	Drawn MZ	Approved	Date FEB-25
Job No. DE-1217/25	Drawing No. PD-15AD-05	Rev. -	