





Ground Floor

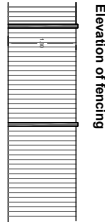


Elevation of fencing


Photo Sample of fencing

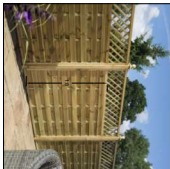

Existing Paving Area to be retained
Photo Sample of Paving

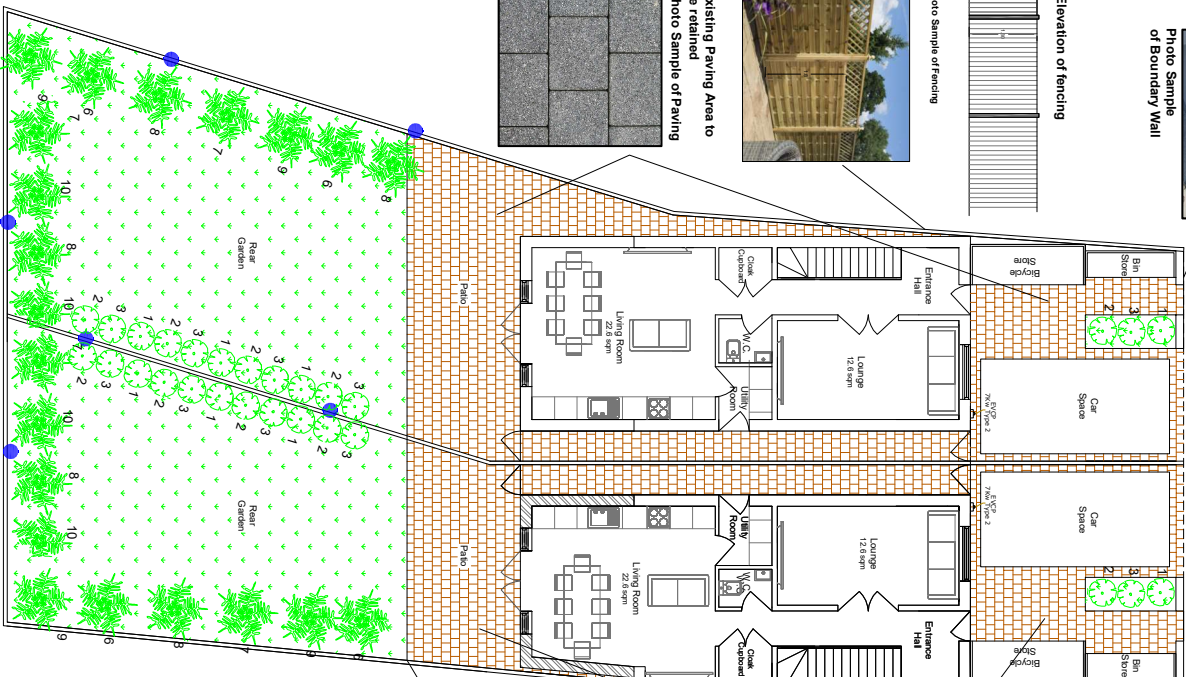


Existing Paving Area to be retained
Photo Sample of Paving

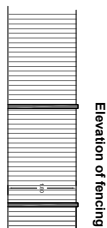

Elevation of fencing

Photo Sample of fencing

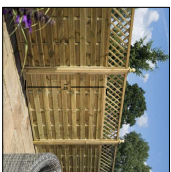

Key

1. 1.8m Pyracantha Orange Glow
2. 1.8m Pyracantha Saphyr Yellow
3. 1.8m Pyracantha Red Firethorn
4. Clematis Alpha Frankie
5. Clematis Alpha Ruby
6. Clematis Alpha Blue Dancer
7. Clematis Cirrhose var. balearica
8. Rosa Shropshire Red
9. Rosa Teasing Georgia
10. Carpinus betulus 'Fastigiata' Tree

Elevation of Bicycle Storage


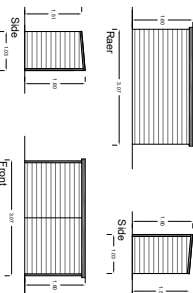


Photo Sample of Bicycle Store



Elevation of Bin Storage

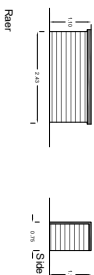

Rear

Side



Photo Sample of Bin Store



**OHME ePod Smart EV Charger 7kW
Unithetherd**

Catalogue Code: 435236081
MPN : OTHMEEP0D
50+ Available to dispatch
immediately

Ohme was created with the aim of being the world's most trusted smart charging platform. Their EV chargers are designed to maximise savings by operating when electricity prices are at their lowest.

The Ohme ePod is a 7kW Unithetherd EV Charger, which is ideal for residential applications. Residential can be used with a single phase touch sensitive buttons on the front of the unit, or via the trusted app. This means charging can be scheduled in line with dynamic energy tariffs or forecasts of the carbon intensity of electricity generation.

The ePod has a stylish, compact design and features in-built earthing for hassle-free installation. The unit is compatible with all types of electric vehicles and is compliant with the new Smart Charger Regulations.

PRODUCT FEATURES
Control via three touch sensitive buttons or the app
Compact design makes it a discreet addition to any home
In-built earthing
Integrated residual current protection device
Compliant with the new Smart Charger Regulations
Includes current measurement clamp and wall mounting accessories

TECHNICAL SPECIFICATION
Power: 7kW
Model: Unithetherd
Socket: Type 2 IEC62196
Supply: Single phase
PEN fault detection: Conforms to 722 411 4 1 (iv) of BS7671
18m edition
Dimensions: 230 x 140 x 100mm (H x W x D) Roof



NOTES:

Proposed - Floor Plans



TSR

07939 926 789

E-MAIL: info@greatplans.co.uk

Client:

Location:

67 Pinkwell Lane
Hayes
UB3

Scale: 1:200 @ A4
Scale: 1:100 @ A2
0 2M 8M



Date: 04-07-23 Drawn By: Joel Gray

Dwg No: 03a