



Front Elevation



Side Elevation

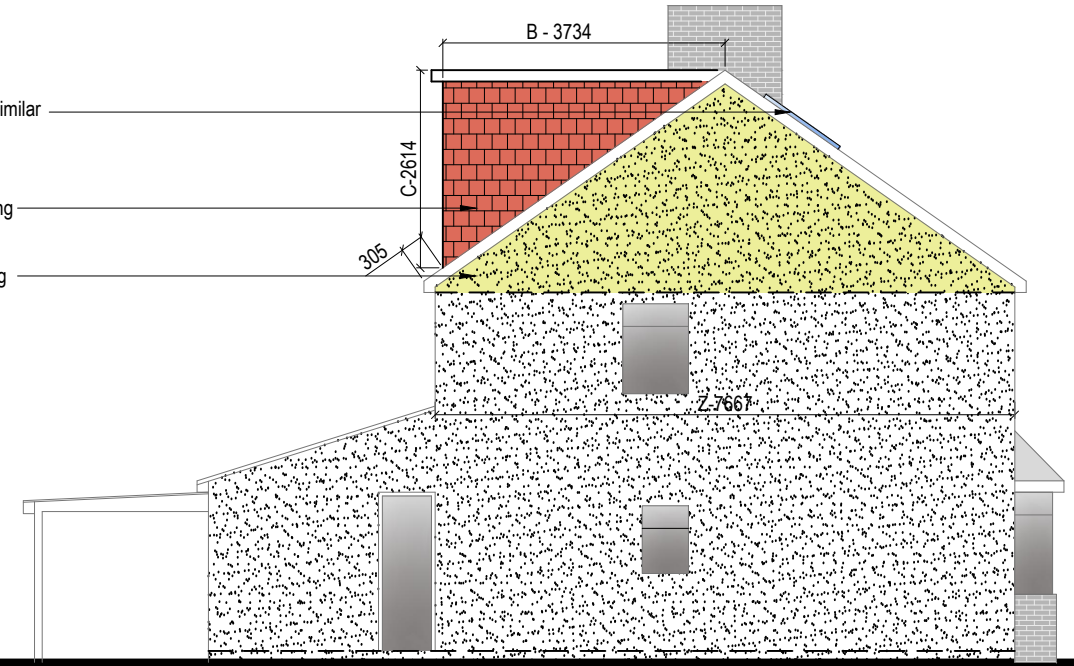

Rear Elevation

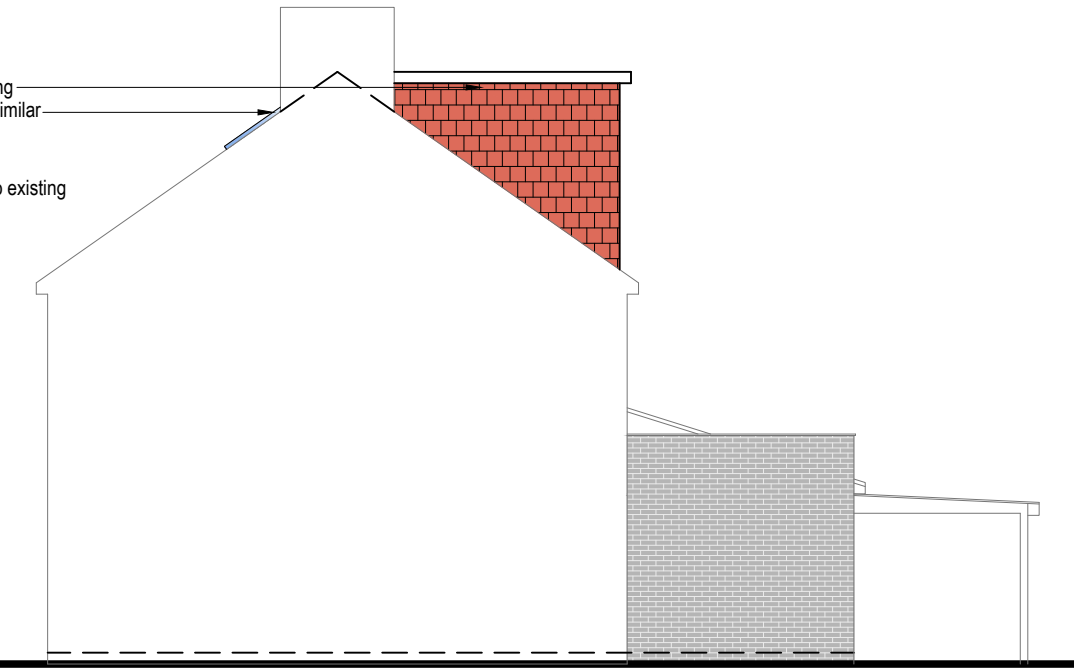

Side Elevation



VOLUME CALCUATION :-

1. HIP TO GABLE :-

$X-3.834 \times Y-2.684 \times Z-7.667 \times \frac{1}{6} = 13.14 \text{ M3}$

2. DORMER :-


$A-5.087 \times B-3.734 \times C-2.614 \times \frac{1}{2} = 24.82 \text{ M3}$

TOTAL :-  $13.14 + 24.82 = 37.96 \text{ M3}$

NOTE:

ANY WINDOW INSERTED ON WALL OR ROOF SLOPE FORMING A SIDE ELEVATION OF THE DWELLING SHALL BE:

1. OBSECURE P GLAZED
2. NON- OPENING UNLESS THE PARTS OF THE WINDOW WHICH CAN BE OPENED ARE MORE THAN 1.7 METERS ABOVE THE FLOOR OF THE ROOM IN WHICH THE WINDOW IS INSTALLED.
3. ROOF WINDOW WILL NOT PROTRUDE MORE THAN 150MM

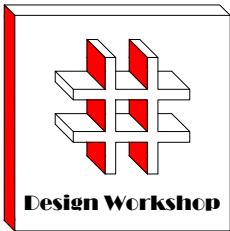

Dimensions to be verified on site  
DO NOT SCALE FROM THIS DRAWING.  
Any areas indicated on this drawing are for guidance only.No responsibility is taken for their accuracy.

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Site Address:

Address  
52 Doghurst Avenue  
Hayes  
UB3 5BJ

Title:


Proposed Elevations

Scale: 1:100



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Rev Date Comments



Drawn By: SH  
Job Ref: 25122  
Date: Oct 2025  
Drawing No. LW- 04

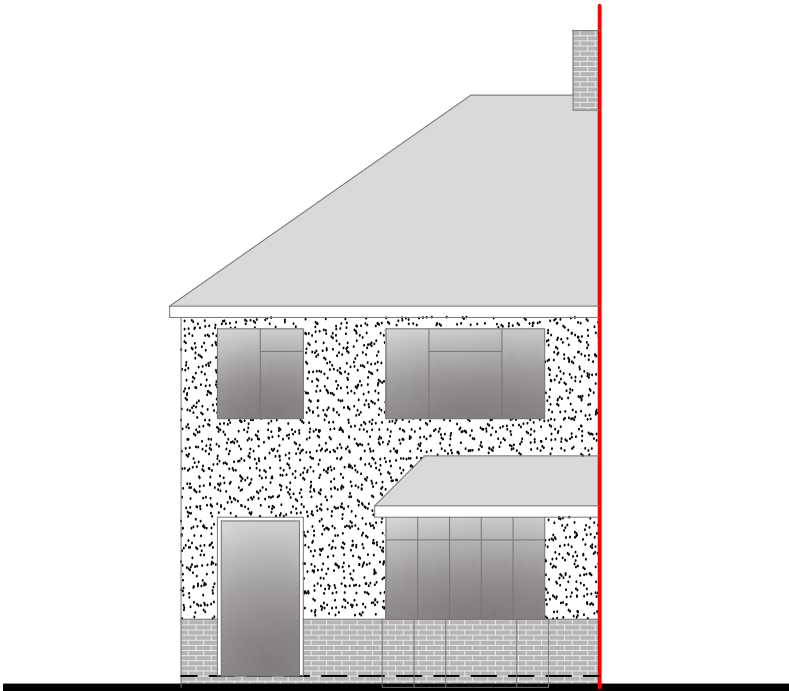


Front Elevation

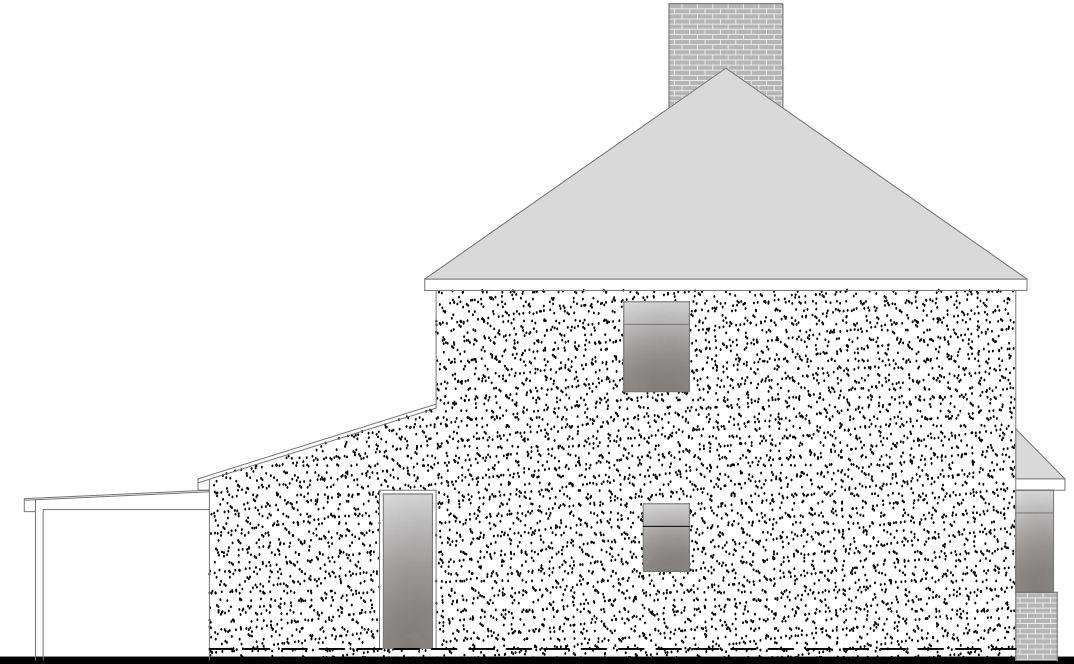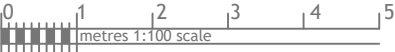



Side Elevation

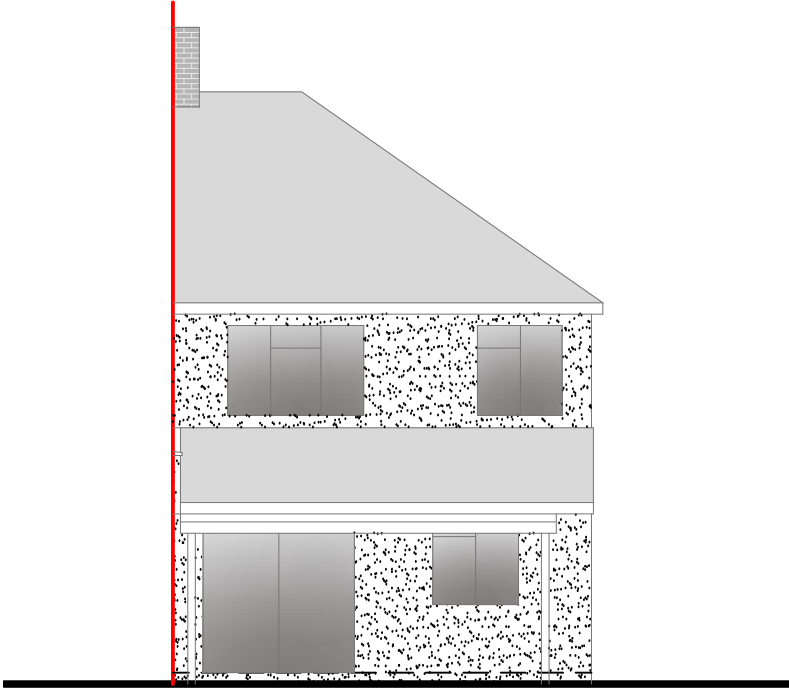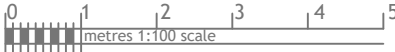

Rear Elevation

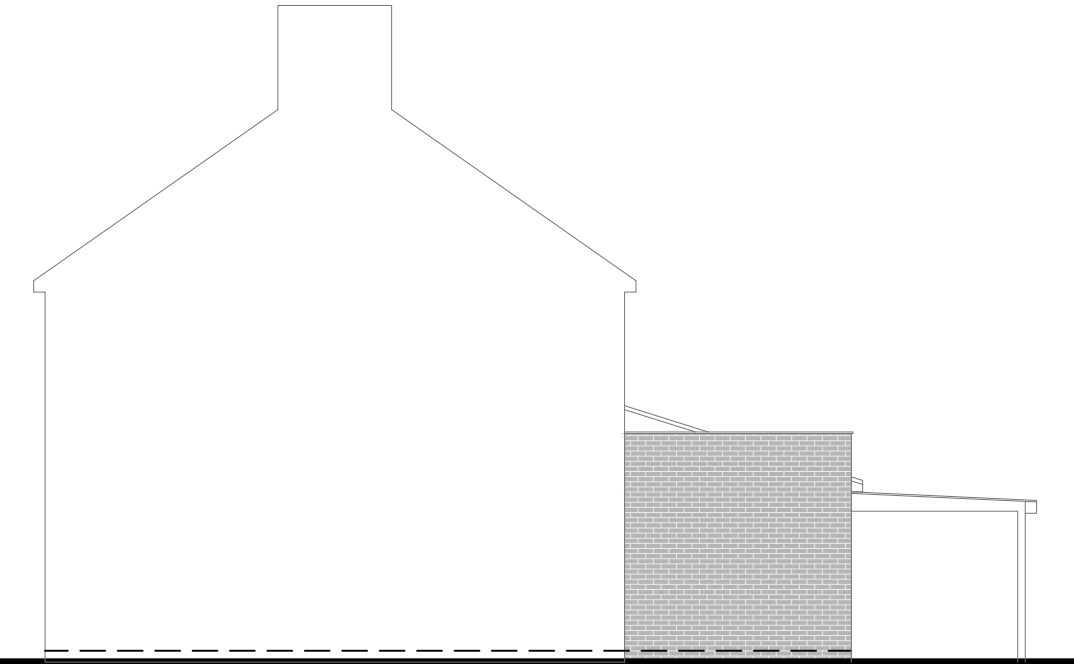

Side Elevation

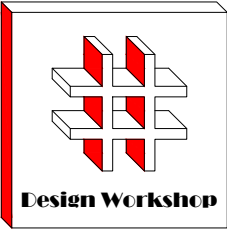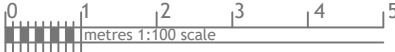

Dimensions to be verified on site  
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Site Address:

Address  
52 Doghurst Avenue  
Hayes  
UB3 5BJ

Title:


Existing Elevations

Scale: 1:100

Paper Size: A3

Rev	Date	Comments
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Drawn By:	SH
Job Ref:	25122
Date:	Oct 2025
Drawing No.	LW- 03

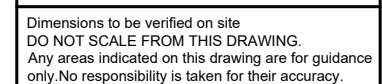

Site Address:

Title: \_\_\_\_\_

Scale:	1:50, 1:100
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Paper Size:	A3
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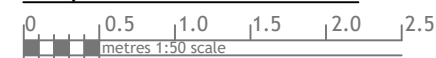
Rev	Date	Comments
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Drawn By: SH

Job Ref: 25122


Date: Oct 2025

Drawing No. LW - 02







Block Plan

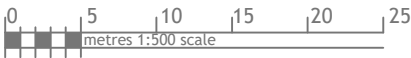

Site Location

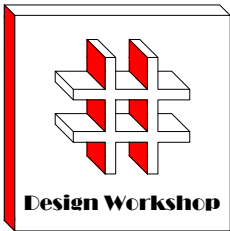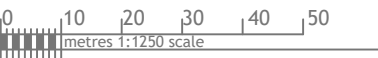

Dimensions to be verified on site  
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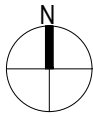
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Site Address:

Address  
52 Doghurst Avenue  
Hayes  
UB3 5BJ

Title:

Block and Location  
Plans



Scale: 1:500, 1:1250

Paper Size: A3

Rev	Date	Comments
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Drawn By:	SH
Job Ref:	25122
Date:	Oct 2025
Drawing No.	LW - 01