

VOLUME OF END GABLE =  $\frac{1}{3}(\text{LENGTH} \times \text{HEIGHT} \times \text{DEPTH})$   
 $= \frac{1}{3}(8.5 \times 2.75 \times 4.10)$   
 $= 19.66$

VOLUME OF REAR DORMER =  $\frac{1}{3}(\text{LENGTH} \times \text{HEIGHT} \times \text{DEPTH})$   
 $= \frac{1}{3}(5.93 \times 2.75 \times 3.62)$   
 $= 29.52$

TOTAL = 49.18 < 50

#### GENERAL NOTES

All dimensions, levels, sizes, positions and locations of particulars as indicated on drawings are to be verified by the appointed contractor on site prior to engaging in works.

Any discrepancies must be reported to the Designer/Engineer/Surveyor or responsible person/s immediately.

None

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ITEM	DESCRIPTION	UNIT	QTY
P3	WINDOWS	NP	20.03.2025
P2	CLIENT AMENDMENTS	NP	27.01.2025
P1	CLIENT AMENDMENTS	NP	22.01.2025
REVISION	REVISION	NP	NP


SITE ADDRESS  
20 WARREN DRIVE  
RUISLIP  
HA4 9RD

DRAWING TITLE  
PROPOSED ELEVATIONS


DATE JAN 2025  
SCALE 1:100 @ A3  
DRAWING NO. DD383-05-P3

DRAWN BY NP  
CHECKED BY NP  
REVIEWED BY NP


#### PROPOSED FRONT ELEVATION

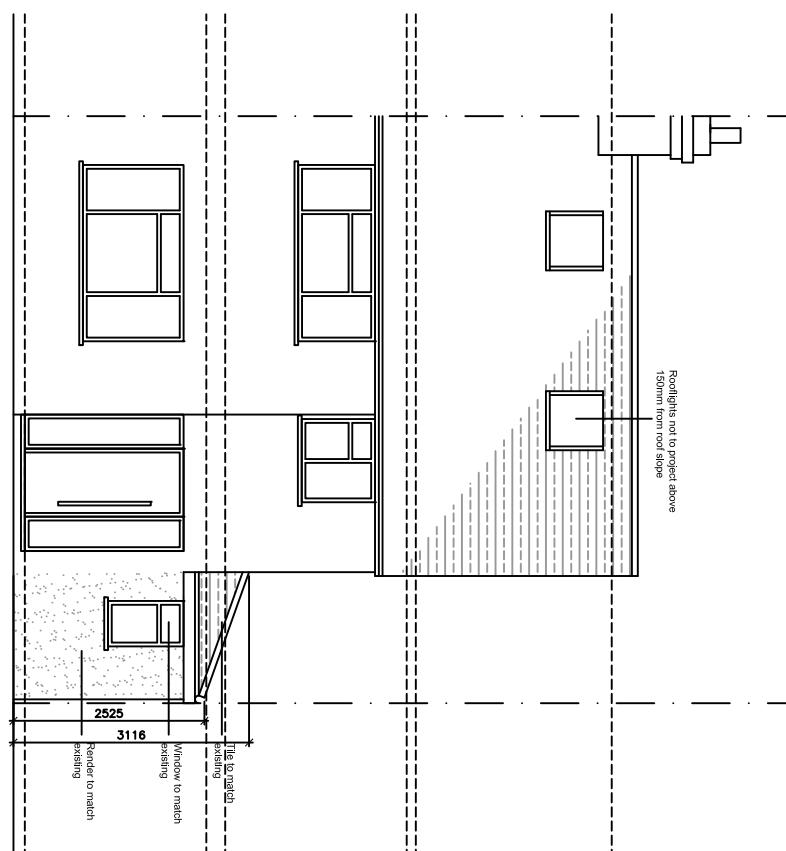

#### PROPOSED SIDE ELEVATION

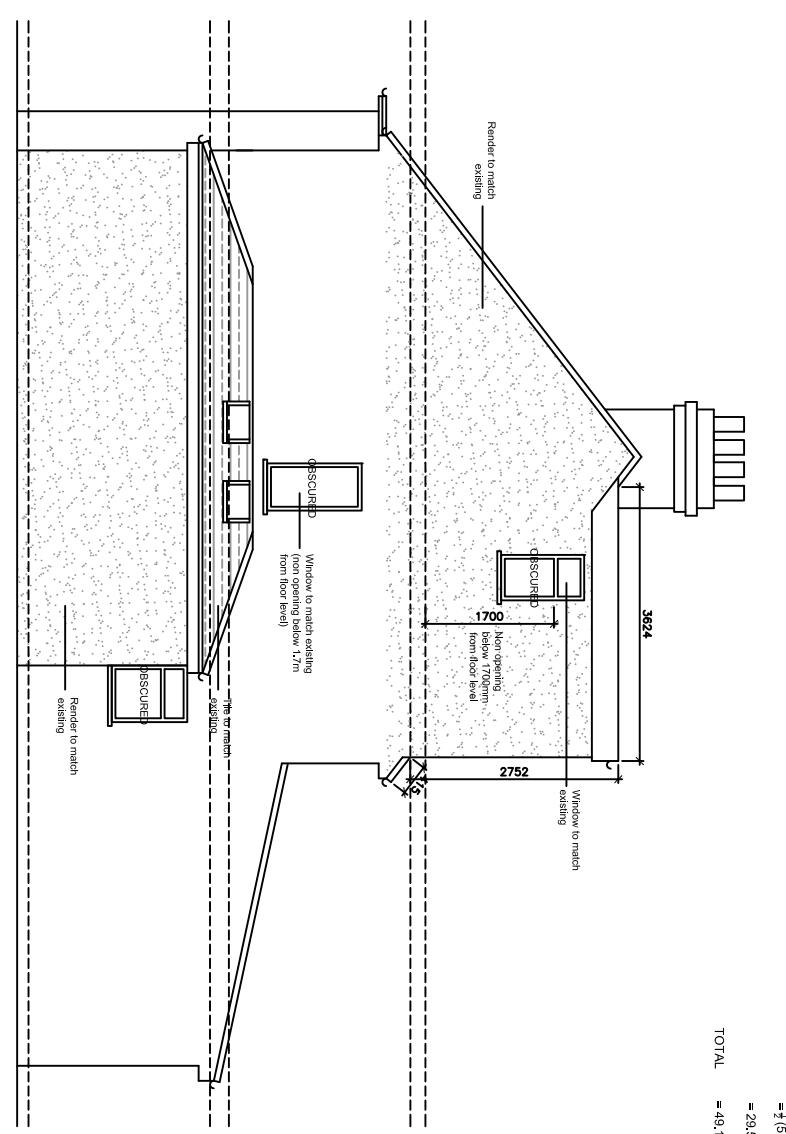

#### PROPOSED REAR ELEVATION

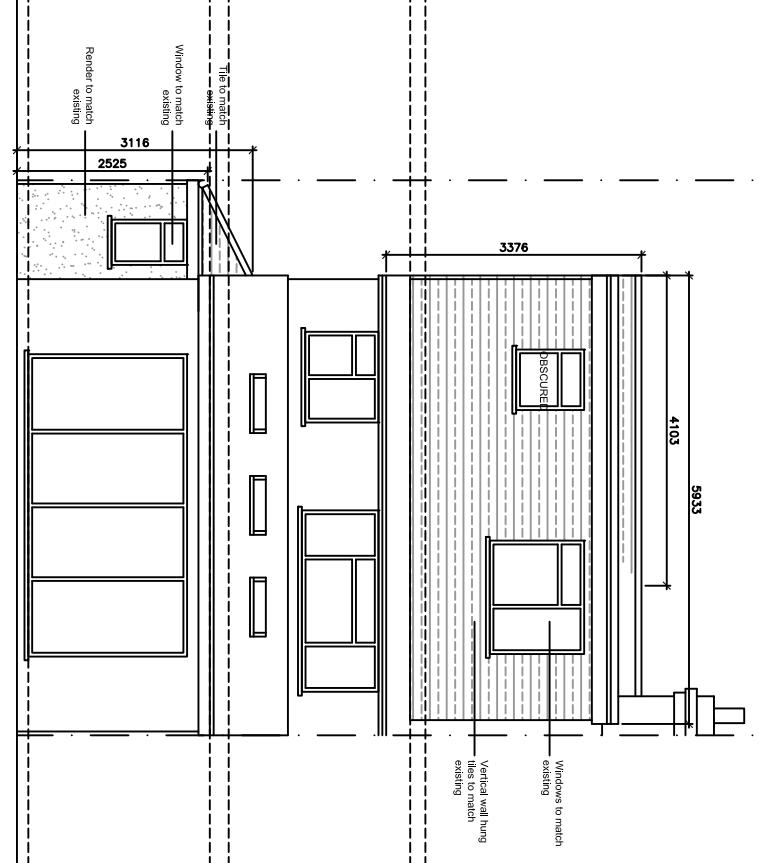

#### PROPOSED SECTIONAL SIDE ELEVATION

