



Design Workshop

Dimensions to be verified on site
DO NOT SCALE FROM THIS DRAWING.
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Site Address:

36 Craig Drive,
Uxbridge
UB8 3HL

Title:


Existing Elevations

Scale: 1:100

Paper Size: A3

Rev Date Comments

Drawn By: VG
Job Ref: 25156
Date: Dec 2025
Drawing No. LW - 05

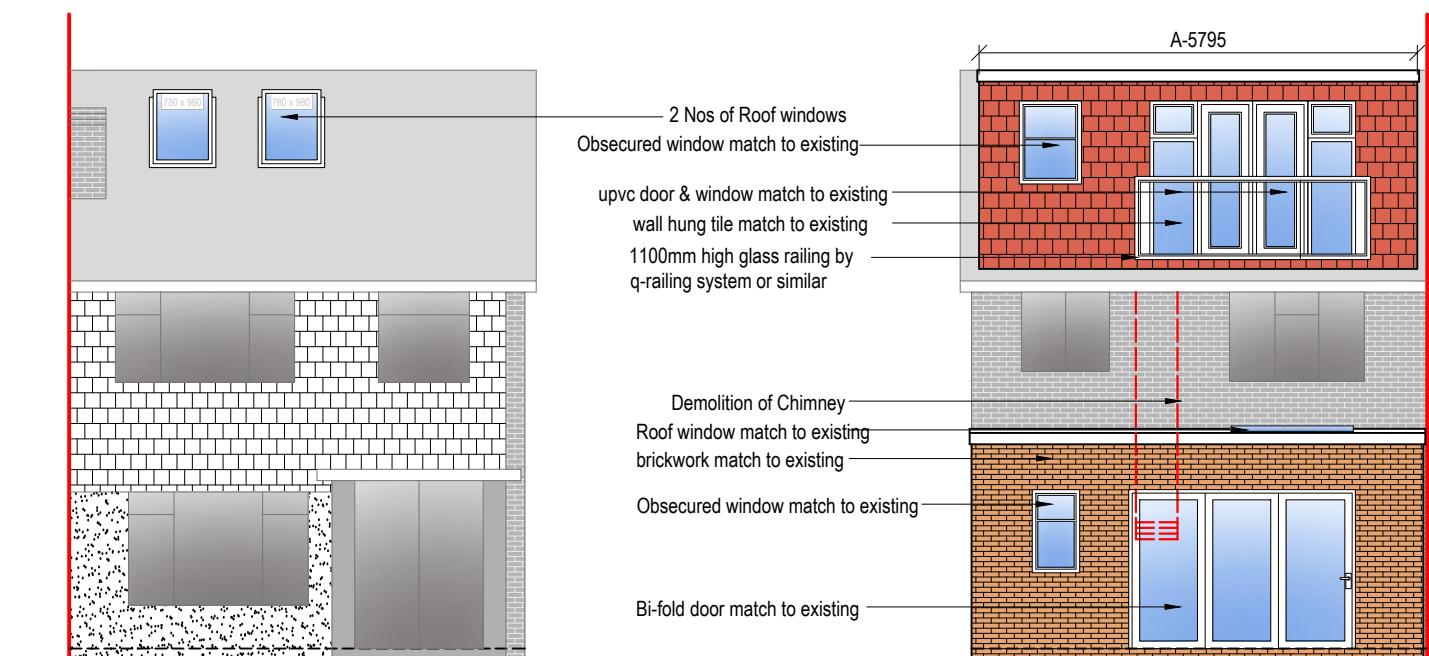

Front Elevation

0 1 2 3 4 5
metres 1:100 scale

Rear Elevation

0 1 2 3 4 5
metres 1:100 scale

NOTE: VOLUME CALCULATION

Site: 36 Craig Drive, Uxbridge UB8 3HL

Rear Dormer :


$$A - 5.795 \times B - 4.148 \times C - 2.626 \times \frac{1}{2} = 31.56\text{m}^3$$

TOTAL VOLUME: 31.56 M3

NOTE:


ANY WINDOW INSERTED ON WALL OR ROOF SLOPE
FORMING A SIDE ELEVATION OF THE DWELLING
SHALL BE:

1. OBSECURE P GLAZED
2. NON- OPENING UNLESS THE PARTS OF THE
WINDOW WHICH CAN BE OPENED ARE MORE
THAN 1.7 METERS ABOVE THE FLOOR OF THE
ROOM IN WHICH THE WINDOW IS INSTALLED.
3. ROOF WINDOW WILL NOT PROTRUDE MORE
THAN 150MM

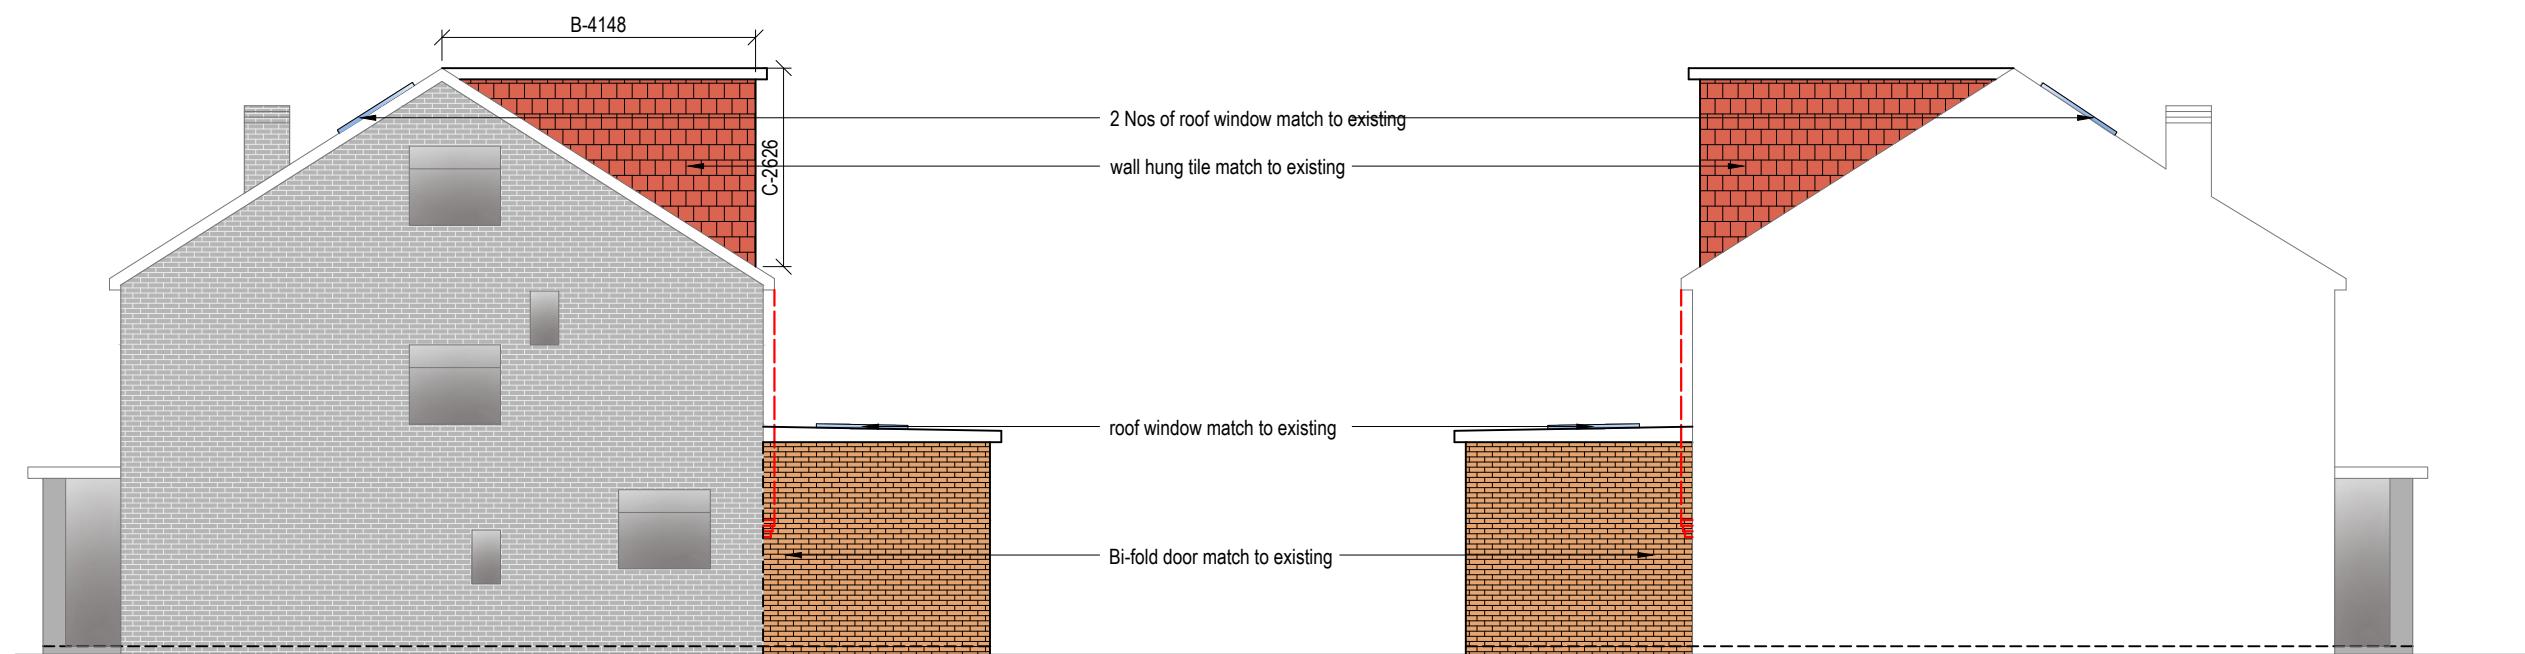

Side Elevations

0 1 2 3 4 5
metres 1:100 scale

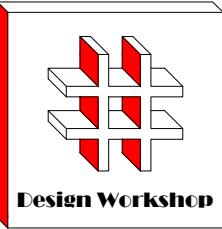

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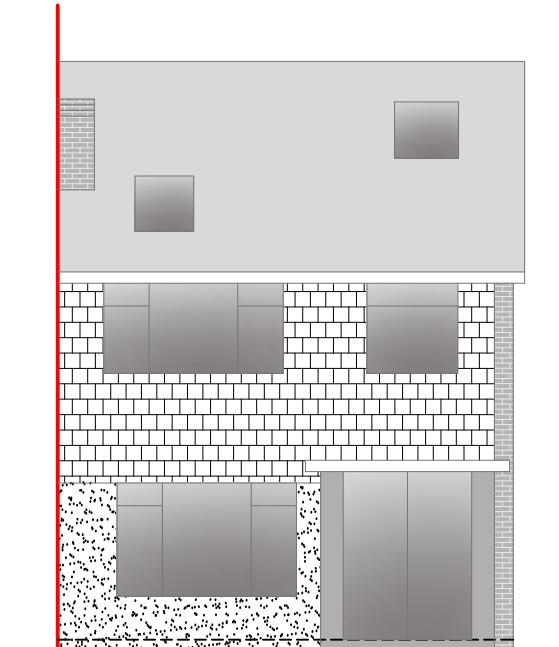
Title:

Existing Elevations


Scale: 1:100

Paper Size: A3


Rev	Date	Comments



Front Elevation

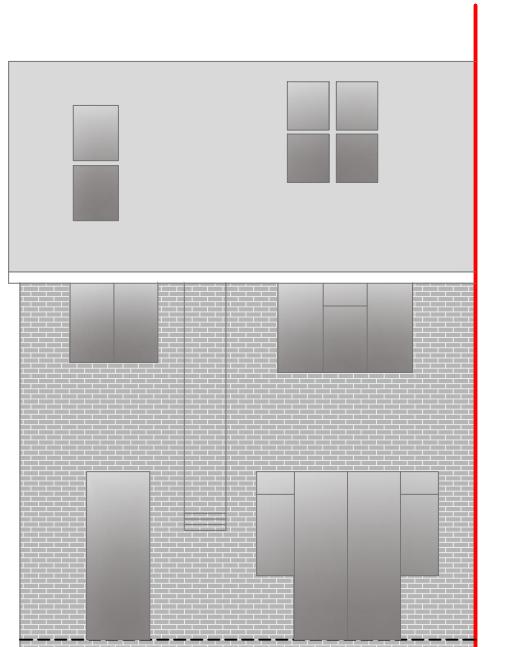

Rear Elevation

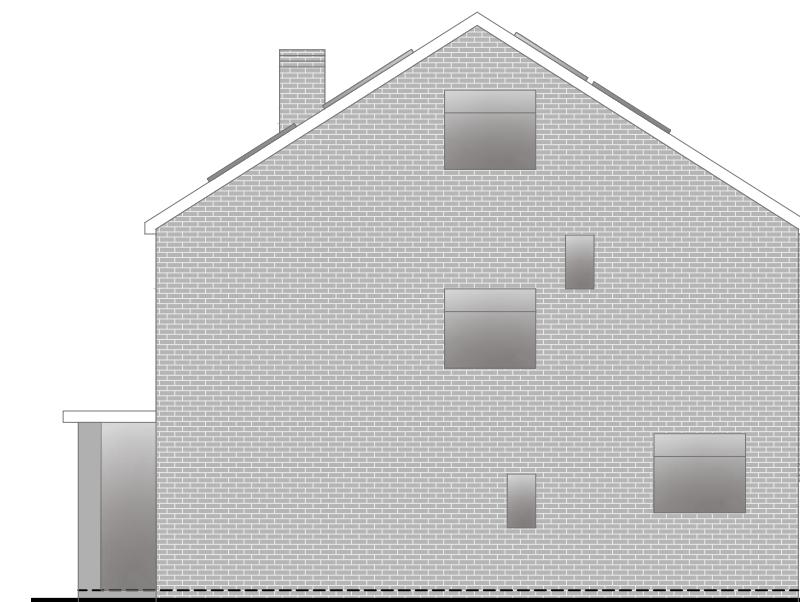

Side Elevation


0 1 2 3 4 5
metres 1:100 scale

Drawn By: VG

Job Ref: 25156

Date: Dec 2025

Drawing No. LW - 04

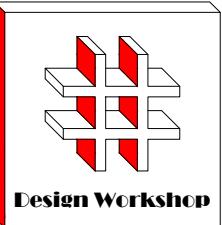

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UB8 3HL

Title:


Existing First and loft Plan with Proposed Loft Plan

Scale: 1:50, 1:100

Paper Size: A3


Rev Date Comments

Drawn By: VG
Job Ref: 25156
Date: Dec 2025
Drawing No. LW - 03

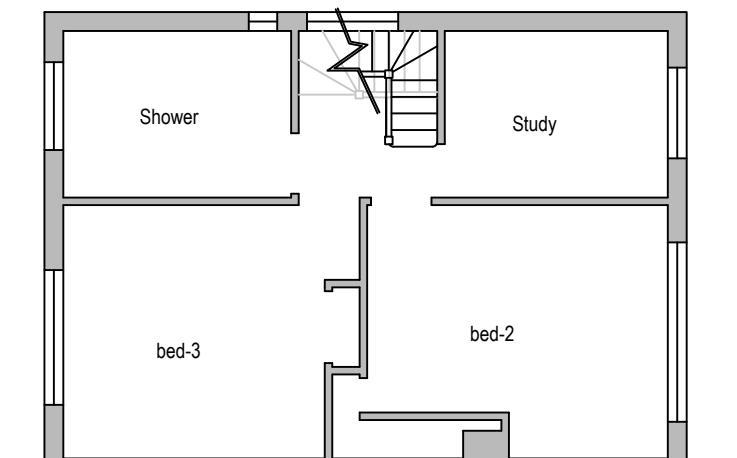


Existing First Floor Plan

0 1 2 3 4 5
metres 1:100 scale

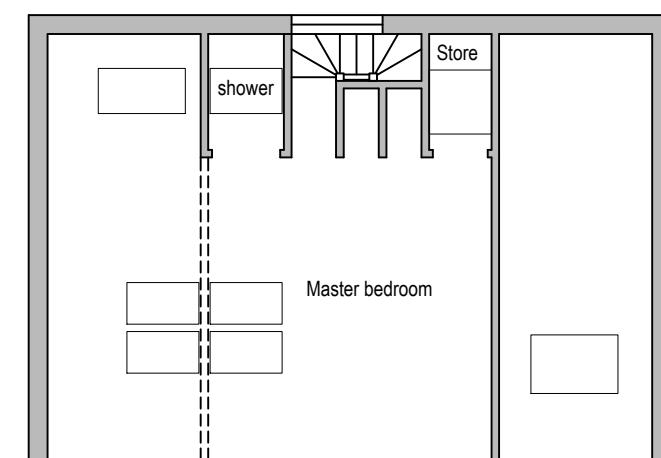


Existing Loft Plan

0 1 2 3 4 5
metres 1:100 scale

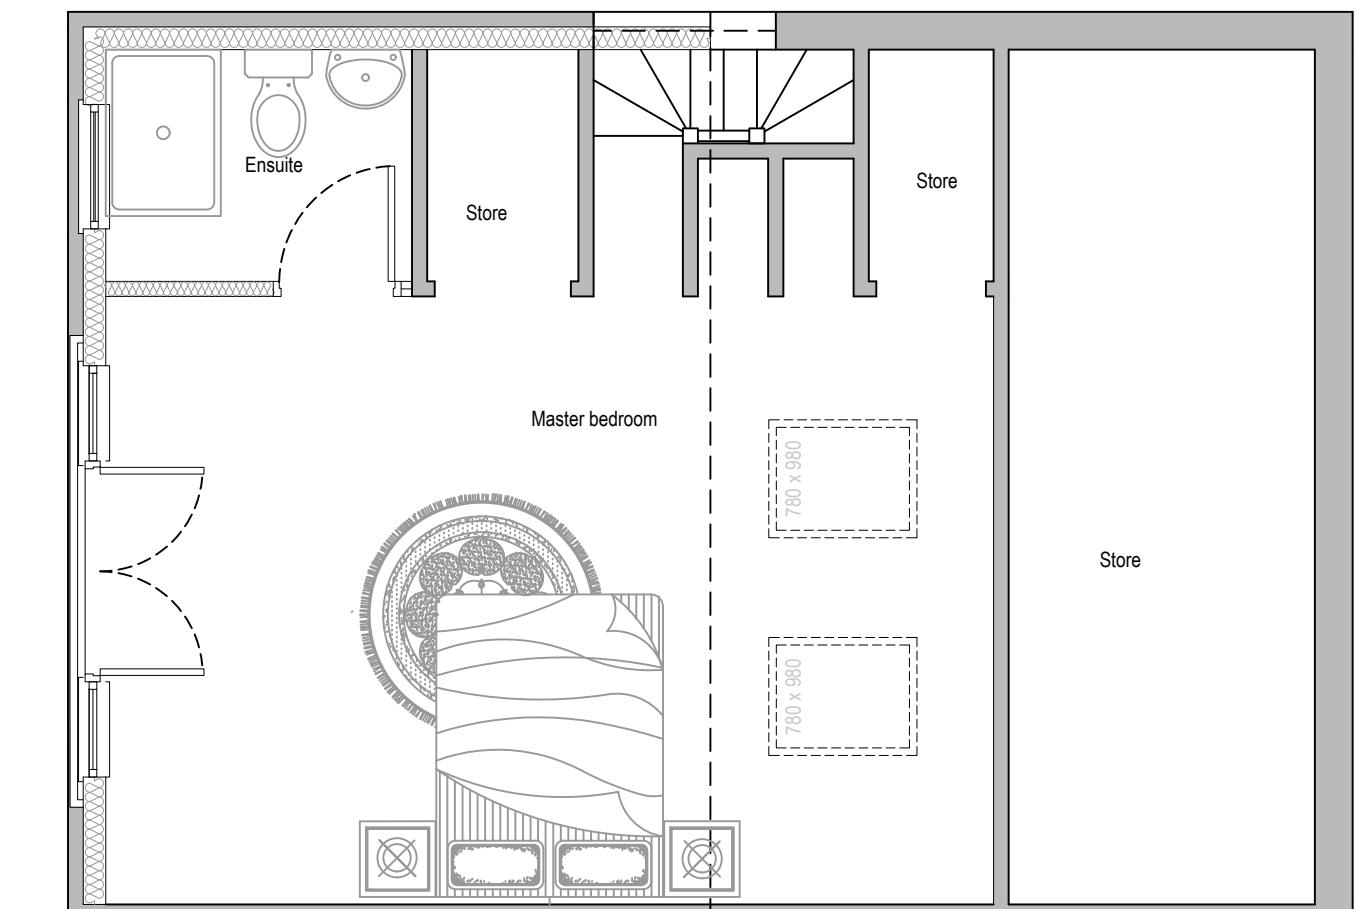

Proposed Loft Floor Plan

0 0.5 1.0 1.5 2.0 2.5
metres 1:50 scale

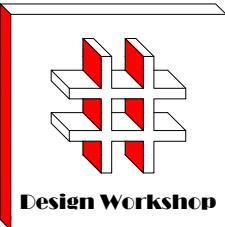

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Site Address:

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UB8 3HL

Title:

Existing & Proposed Ground Floor
Plans

Scale: 1:50, 1:100

Paper Size:

A3


Rev Date Comments

Drawn By: VG

Job Ref: 25156


Date: Dec 2025

Drawing No. LW-02

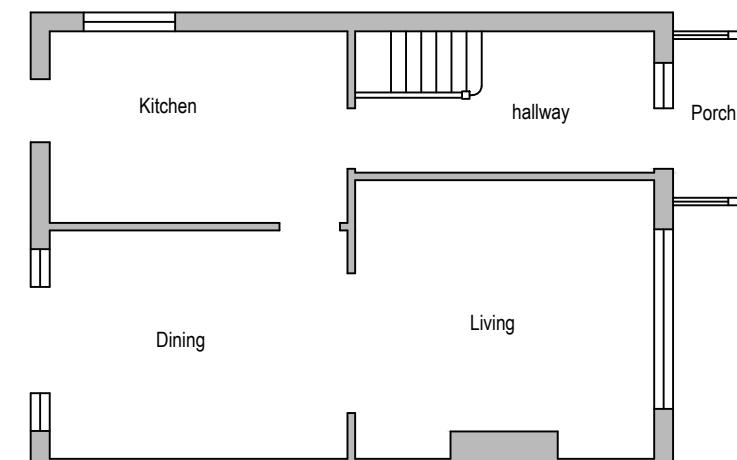


Existing Ground Floor Plan

0 1 2 3 4 5
metres 1:100 scale

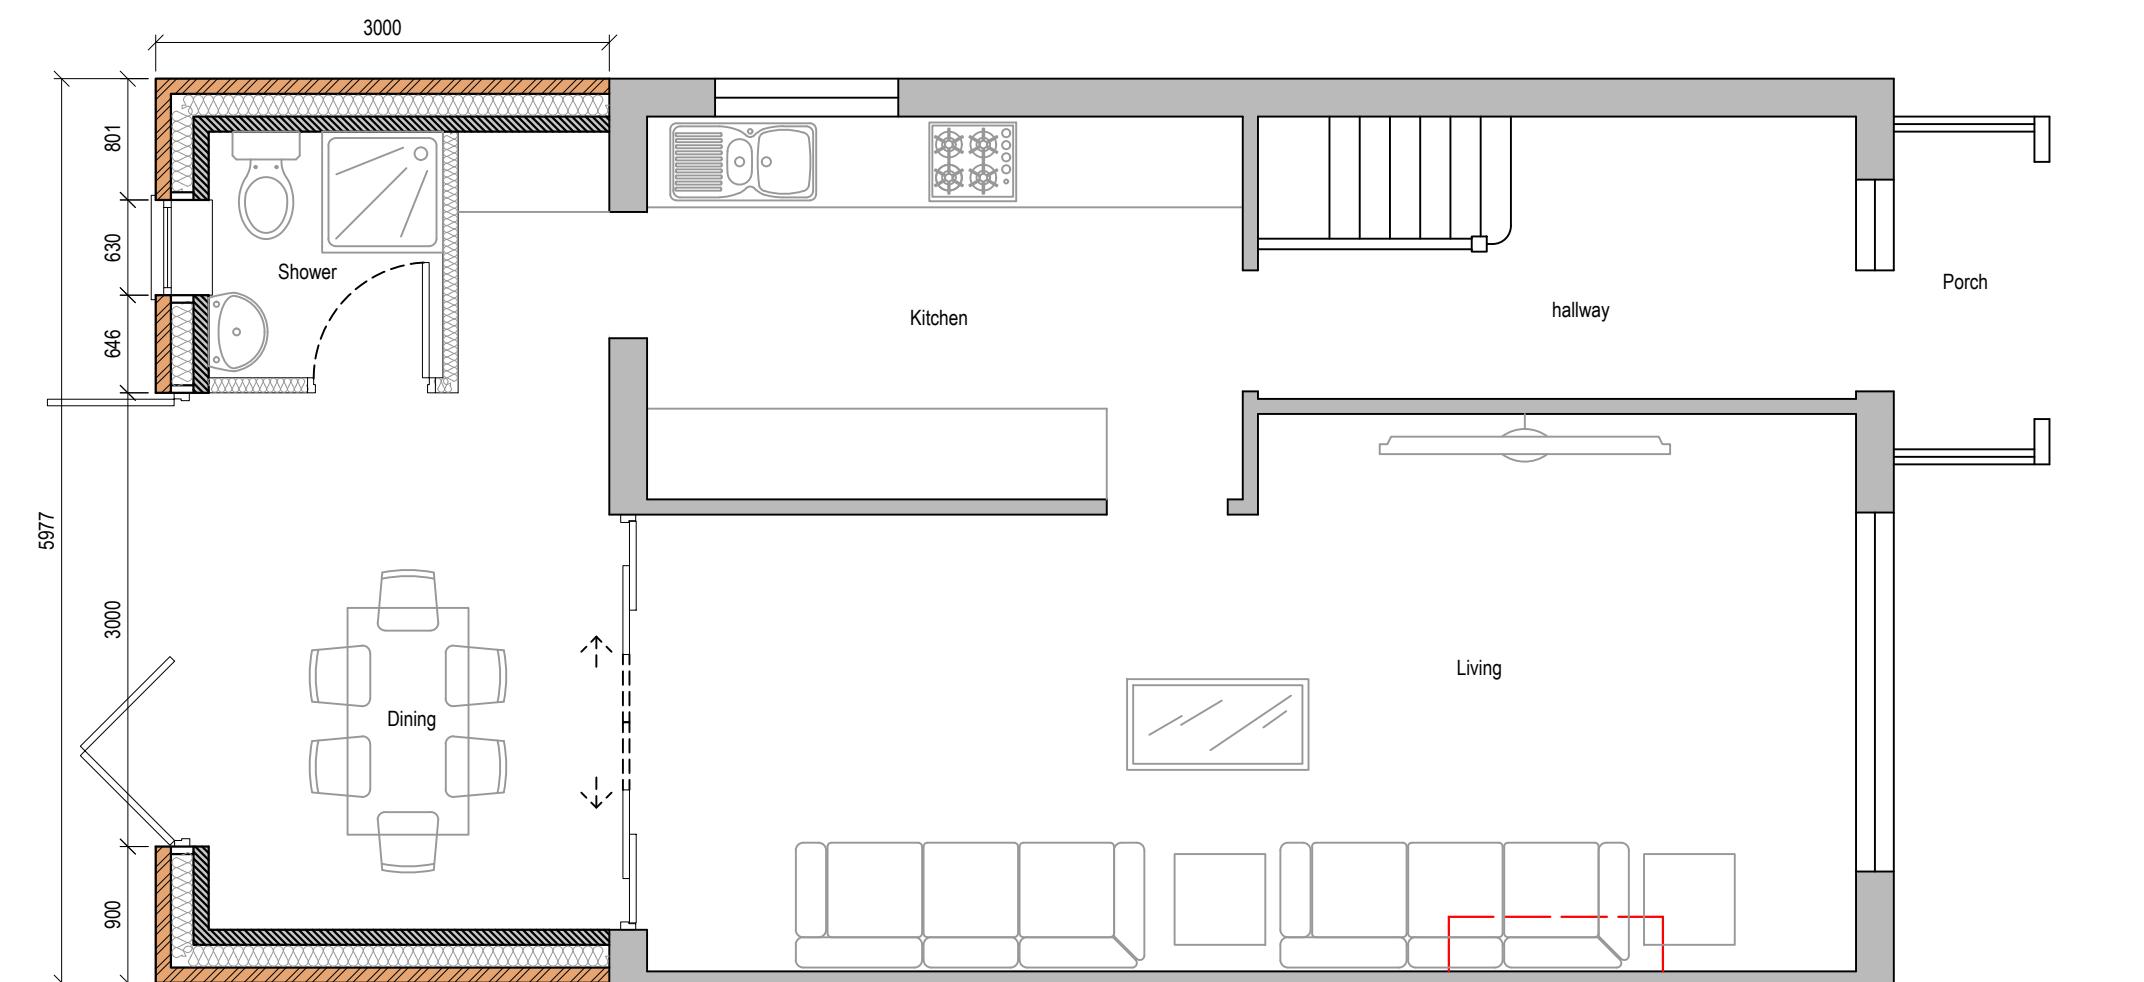


Proposed Ground Floor Plan

0 0.5 1.0 1.5 2.0 2.5
metres 1:50 scale

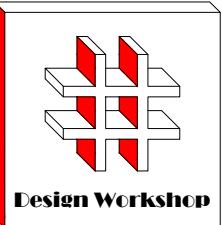

Proposed Extension

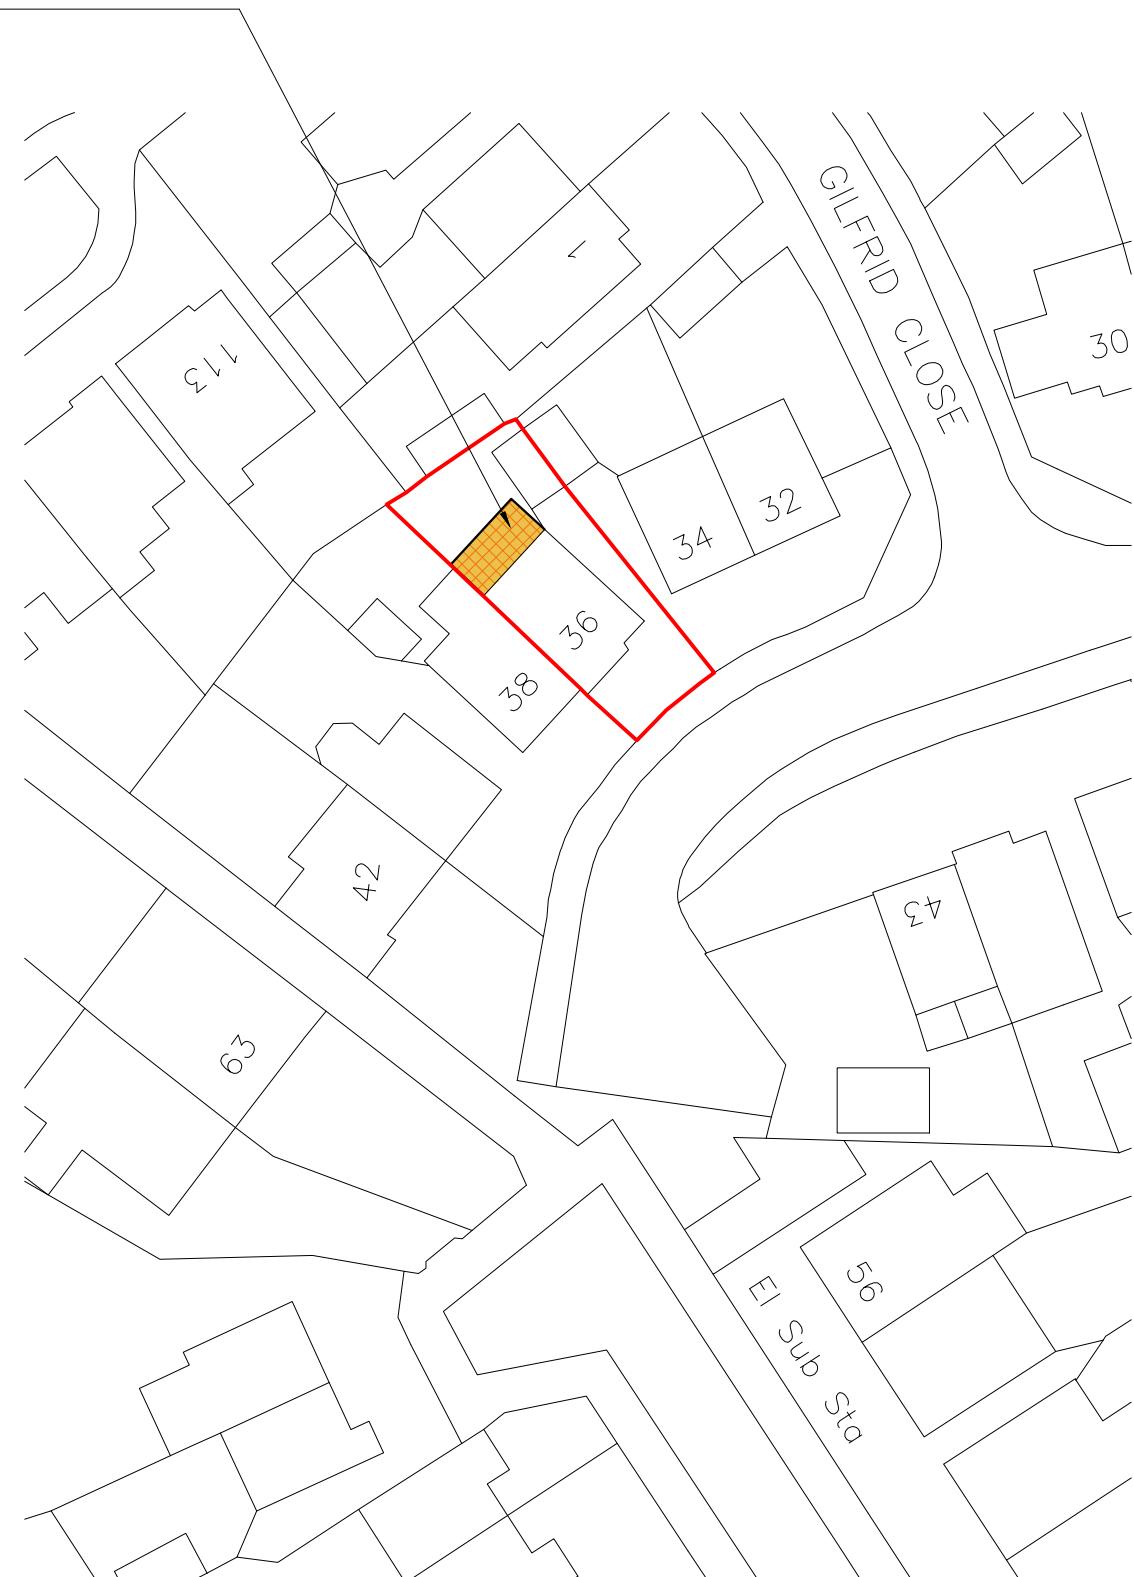

Block Plan

A scale bar marked from 0 to 25 in increments of 5. Below the scale bar is the text "metres 1:500 scale".



Site Location

A scale bar with markings at 0, 10, 20, 30, 40, and 50. Below the bar, the text 'metres 1:1250 scale' is written.

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Title:

Block and Location Plans

Scale: 1:500, 1:1250

aner Size

Dev	Date	Comments
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1100 J. Neurosci., November 1, 2006 • 26(44):1092–1100

Drawn By: VG

Job Ref: 25156

Date: Dec 2025

Drawing No. LW - 01