

Existing Ground Floor Plan
Scale 1:100




Existing Front Elevation
Scale 1:100



Existing Rear Elevation
Scale 1:100



Existing Side Elevation
Scale 1:100

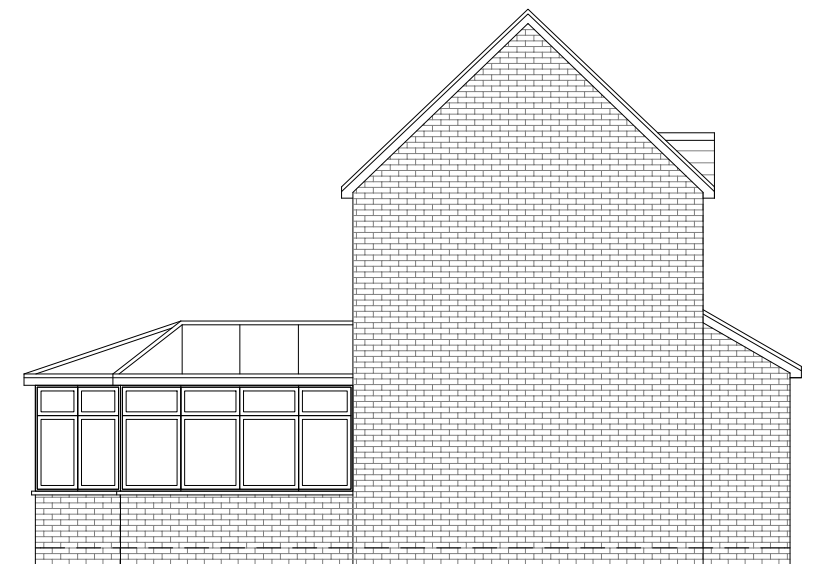

Existing Side Elevation
Scale 1:100

- GENERAL NOTES:
1. ALL DIMENSIONS ARE IN MILLIMETER.
 2. VERIFY ALL DIMENSIONS AND CONDITIONS BEFORE BUILDING OR STARTING CONSTRUCTION. NOTIFY THE DESIGNER IMMEDIATELY OF ANY DISCREPANCY OR VARIATION.
 3. ALL WORK TO COMPLY WITH CURRENT BUILDING REGULATIONS AND CODES OF PRACTICE

Title:

Existing Ground Floor Plan & Elevations

Site Address

6 Kennet Drive
Hayes
Middlesex
UB4 9SP

Scale: 1:100 @A3

Date: 10/07/2025


Drawing No.:
2025/098 -01

Drawn By:
FP

Revision Date:

e:mail -
faluckpatel@yahoo.com
(M) +44 (0) 7871 466 254

**Faluck
Patel**

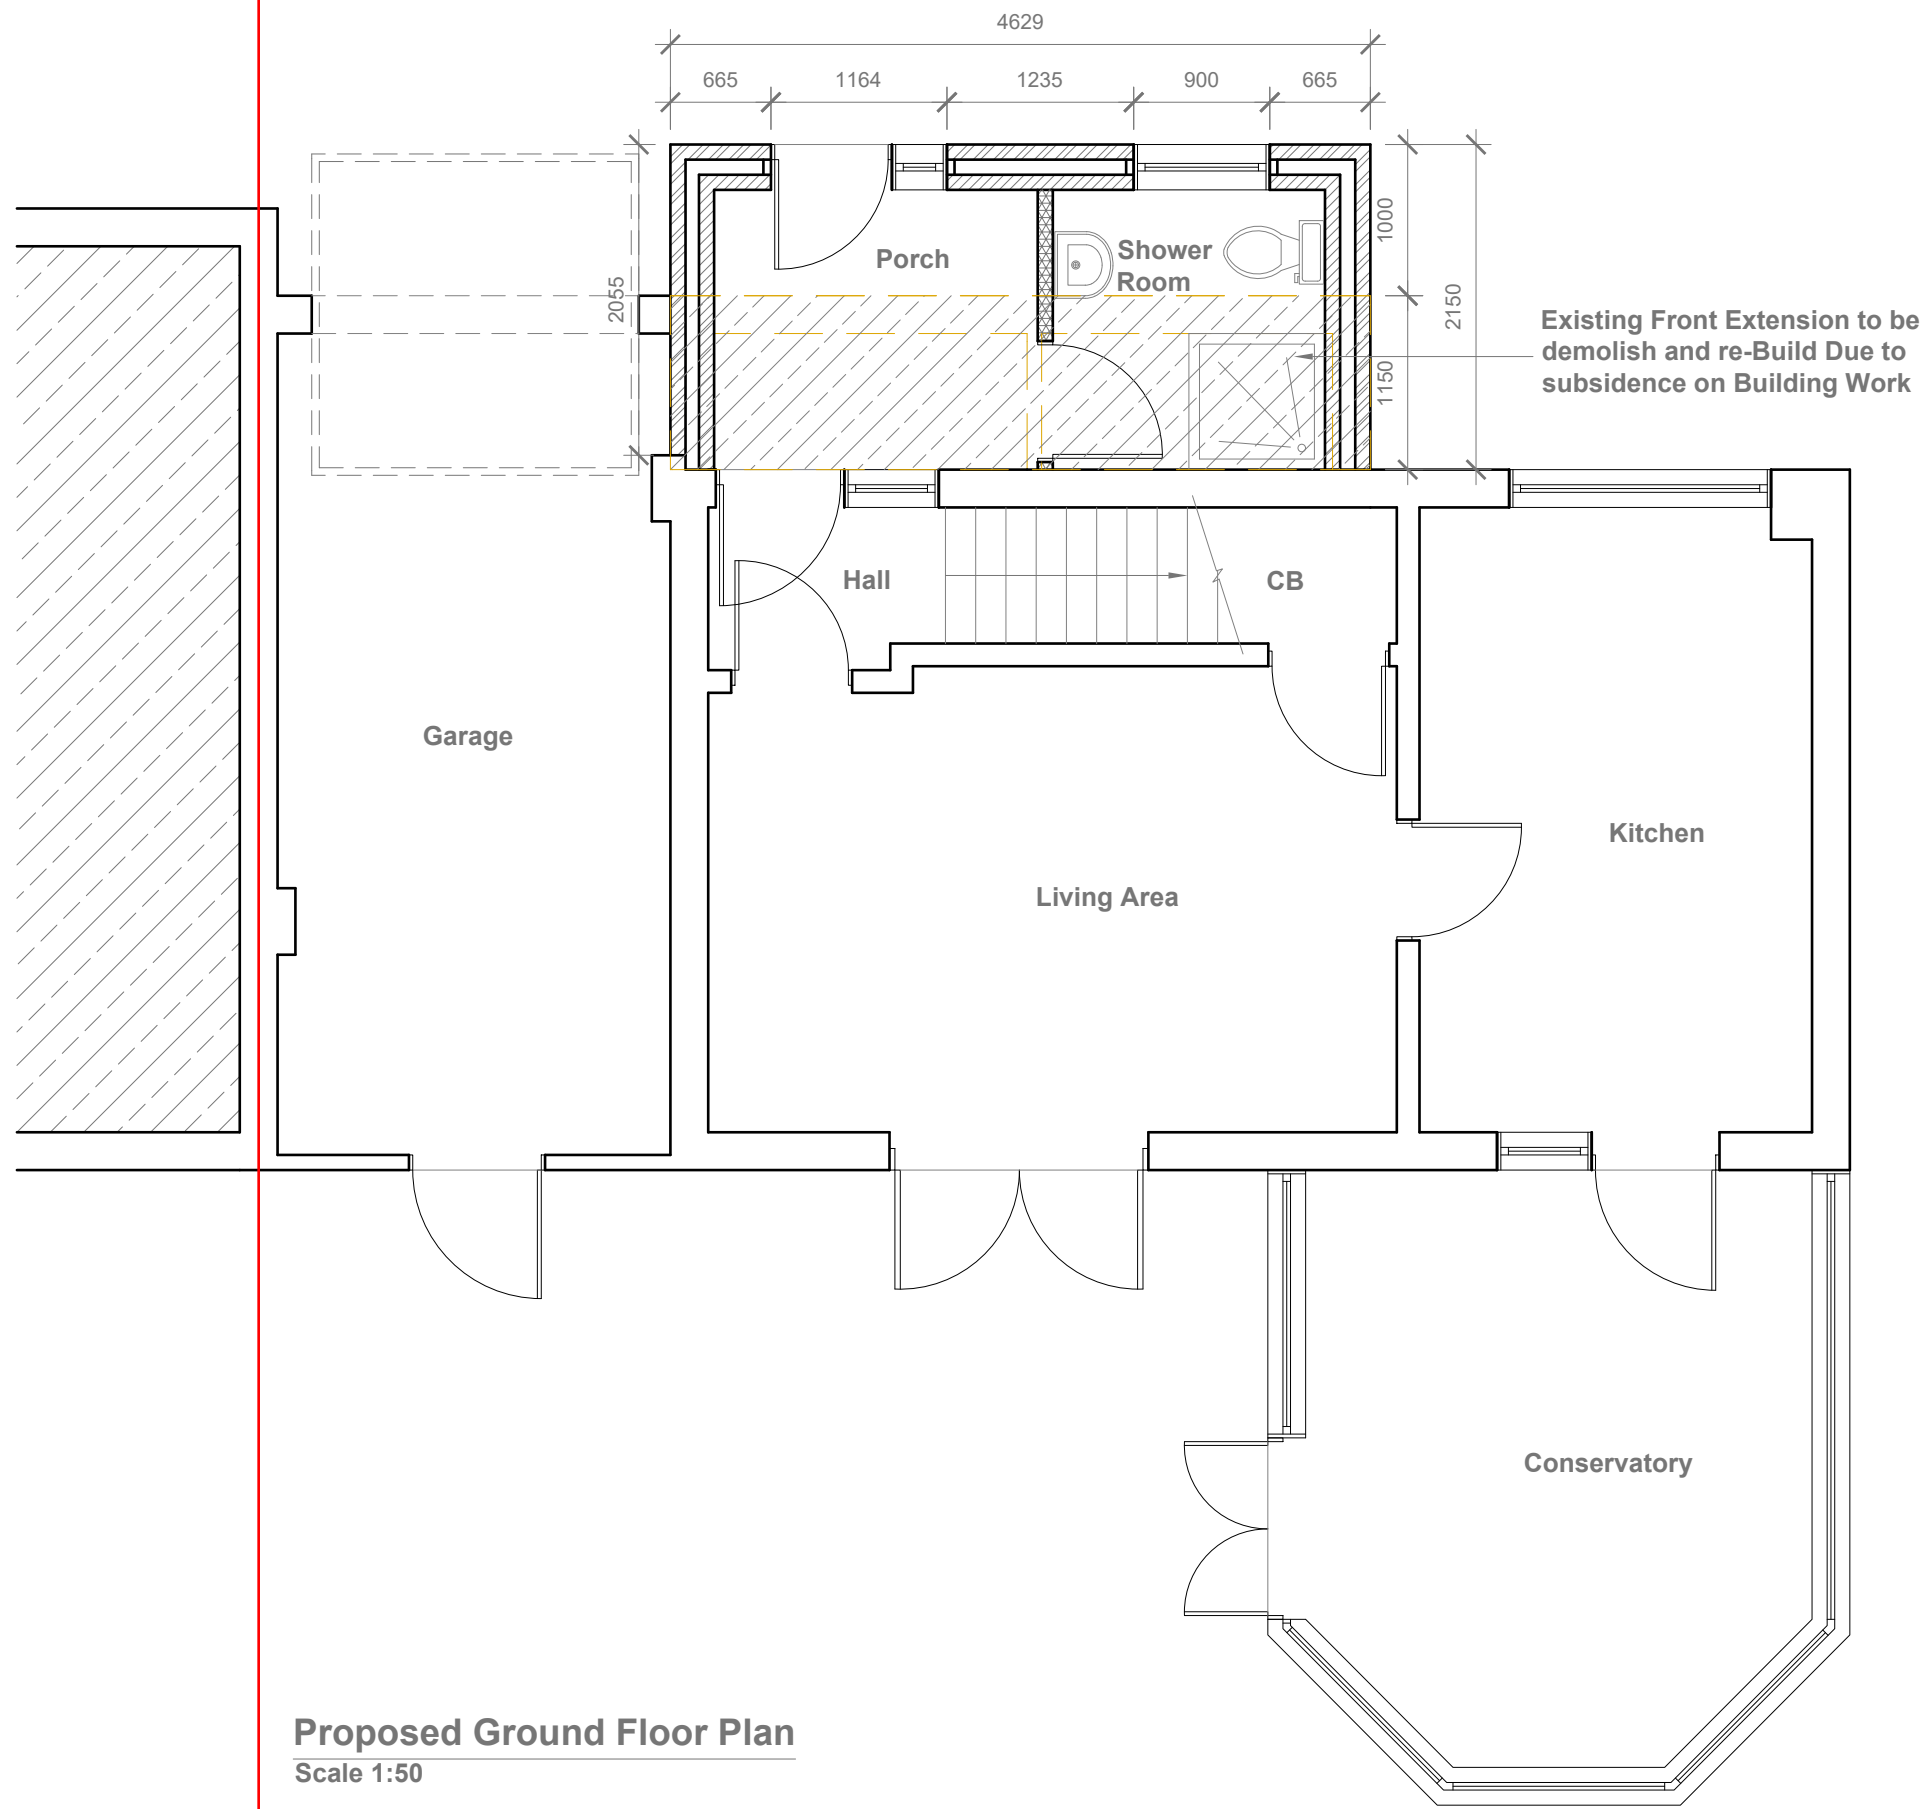

Proposed Ground Floor Plan
Scale 1:50

GENERAL NOTES:
1. ALL DIMENSIONS ARE IN MILLIMETER.
2. VERIFY ALL DIMENSIONS AND CONDITIONS BEFORE BUILDING OR STARTING CONSTRUCTION. NOTIFY THE DESIGNER IMMEDIATELY OF ANY DISCREPANCY OR VARIATION.
3. ALL WORK TO COMPLY WITH CURRENT BUILDING REGULATIONS AND CODES OF PRACTICE

Title:

Proposed Ground Floor Plan

Site Address
6 Kennet Drive
Hayes
Middlesex
UB4 9SP

Scale: 1:50 @A3
Date: 10/07/2025
Drawing No.: 2025/098 -02
Drawn By: FP

Revision Date:
e:mail - faluckpatel@yahoo.com
(M) +44 (0) 7871 466 254



Proposed External Finish
Materials to Match Existing
External Finish Materials



Proposed Front Elevation
Scale 1:100



Proposed Side Elevation
Scale 1:100



Proposed Rear Elevation
Scale 1:100



Proposed Side Elevation
Scale 1:100



GENERAL NOTES:
1. ALL DIMENSIONS ARE IN MILLIMETER.
2. VERIFY ALL DIMENSIONS AND CONDITIONS BEFORE BUILDING OR STARTING CONSTRUCTION. NOTIFY THE DESIGNER IMMEDIATELY OF ANY DISCREPANCY OR VARIATION.
3. ALL WORK TO COMPLY WITH CURRENT BUILDING REGULATIONS AND CODES OF PRACTICE

Title:

Proposed Elevations

Site Address	Scale: 1:100 @A3	Revision Date:
6 Kennet Drive	Date: 10/07/2025	
Hayes	Drawing No.: 2025/098 -03	
Middlesex	Drawn By: FP	
UB4 9SP		e:mail - faluckpatel@yahoo.com (M) +44 (0) 7871 466 254

