


**Key**

- Metal cladding panels. Powder coated RAL 7035
- Gutters, roof flashing and downpipes. Powder coated RAL 7035
- Aluminium door/ glazing system
- Concertina doors for equipment access
- PV Panels
- Galvanised steel spiral round flue
- Aluminium louvres. Colour to match cladding
- Air source heat pump in aluminium louvre enclosure
- Metal insulated roof panels. RAL 7035
- Aluminium fixed roof light
- Engineering brick plinth/wall base
- Gas canister storage in metal mesh cage
- Powder coated galvanised steel guarding/handrails
- Indicative Signage
- Condenser unit

**Note:**  
Landscaping and signage indicative and subject to separate planning applications

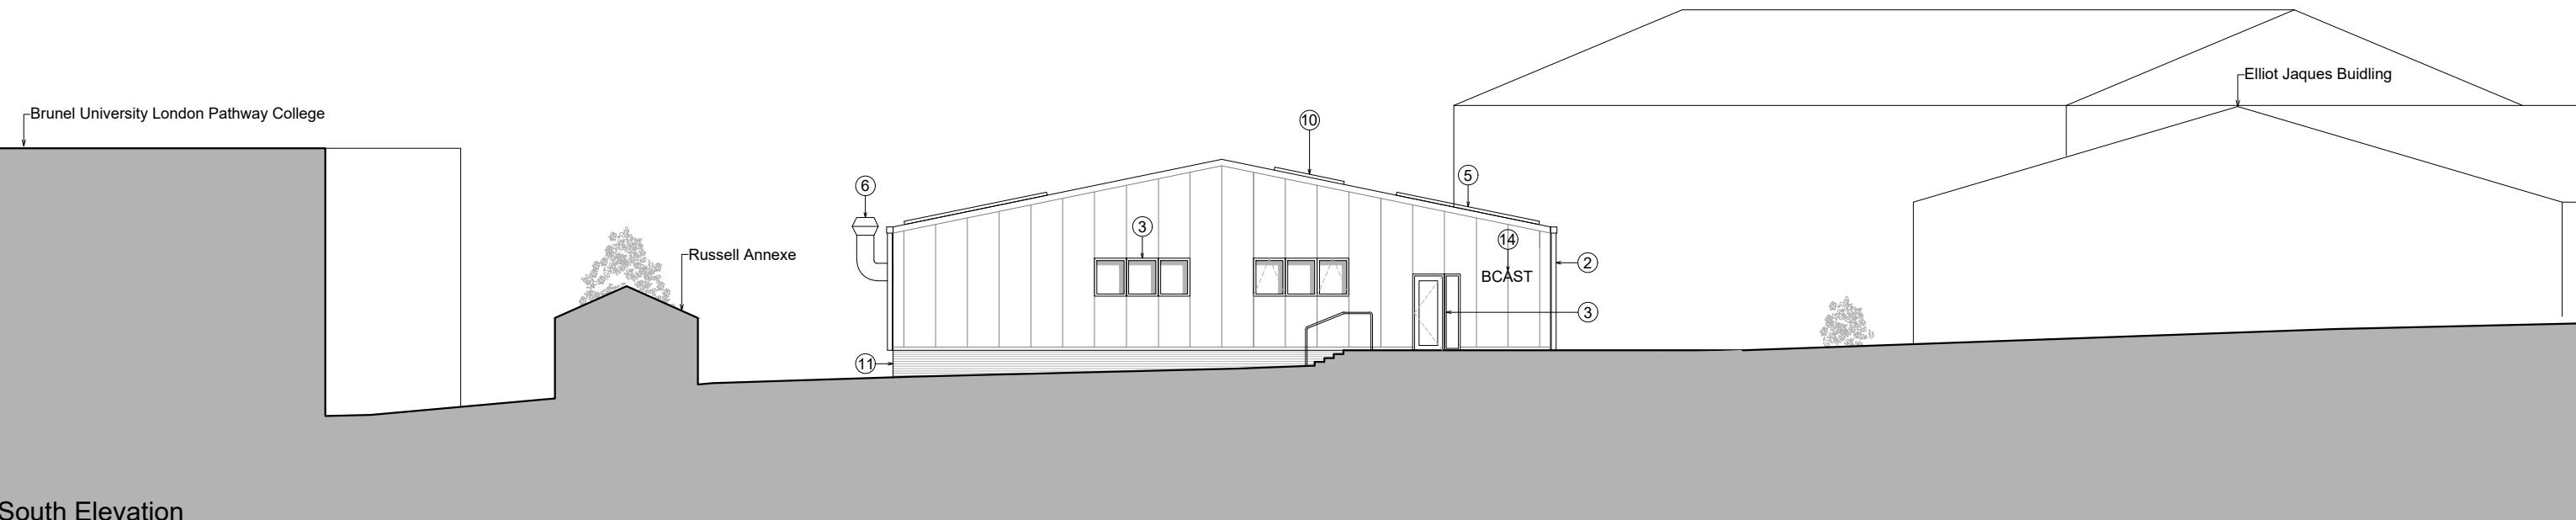

DRAWING NOTES	
1. filename: Proposed Elevation Building 3.dwg	
2. Do not scale this drawing in either paper or digital form. Use figured dimensions only. Detailed site survey to be carried out to establish tolerances. Figured dimensions are in mm. All dimensions shall be verified on site before proceeding with the work. The architect shall be notified of any discrepancies.	
3. This drawing has been produced for sole use on this project and is not intended for use by any other person or for any other purpose. © Copyright RSS (U.K.)	
4. All printed copies should be made at 100% of the original page size. Use scale bars, where included, to check that the drawing has been printed to the intended scale as identified in the title block.	
5. This drawing is not intended for construction unless specifically described as such.	

REVISIONS		
REV	DATE	STATUS
P02	14.06.24	For planning
Changes since last issue: Window positions updated, condenser unit shown		



28 NAVIGATION ROAD LONDON E3 3TG	<b>rivingtonstreetstudio</b>
T : 020 7739 8945	
E : rss@rss.co.uk	www.rivingtonstreetstudio.co.uk
job title	Brunel University RAAC Replacement Buildings
drawing title	Proposed South & North Elevation Site for Building 3
drawn by	job no.
RT /JY	1061
suitability	revision
S4	P02
scale 1:200	PROJECT ORIGIN. VOLUME LEVEL TYPE ROLE NUMBER
	BUR - RSS - 00 - ZZ - DR - A - 1420