
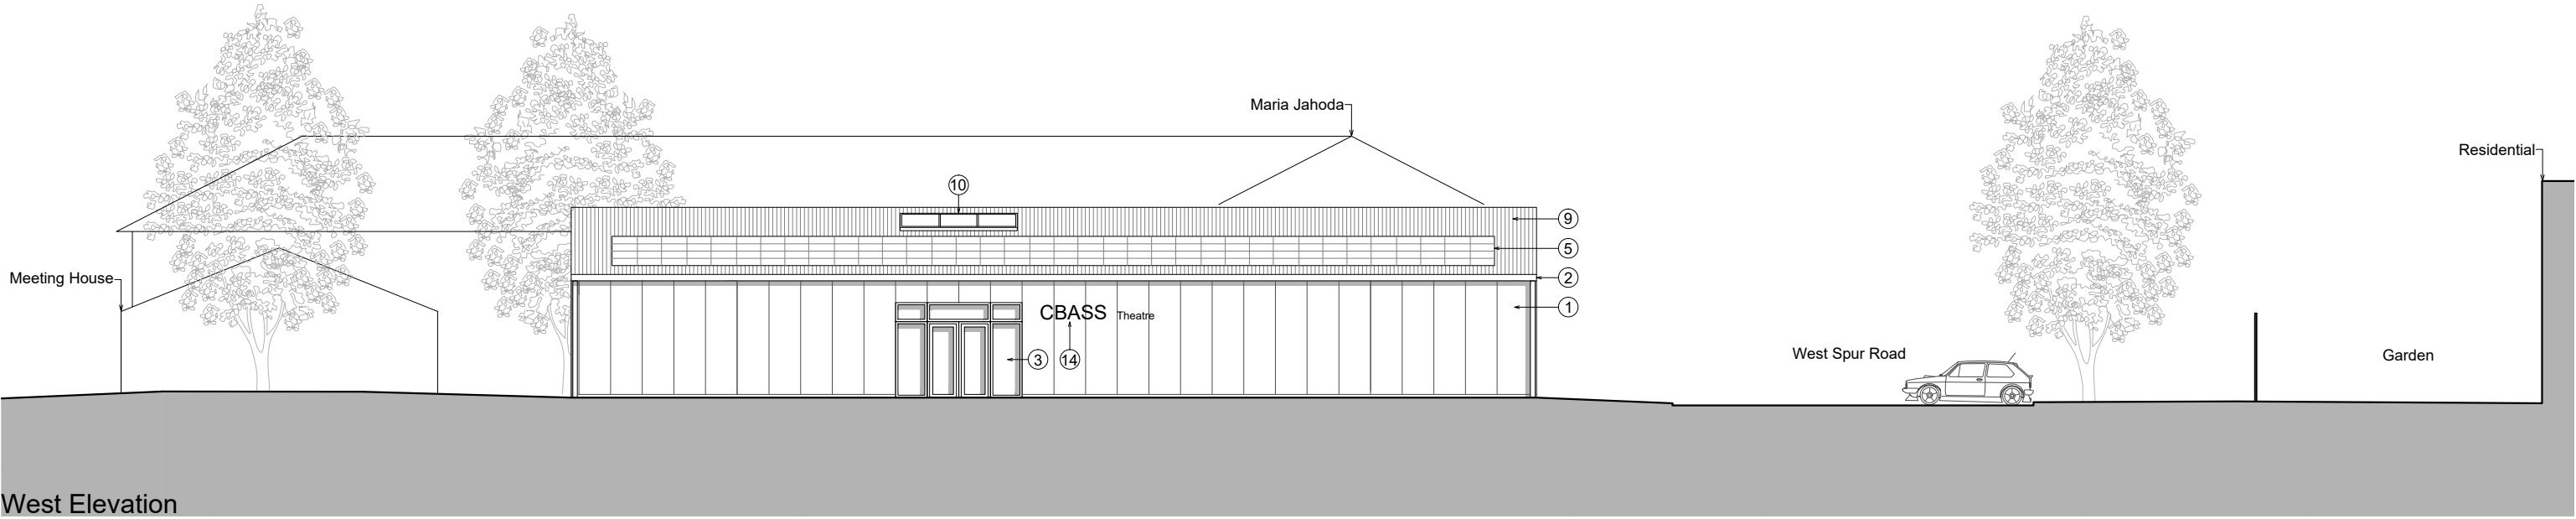


- Key
- 1. Aluminium cladding panels. Powder coated RAL 7035
 - 2. Aluminium gutters, roof flashing and downpipes. Powder coated RAL 7035
 - 3. Aluminium door/ glazing system
 - 4. Concertina doors for equipment access
 - 5. PV Panels
 - 6. Galvanised steel spiral around flue
 - 7. Aluminium louvres. Colour to match cladding
 - 8. Air source heat pump
 - 9. Aluminium faced insulated roof panels. RAL 7035

- 10. Aluminium fixed roof light
- 11. Engineering brick plinth/wallbase
- 12. Gas canister storage in cage
- 13. Powder coated steel fence/gate
- 14. Indicative Signage

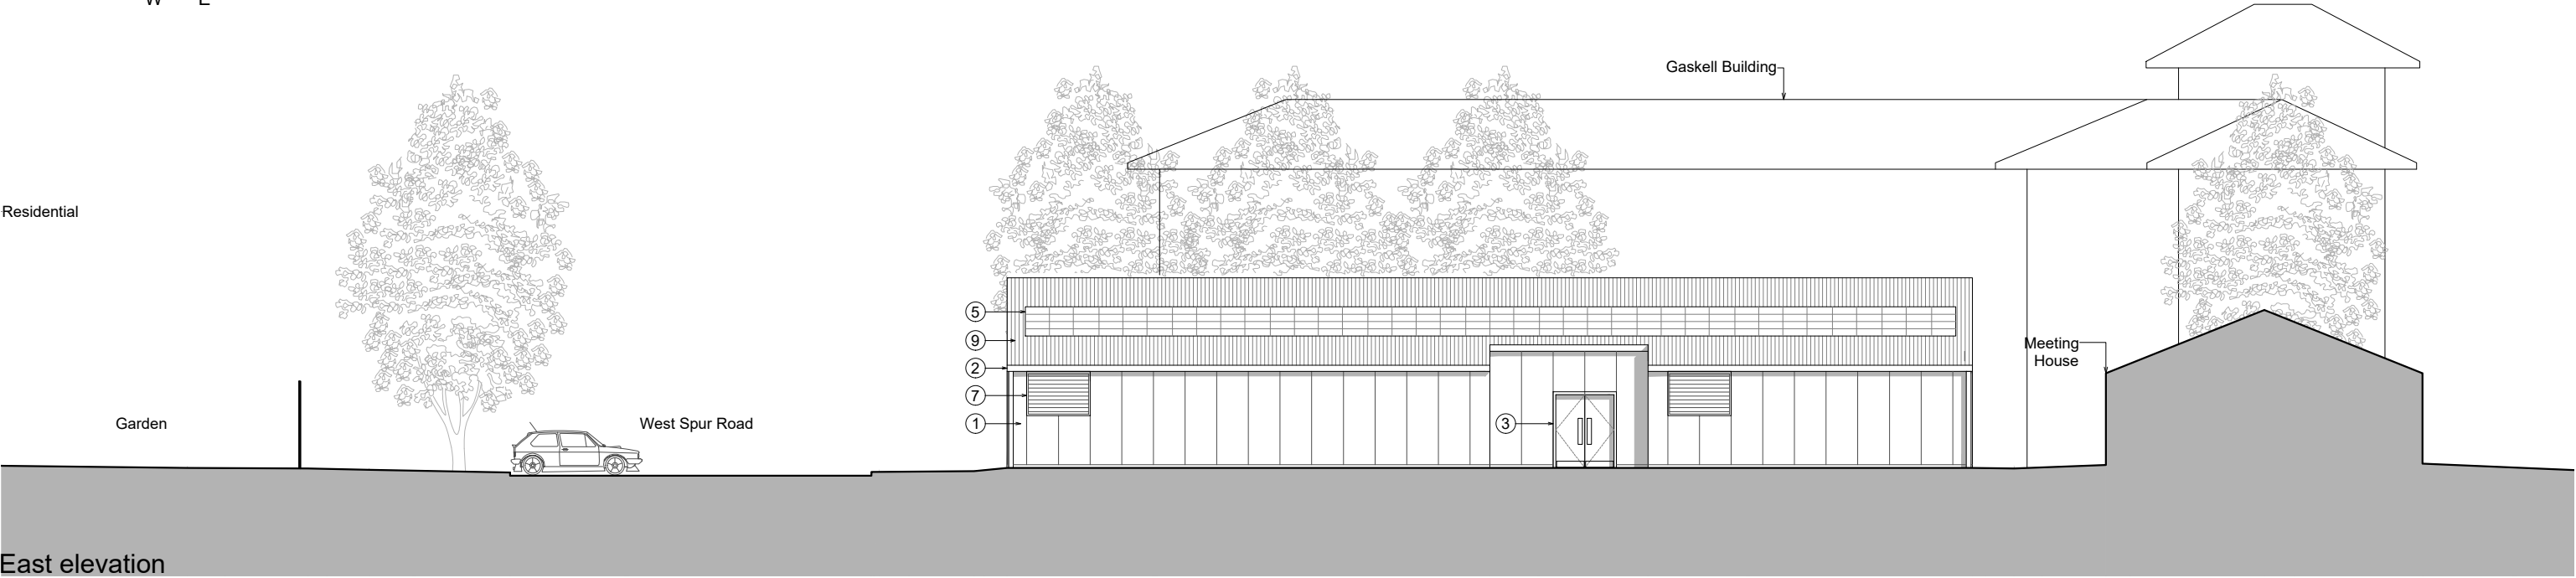

<div>DRAWING NOTES</div> <div>1. filename: Proposed Elevation Building 2.dwg</div> <div>2. Do not scale this drawing in either paper or digital form. Use figured dimensions only. Detailed site survey to be carried out to establish tolerances. Figured dimensions are in mm. All dimensions shall be verified on site before proceeding with the work. The architect shall be notified of any discrepancies.</div> <div>3. This drawing has been produced for sole use on this project and is not intended for use by any other person or for any other purpose. © Copyright RSS (U.K.)</div> <div>4. All printed copies should be made at 100% of the original page size. Use scale bars, where included, to check that the drawing has been printed to the intended scale as identified in the drawing title block.</div> <div>5. This drawing is not intended for construction unless specifically described as such.</div>		<div>REVISIONS</div> <table><tr><th>REV</th><th>DATE</th><th>STATUS</th></tr><tr><td>P01</td><td>19.04.24</td><td>For planning</td></tr></table> <div>Changes since last issue:</div> <div>-</div>		REV	DATE	STATUS	P01	19.04.24	For planning	<div>28 NAVIGATION ROAD LONDON E3 3TG</div> <div>T : 020 7739 8945</div> <div>E : rss@rssa.co.uk</div> <div>www.rivingtonstreetstudio.co.uk</div> <div>rivingtonstreetstudio</div>		<div>job title Brunel University RAAC Replacement Buildings</div> <div>drawing title Proposed East & West Elevation Site for Building 2</div>		<table><tr><td>drawn by</td><td>job no.</td><td>suitability</td><td>revision</td><td>PROJECT</td><td>ORIGIN.</td><td>VOLUME</td><td>LEVEL</td><td>TYPE</td><td>ROLE</td><td>NUMBER</td></tr><tr><td>RT /JY</td><td>1061</td><td>S3</td><td>P01</td><td>BUR</td><td>RSS</td><td>00</td><td>ZZ</td><td>DR</td><td>A</td><td>1411</td></tr></table> <div>scale 1:200</div>		drawn by	job no.	suitability	revision	PROJECT	ORIGIN.	VOLUME	LEVEL	TYPE	ROLE	NUMBER	RT /JY	1061	S3	P01	BUR	RSS	00	ZZ	DR	A	1411
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