




**Existing First Floor Plan**  
Scale 1:100

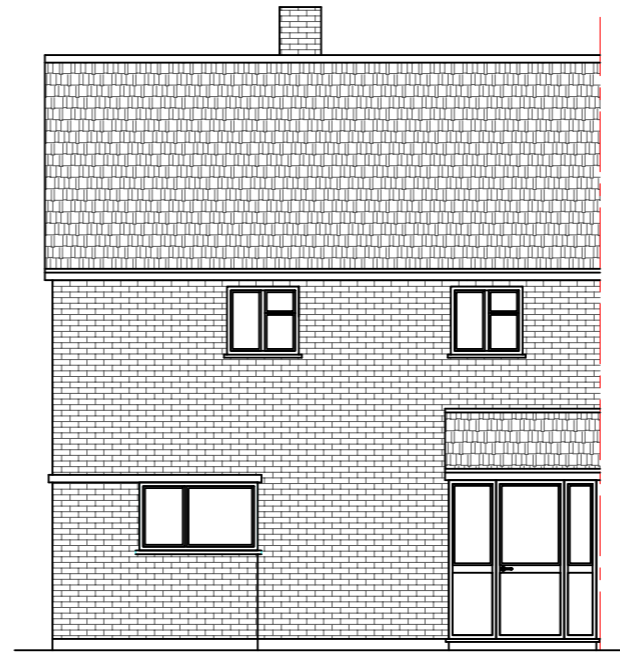


**Existing Front Elevation**  
Scale:1:100

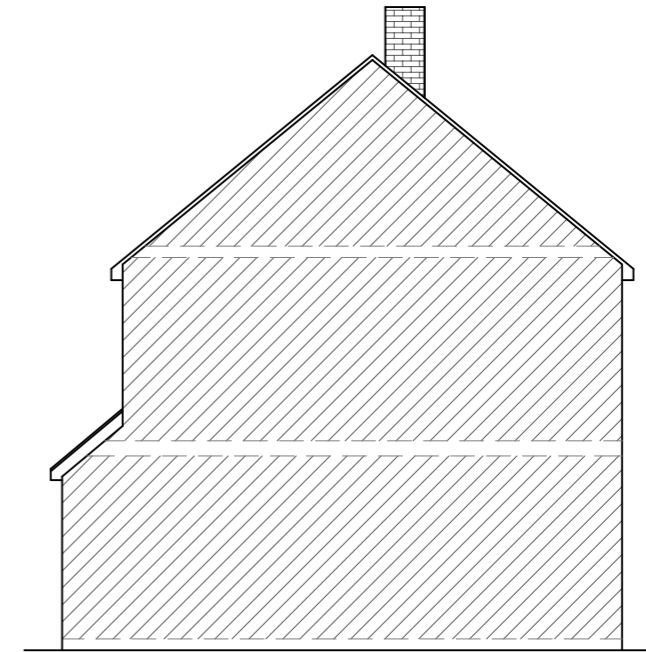


**Existing Side Elevation**  
Scale:1:100

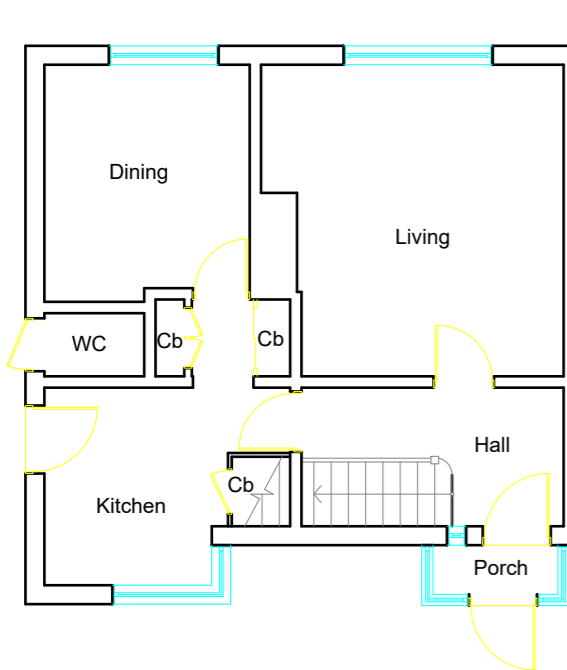

**Existing Ground Floor Plan**  
Scale 1:100

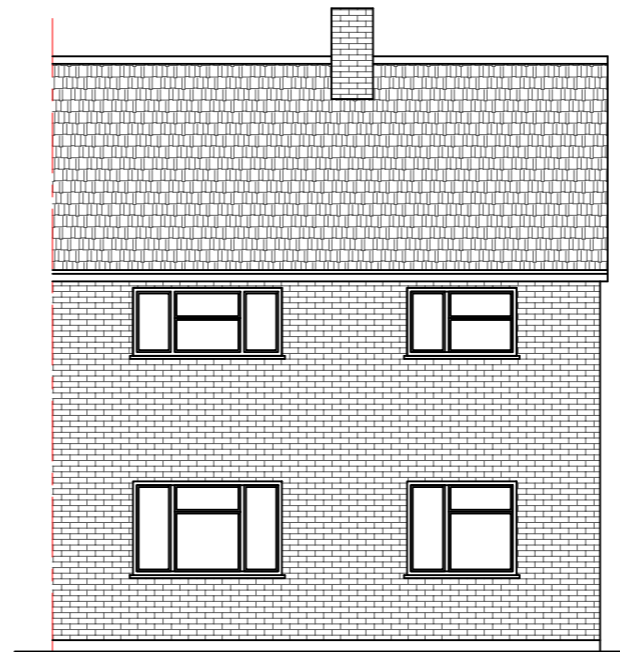

**Existing Rear Elevation**  
Scale:1:100

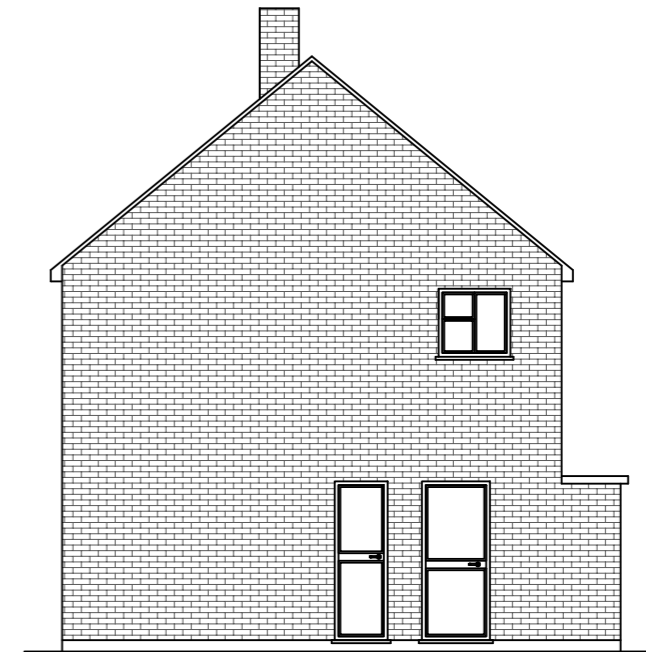


**Existing Side Elevation**  
Scale:1:100




	Project:	Title:	Scale: 1:100 @ A3
	8 Abbott's Close	Existing Floor Plans	Date: 12.05.2026
	Uxbridge	Existing Elevations	Drawing No.:
	UB8 3RY		LBA 5006 - 01/LB
			Revision
info@lbarchigroup.co.uk		Mob: 07710410150	

All work to comply with current building regulations and codes of practice


Proposed External Finish Materials to Match Existing External Finish Materials

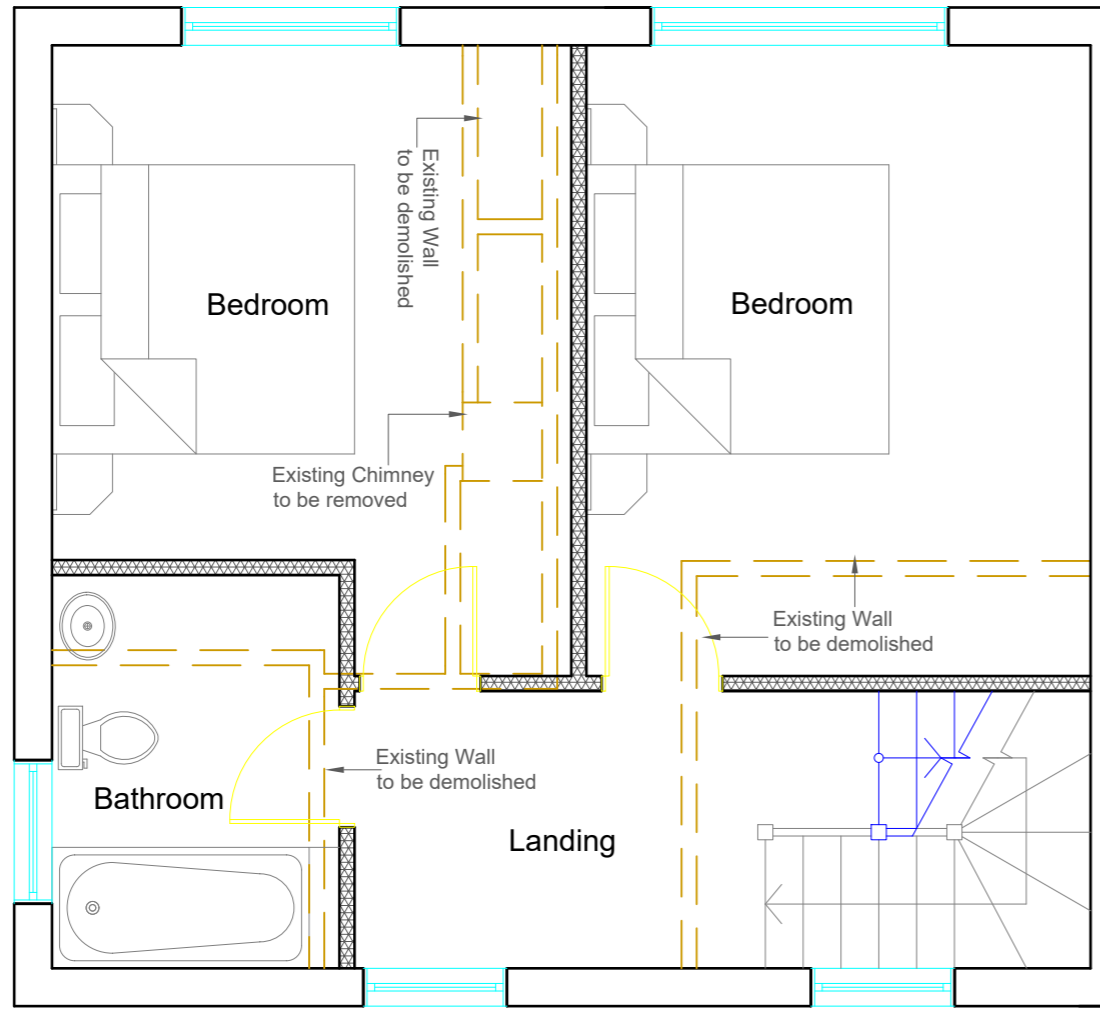

**Proposed First Floor Plan**  
Scale 1:50

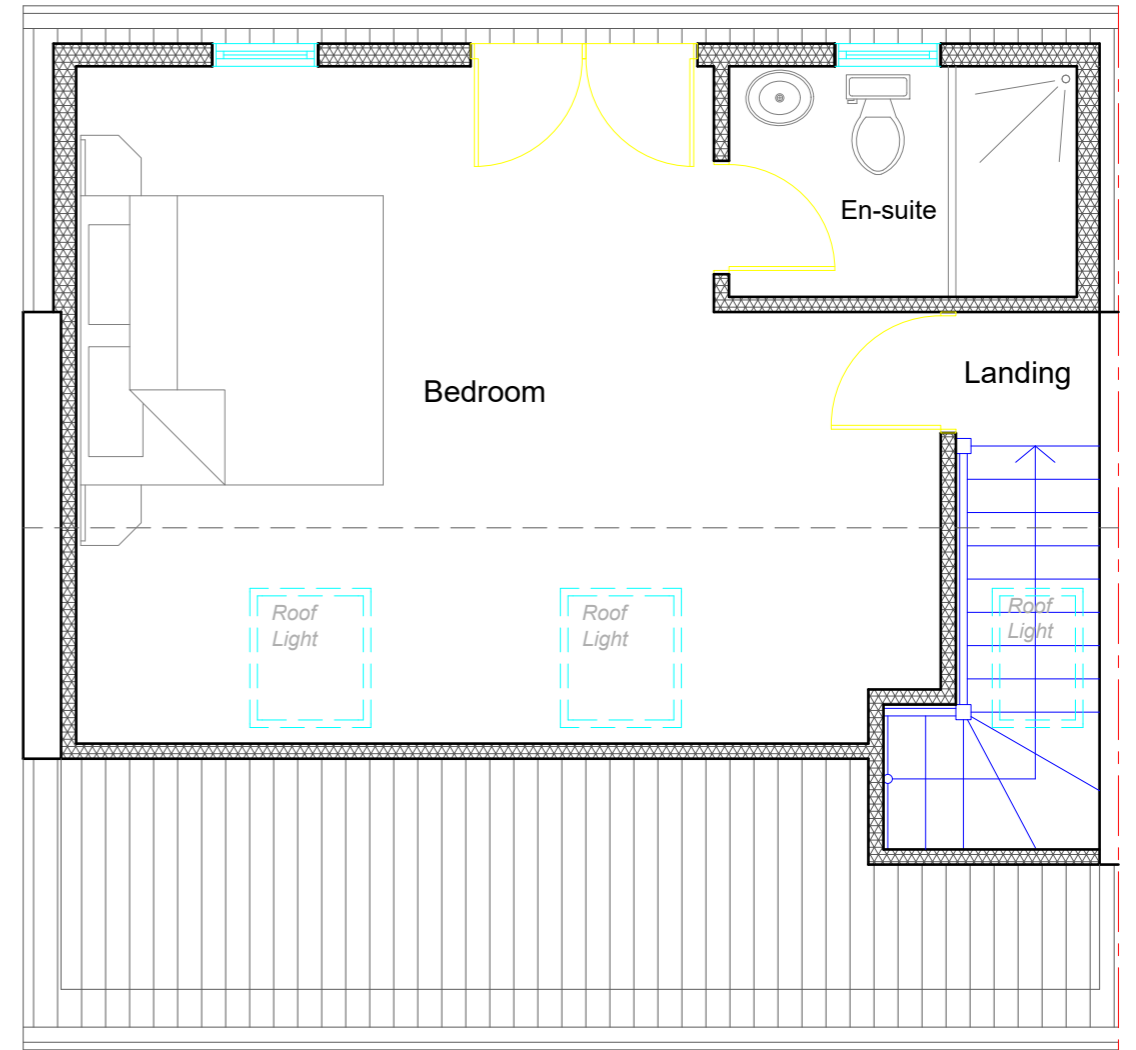

**Proposed Loft Floor Plan**  
Scale 1:50

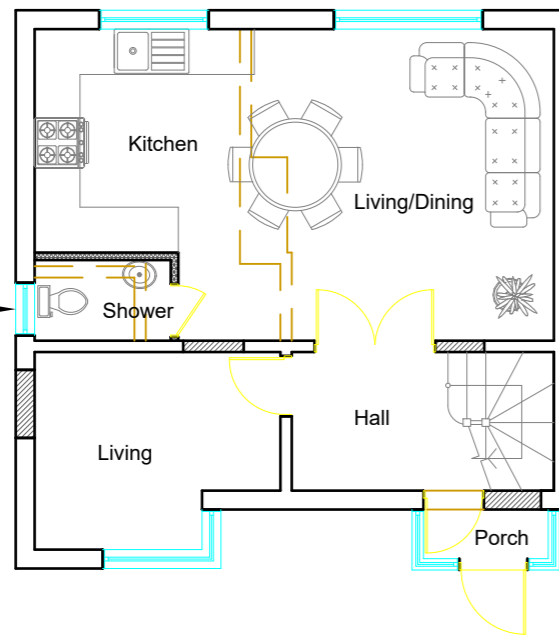


Proposed Flank Wall Window to be Obscure Glazed and Non Opening below 1.7m from FFL

**Proposed Ground Floor Plan**  
Scale 1:100

1:50



1:100

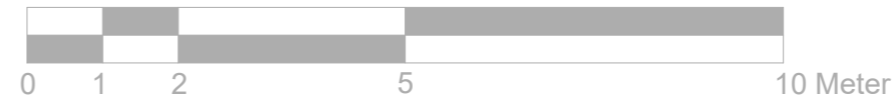


	Project:	Title:	Scale: 1:50;100 @ A3
	8 Abbott's Close Uxbridge UB8 3RY	Proposed Floor Plans	Date: 12.05.2026
			Drawing No.:
			LBA 5006 - 02/LB
		Revision	
info@lbarchigroup.co.uk		Mob: 07710410150	


All work to comply with current building regulations and codes of practice

Proposed External Finish Materials to Match Existing External Finish Materials


Roof Lights to be installed as per manufacturer specification, not projected more than 150mm from the plane of roof slop

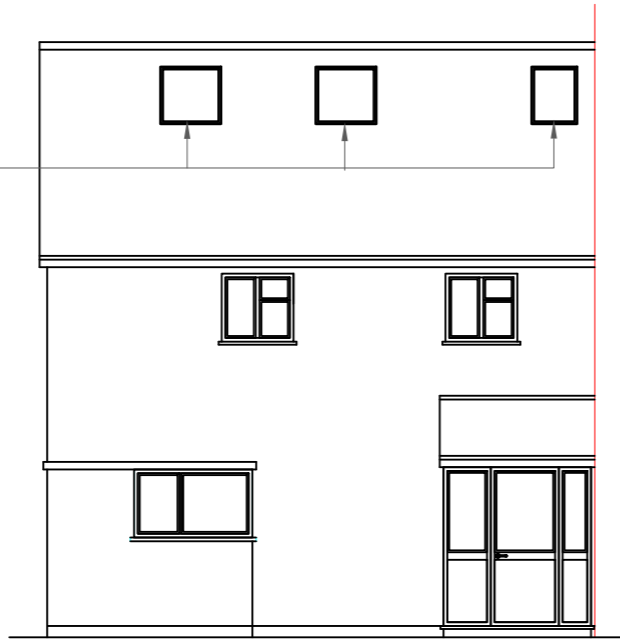


Proposed Front Elevation  
Scale:1:100

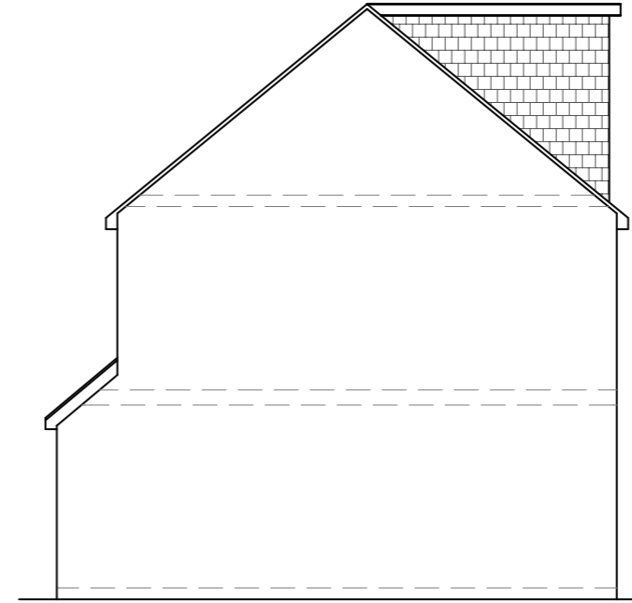

Proposed Side Elevation  
Scale:1:100

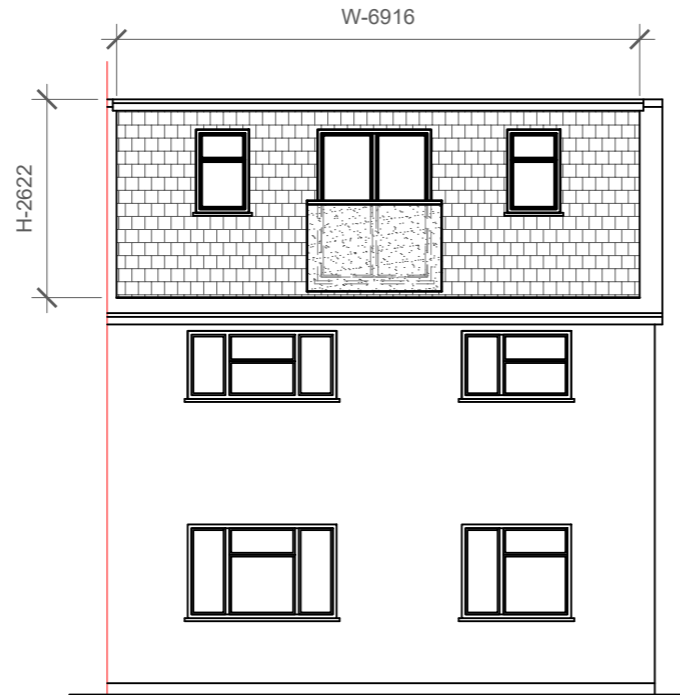

Proposed Rear Elevation  
Scale:1:100

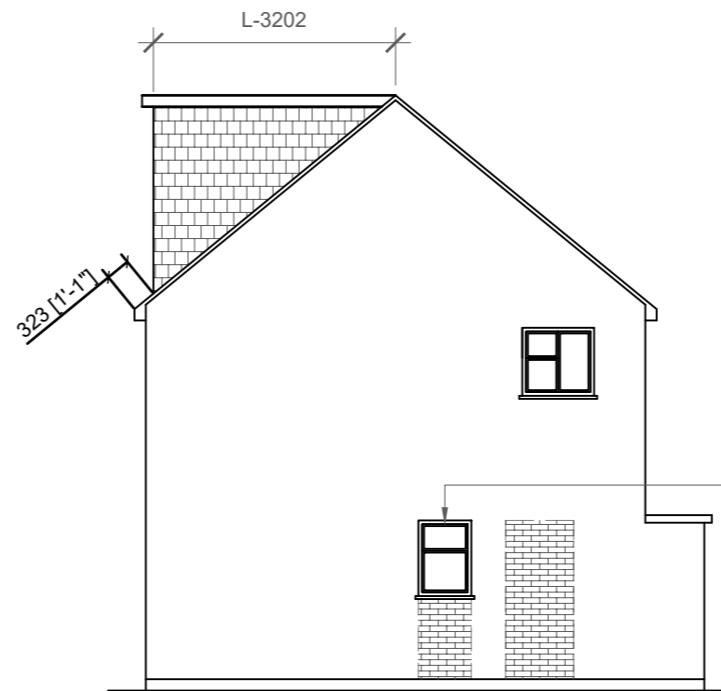

Proposed Side Elevation  
Scale:1:100

Proposed Flank Wall Window to be Obscure Glazed and Non Opening below 1.7m from FFL


REAR DORMER VOLUME =  $W \times L \times H/2$   
 =  $6.916 \times 3.202 \times 2.622 / 2$   
 =  $58.06 / 2$   
 TOTAL VOLUME =  $29.03 \text{ CU.MT} < 50 \text{ CU.MT.}$




	Project:	Title:	Scale: 1:100 @ A3
	8 Abbott's Close Uxbridge UB8 3RY	Proposed Elevations	Date: 12.05.2026
			Drawing No.: LBA 5006 - 03/LB
			Revision
info@lbarchigroup.co.uk		Mob: 07710410150	

All work to comply with current building regulations and codes of practice


Proposed External Finish Materials to Match Existing External Finish Materials

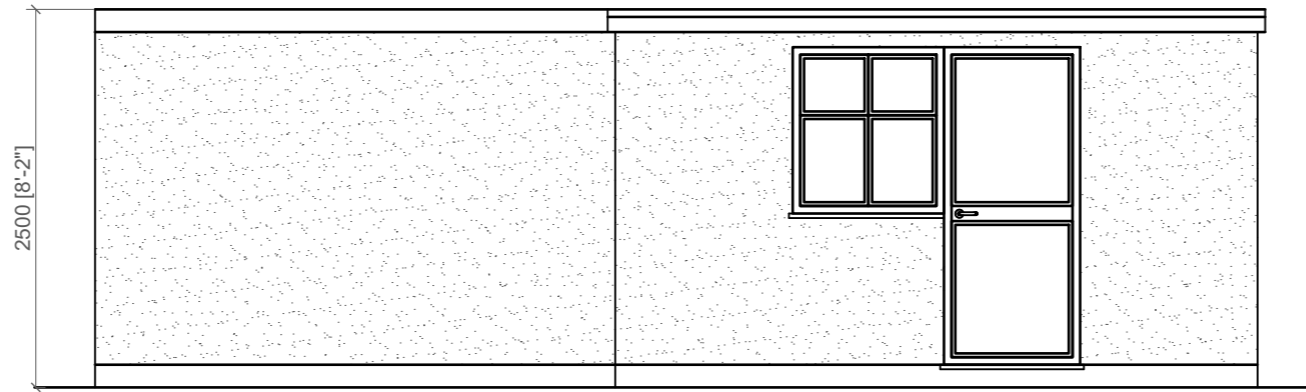


**Proposed Front Elevation**  
Scale:1:50

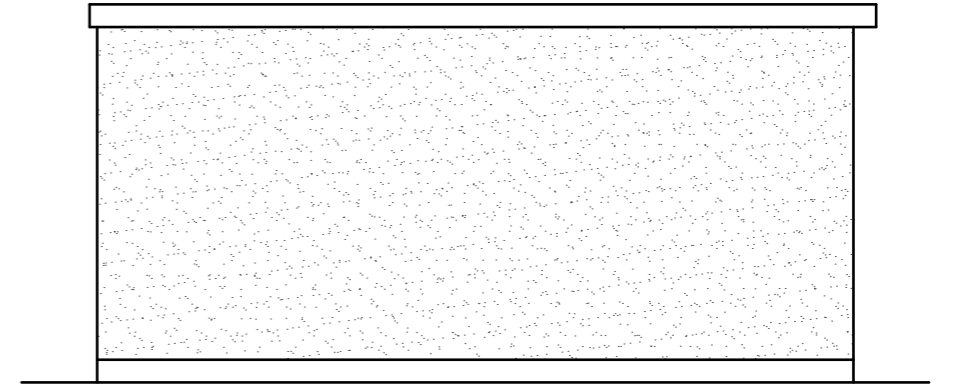

**Proposed Side Elevation**  
Scale:1:50

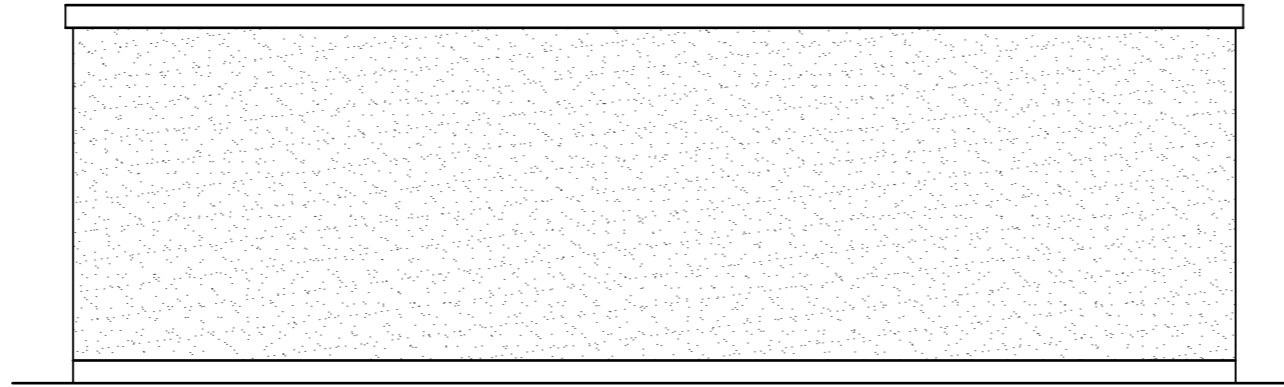


**Proposed Rear Elevation**  
Scale:1:50

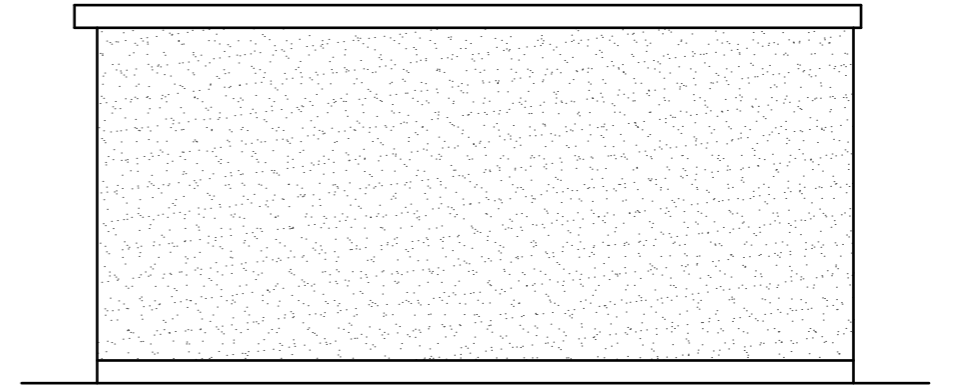


**Proposed Side Elevation**  
Scale:1:50

1:50

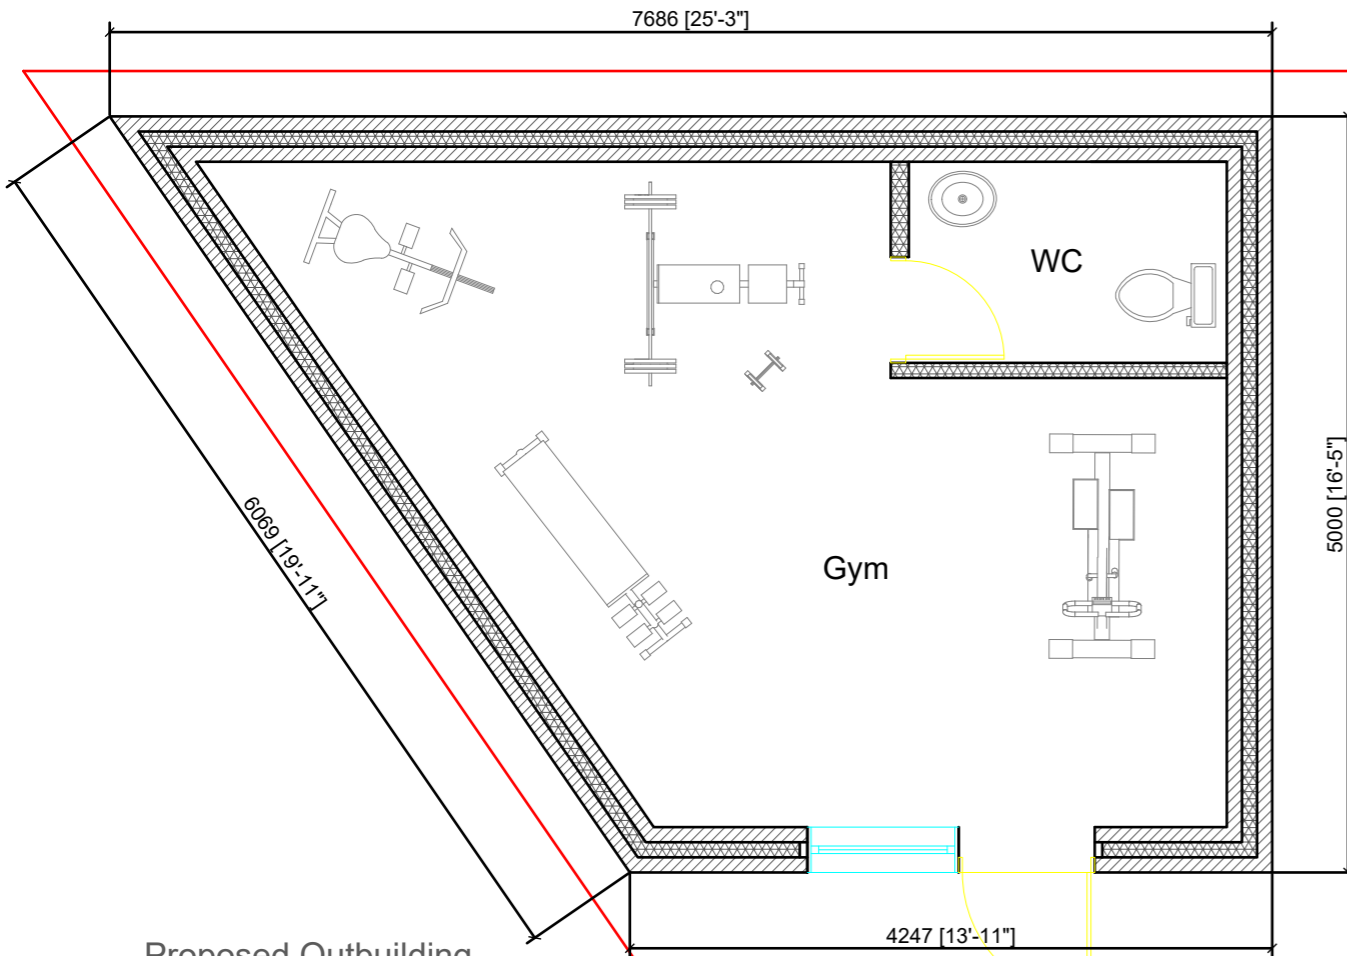

**Proposed Outbuilding**  
Scale:1:50

	<b>Project:</b> 8 Abbott's Close Uxbridge UB8 3RY								
	<b>Title:</b> Proposed Outbuilding Proposed Elevations								
<b>Scale:</b> 1:50 @ A3 <b>Date:</b> 12.05.2026 <b>Drawing No.:</b> LBA 5006 - 04/LB <b>Revision</b>	<table border="1"> <tr> <td> </td> <td> </td> <td> </td> <td> </td> </tr> <tr> <td> </td> <td> </td> <td> </td> <td> </td> </tr> </table>								
info@lbarchigroup.co.uk ; Mob: 07710410150									