



EXISTING FRONT ELEVATION

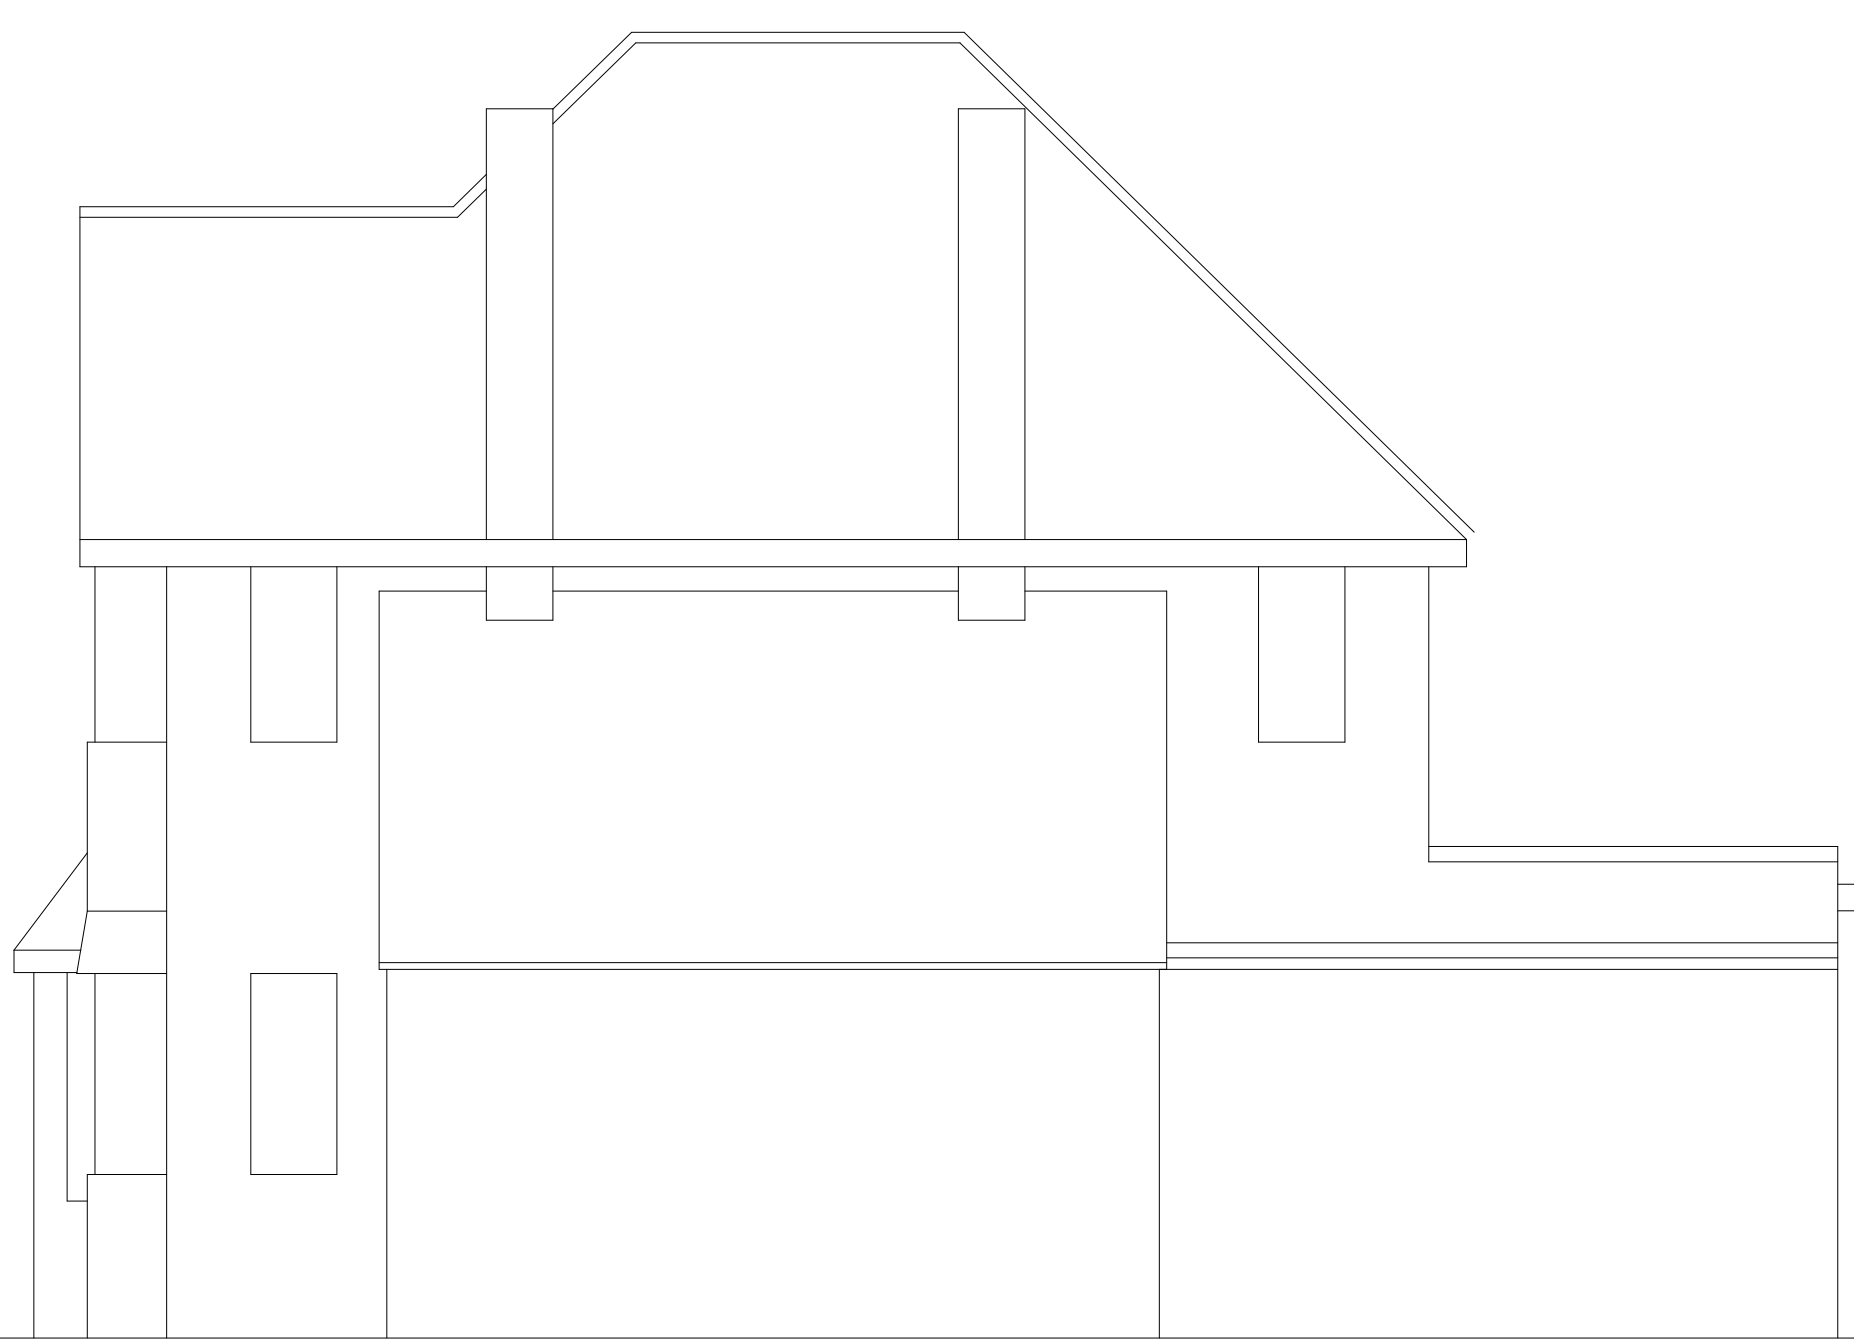

EXISTING SIDE ELEVATION

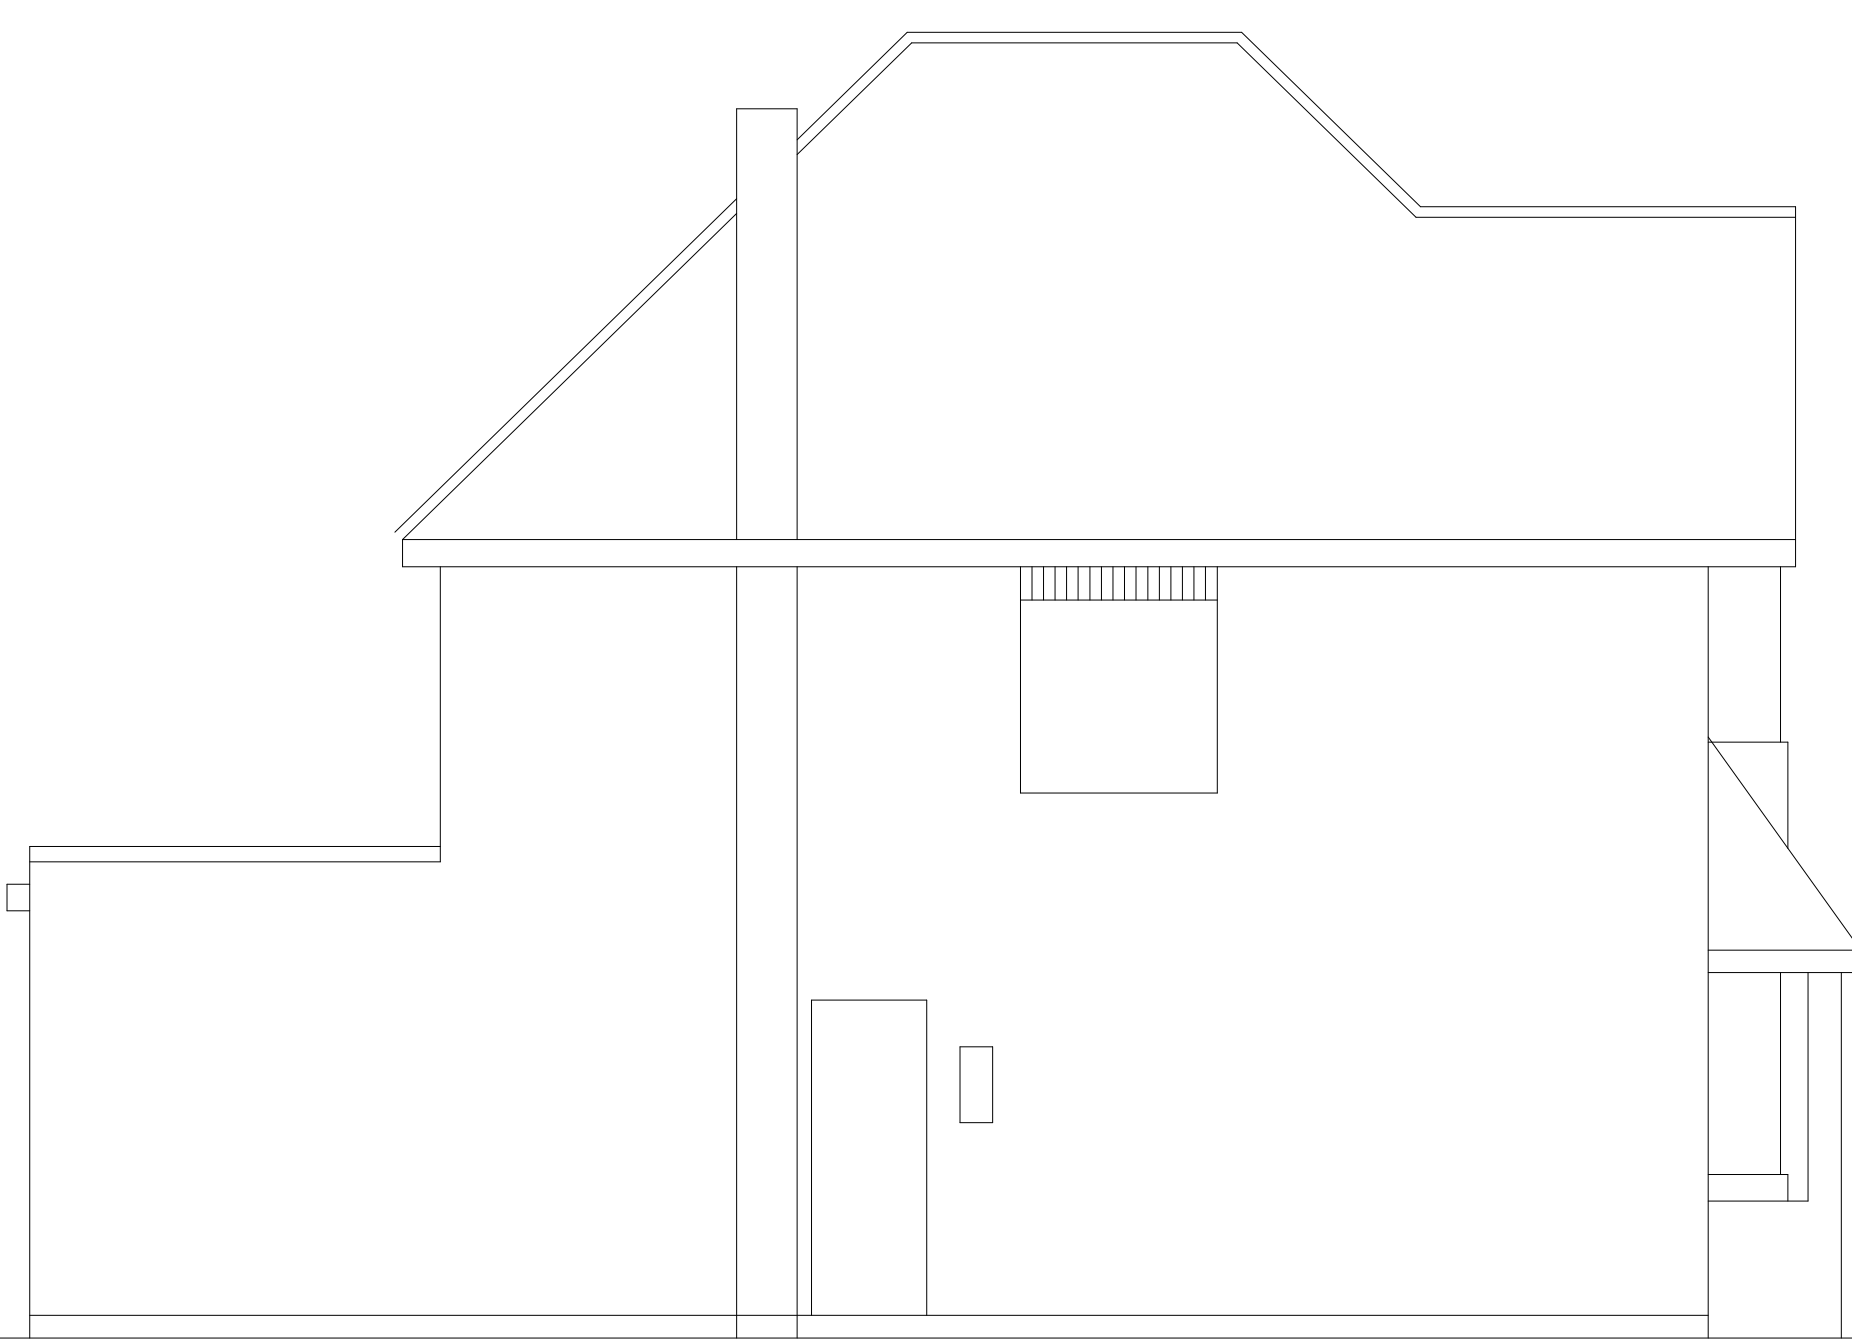


EXISTING SIDE ELEVATION




EXISTING REAR ELEVATION

velux window will not project more than 150mm from roof plane


Obscure glazed windows, openable vents all above 1.7m from finished floor level

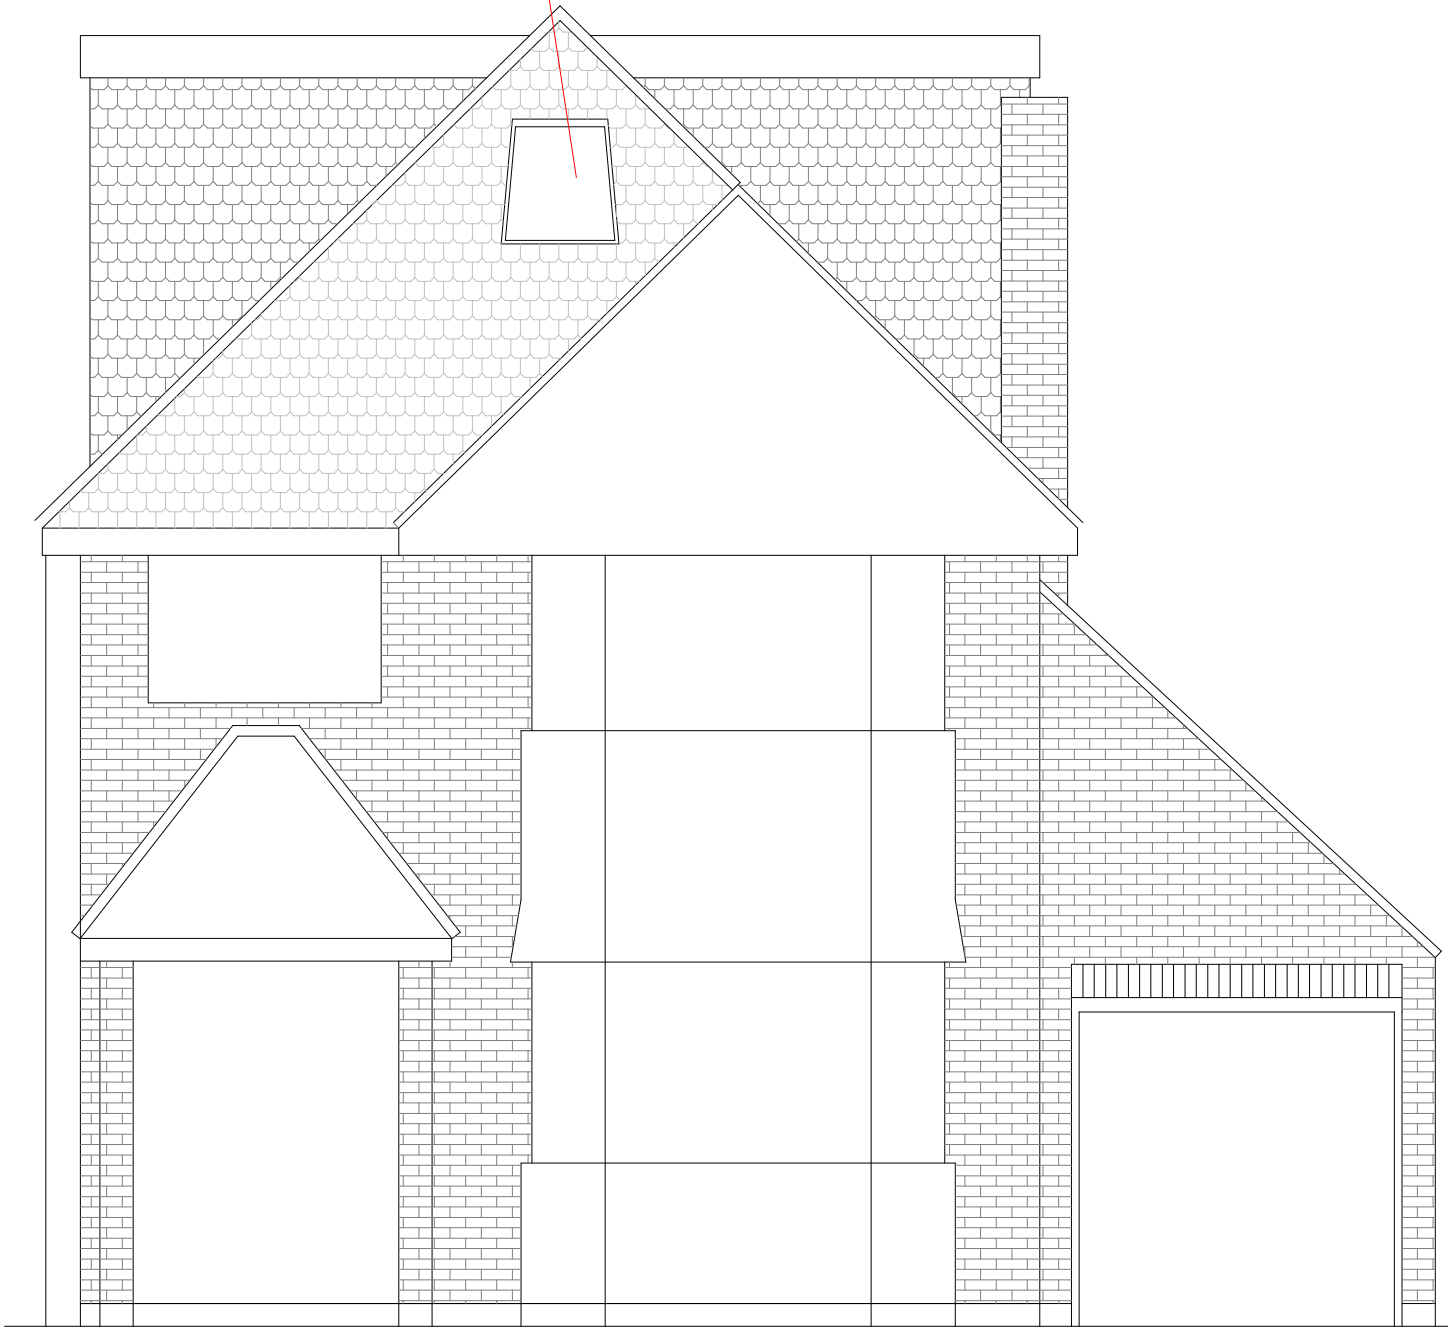


EXISTING FRONT ELEVATION

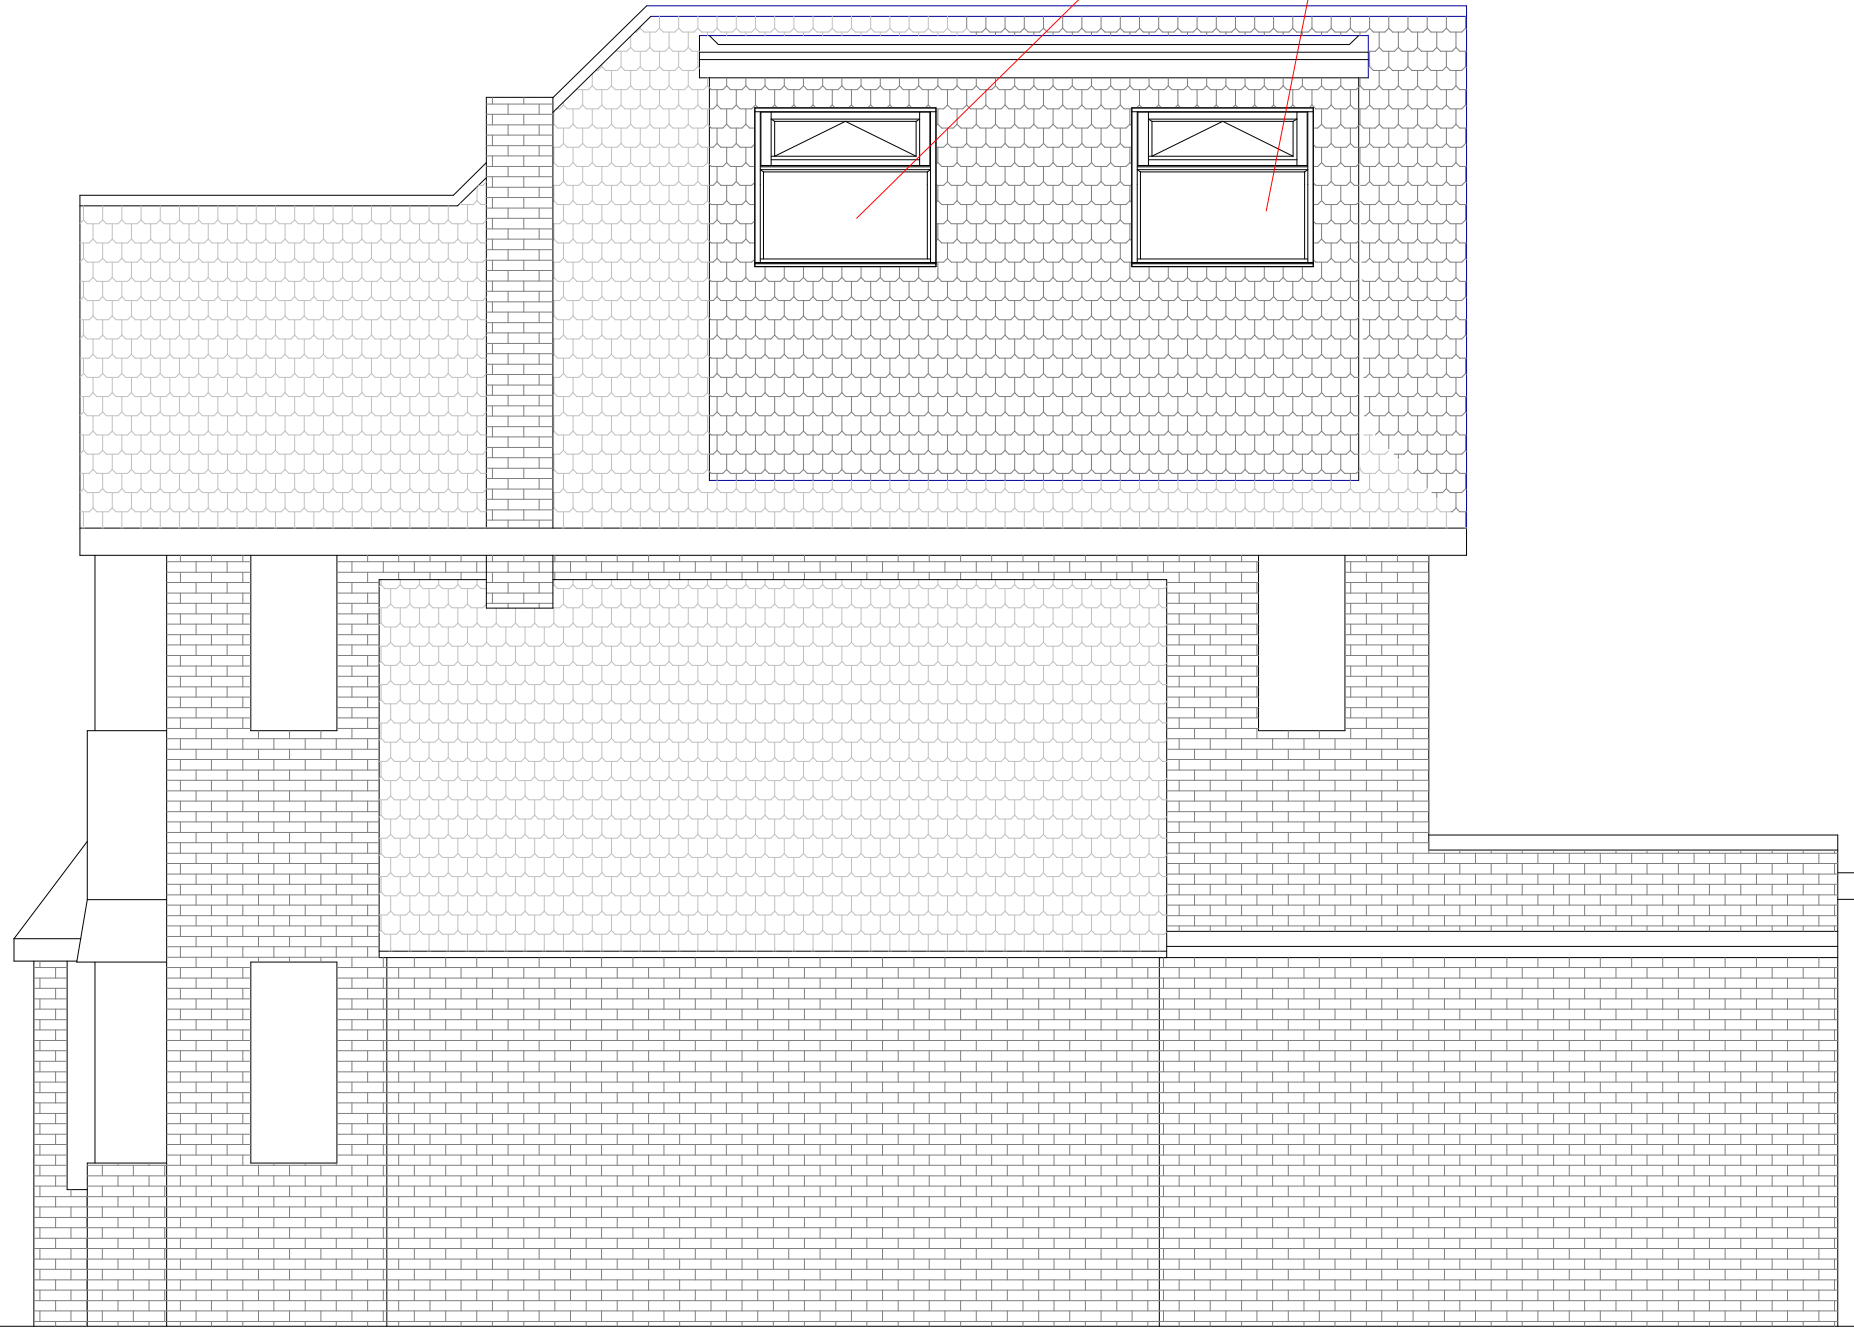

EXISTING SIDE ELEVATION

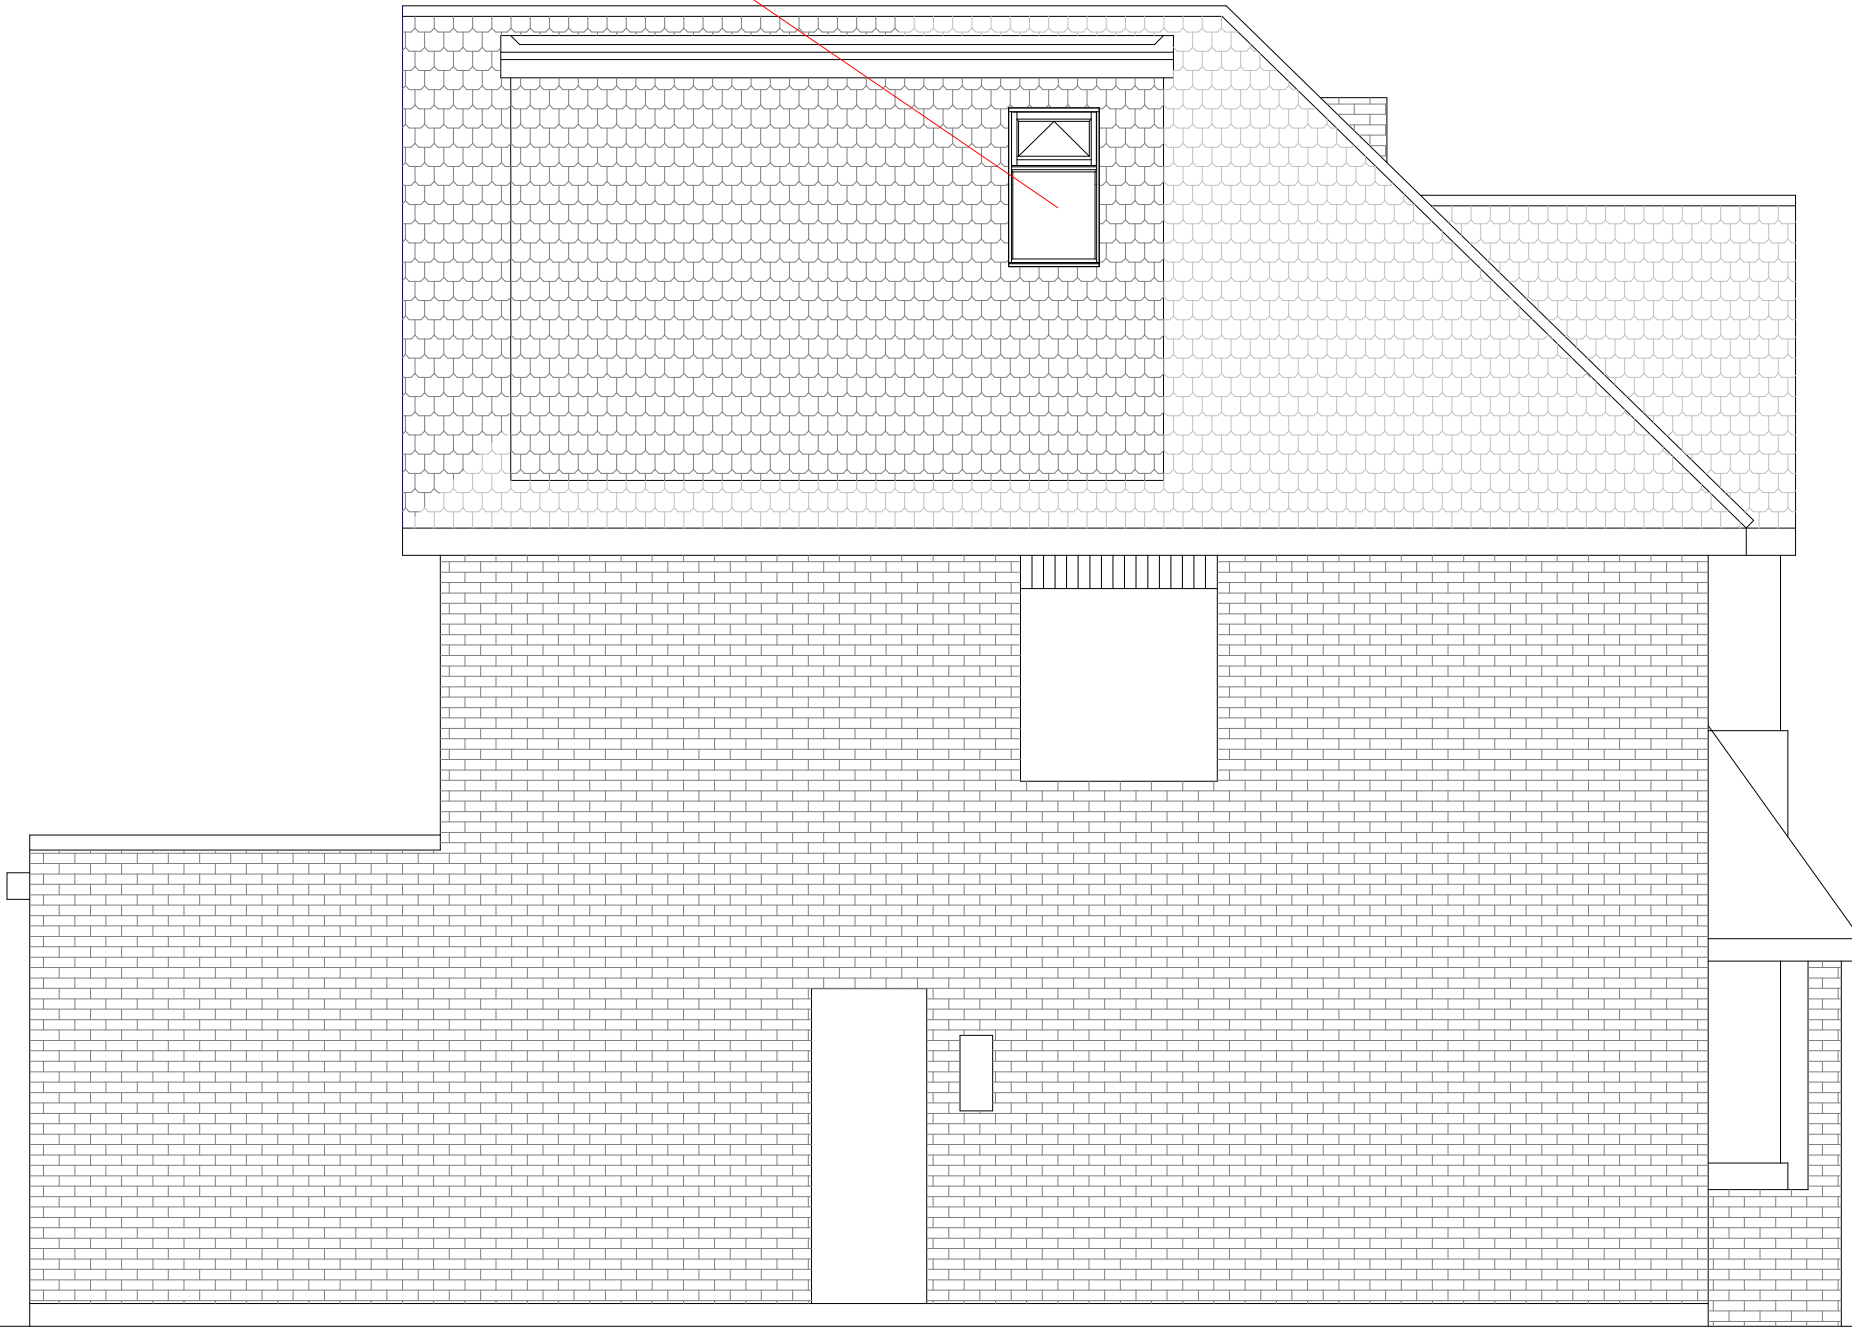

EXISTING SIDE ELEVATION

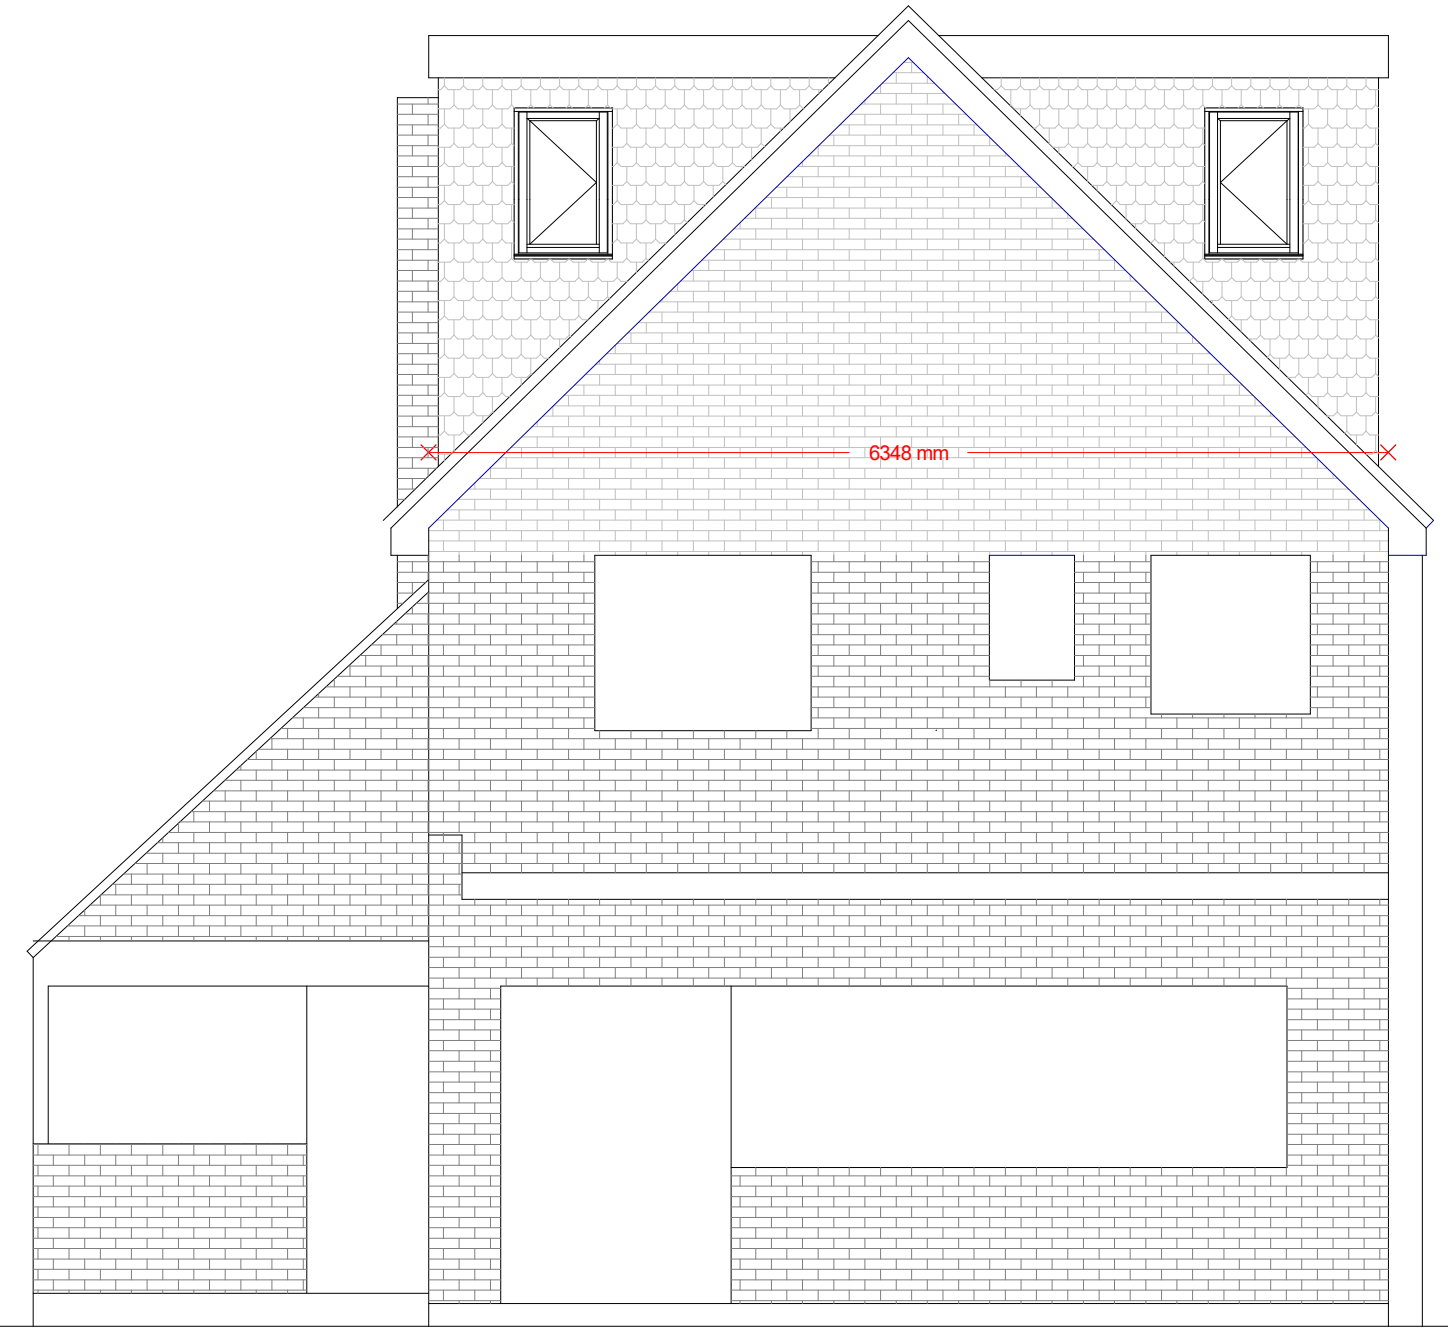

EXISTING REAR ELEVATION

Dormer Windows
 $4.16\text{m}^2 \times 4.32\text{m} \times 2 = 35.94\text{m}^3$
Hip to Gable
 $6.34 \times 3.45 = 21.87$
 $21.87/2 = 10.93$
 $10.93/2 = 5.465$
 $5.465 \times 2.23 = 12.18\text{m}^3$

91 St Georges Drive
Ickenham



PLAN

PROJECT

Proposed Elevations

Loft Conversion

DWG No

2
Rev: - a

Date: July 2022

Project: 30 St Georges Drive, Ickenham

Scale 1:50 @ A0

Checked: AW

Drawing Title: Plans

Status: Planning

Job No: 406

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