




EXISTING DWELLING
SIDE ELEVATION



EXISTING DWELLING
REAR ELEVATION



EXISTING DWELLING
FRONT ELEVATION

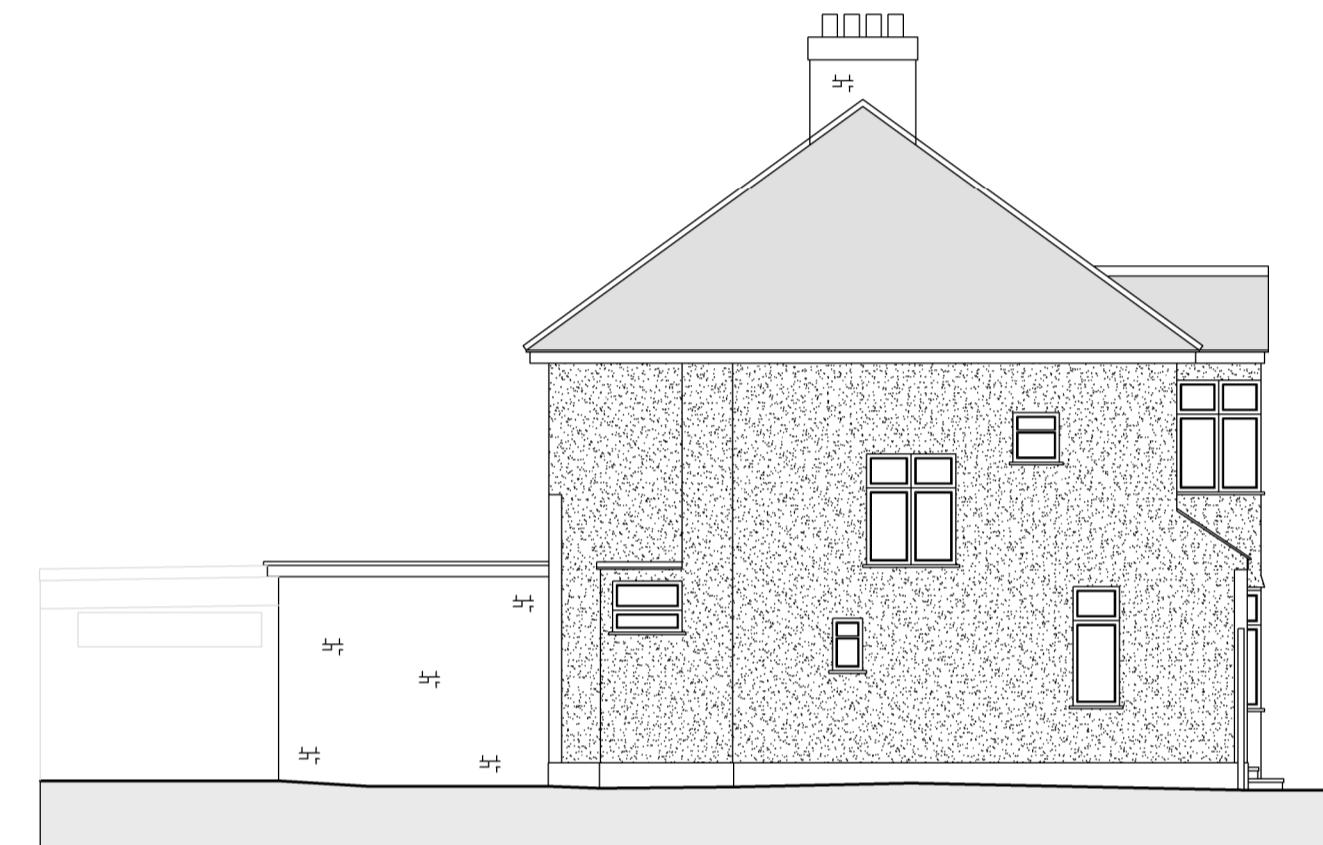

EXISTING DWELLING
SIDE ELEVATION



PROPOSED DWELLING
SIDE ELEVATION




PROPOSED DWELLING
REAR ELEVATION




PROPOSED DWELLING
FRONT ELEVATION




PROPOSED DWELLING
SIDE ELEVATION

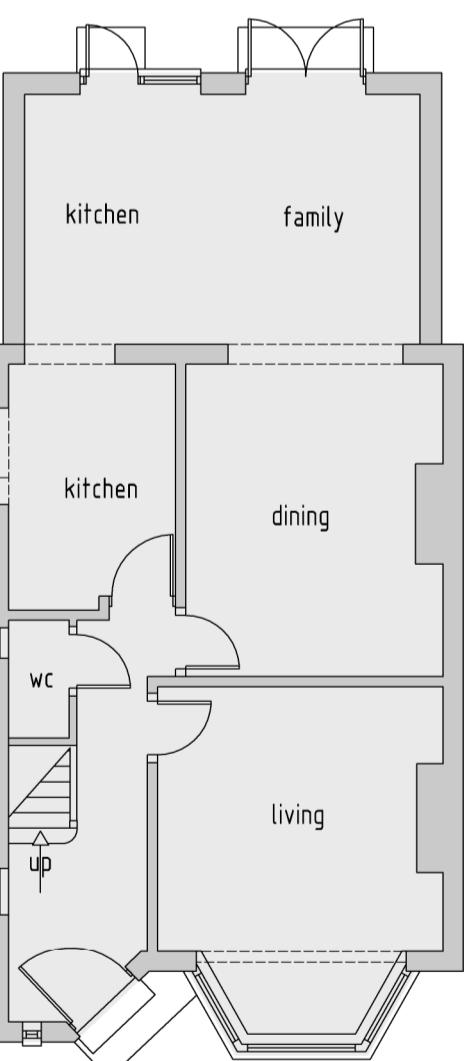


EXISTING DWELLING
GROUND FLOOR PLAN

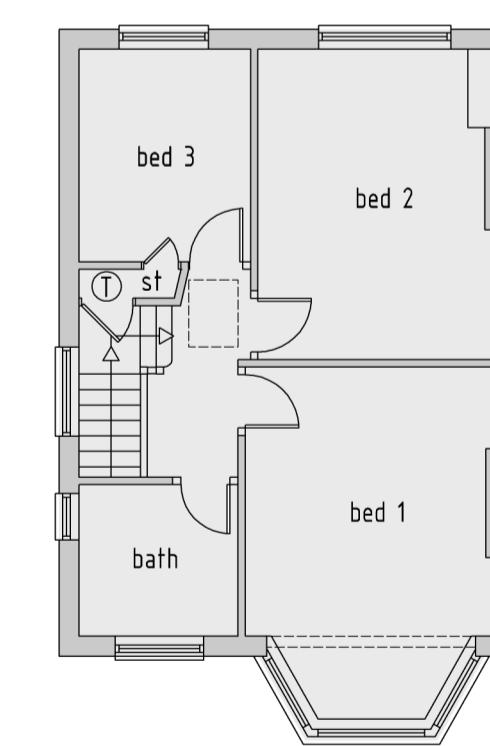


EXISTING DWELLING
FIRST FLOOR PLAN

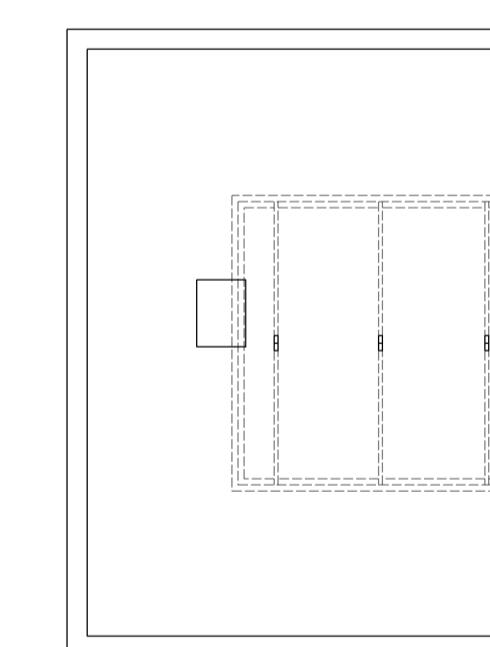


EXISTING DWELLING
LOFT FLOOR PLAN

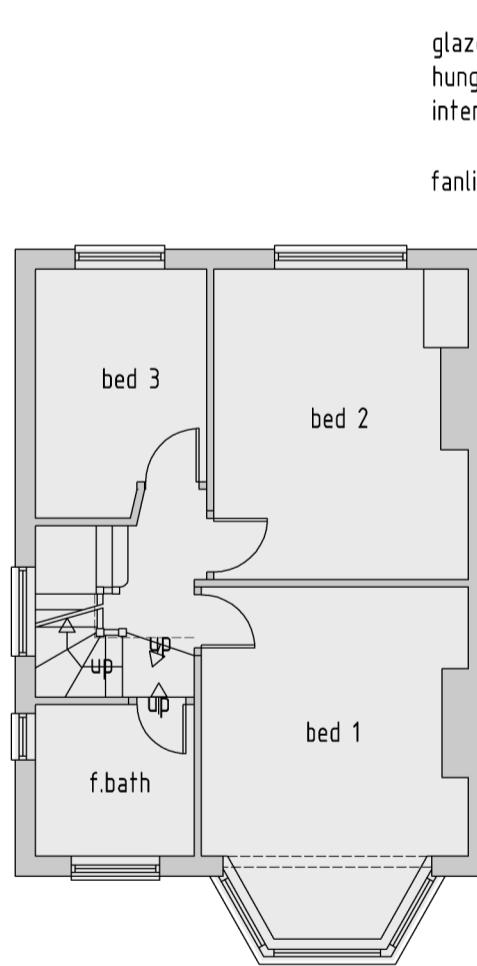

PROPOSED DWELLING
FIRST FLOOR PLAN

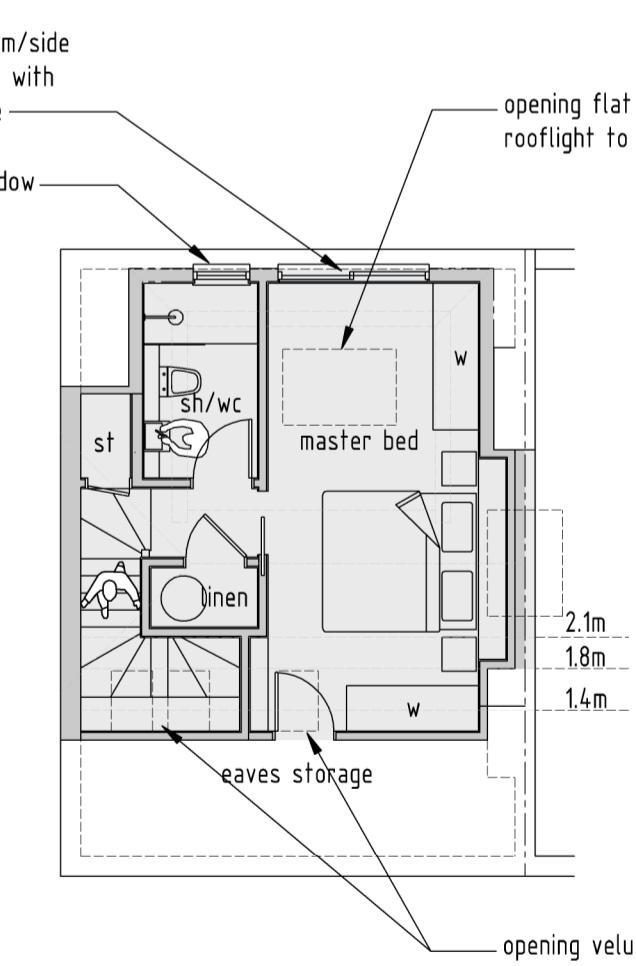

PROPOSED DWELLING
LOFT FLOOR PLAN

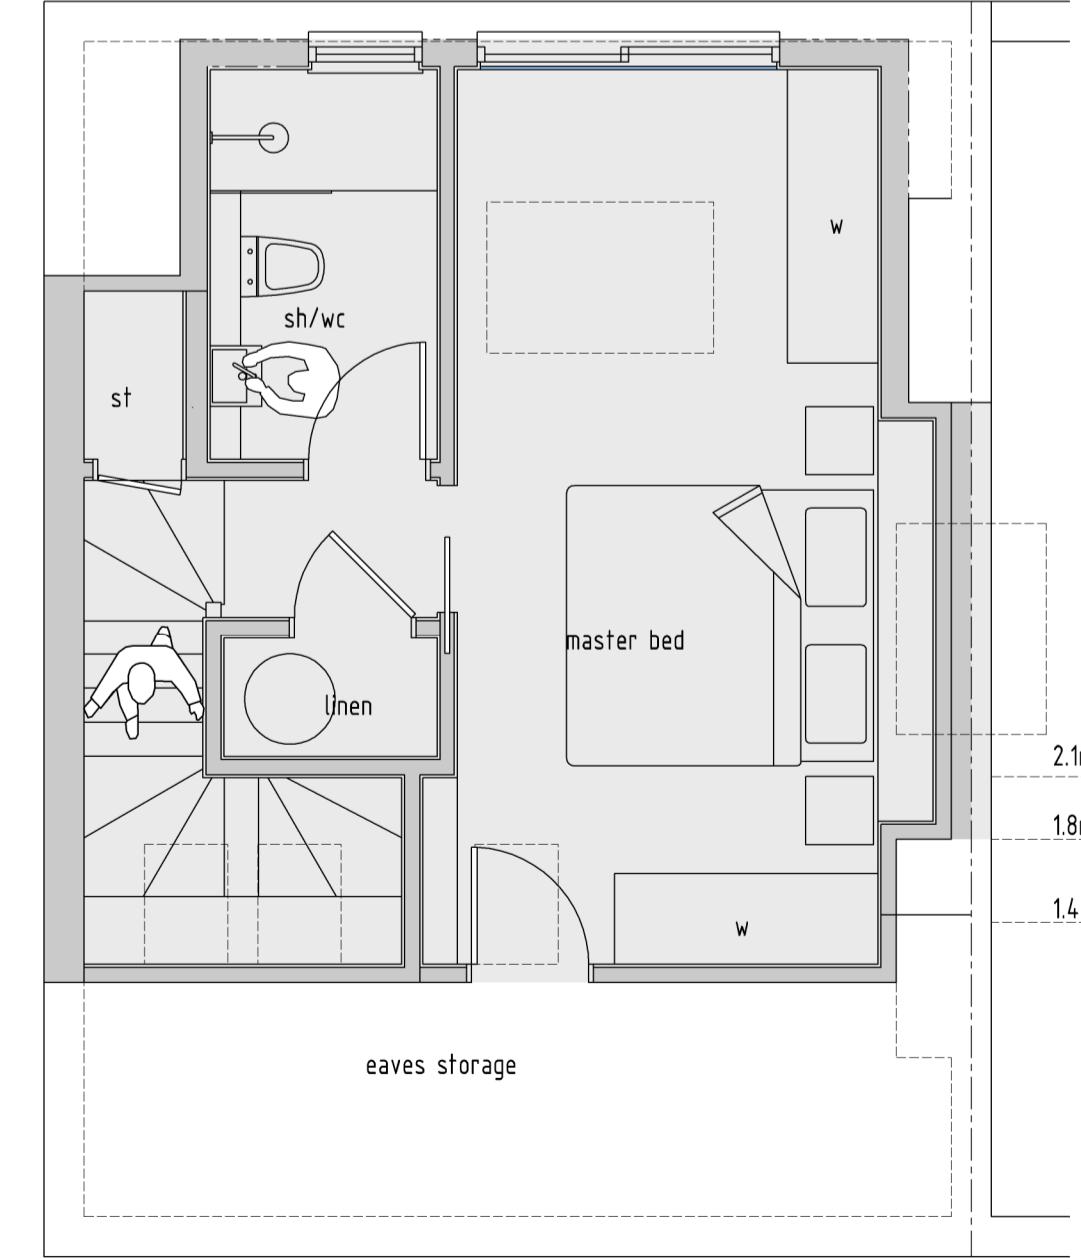

PROPOSED DWELLING
LOFT FLOOR PLAN
SCALE 1:50

HIP TO HALF GABLE CONVERSION
A - B = C
A= (H x L x W / 6)
B= (H x L x W / 6)

A = 8.9 x 3.23 x 4.47
128.5 / 6 = 21 m³

B = 3.9 x 1.42 x 2.41
13.4 / 6 = 2.2 m³

C = 21 - 2.2
= 18.8 m³

2057 4474 14.40 3233 8900 3408 857


325 14.23 3916 5122 4797

1.83 m² 0.55 m² 2.15 m²

HIPPED REAR DORMER
A + B + C = D
A= 4.82 x 2.15 m² = 10.363 m³
B= 5.11 x 0.55 m² = 2.761 m³
C= (3.4 x 1.83 m²) + (0.86 x 1.83 m²)
C= 8.73 m³

D= 10.36 + 2.76 + 8.73 = 21.85 m³

TOTAL PROPOSED VOLUME = 18.8 + 21.85 = 40.65 M³

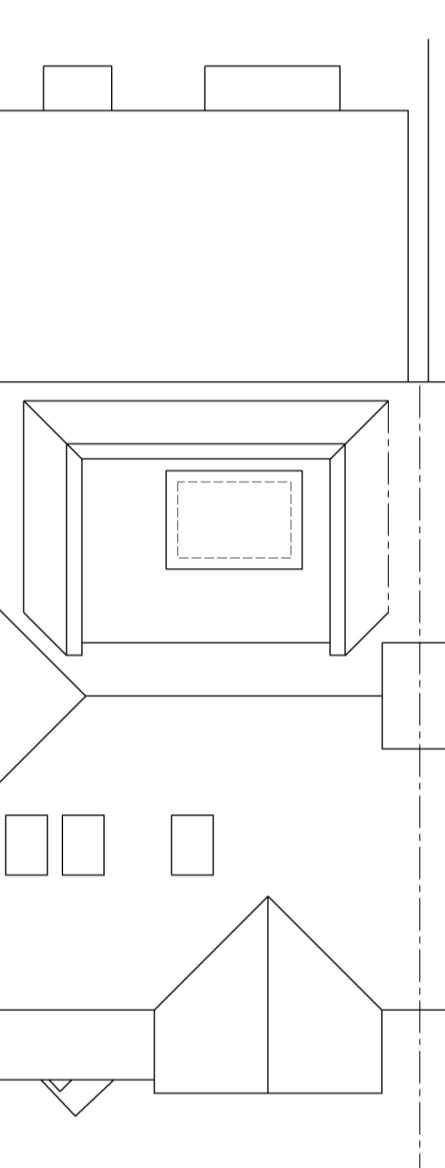

PROPOSED DWELLING
SITE LAYOUT PLAN


D 17 / 06 / 21 Client comments
C 29 / 05 / 21 Client comments
B 26 / 05 / 21 Client comments
A 19 / 05 / 21 Client comments

rev date info drawn : SC
scale: 1 : 100 / A1 date: 17 / 06 / 21 drw no: 556 / P / 10

drawing: EXISTING AND PROPOSED DWELLING
SITE PLAN, FLOOR PLANS AND ELEVATIONS

project: 3 ARLINGTON DRIVE,
RUISLIP, HA4 7RJ

client: MR & MRS BANCE

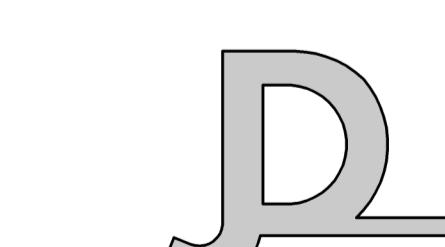


J A C K D U S E K

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NOTES
1. All dimensions are to be checked on site prior to the commencement of work and any discrepancy is to be reported to the construction manager before construction.
2. All work is to comply with current Building Regulations and allied legislation.
3. All contractors and sub-contractors must ensure that they have the latest issue of this drawing and details before the commencement of work on site.
4. All materials are to be used and installed in strict compliance with the relevant manufacturers instructions and recommendations.
5. All works on site, managed and implemented as a result of the designs indicated on this drawing, are to be given full consideration for compliance with the Health and Safety
CDM Regulations in respect of design and implementation on site and no works are to be undertaken if it is considered that compliance with the Building Regulations cannot be
achieved.
6. All dimensions shown in millimetres.
7. Footprint of buildings shown at 10m above ground level.



SCALE BAR (m)
0 2 4 6 8 10
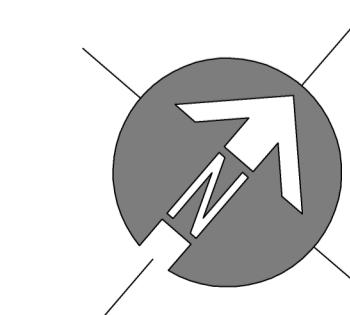
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ALL MATERIALS TO MATCH EXISTING
ROOFLIGHTS NOT TO PROTRUDE MORE
THAN 150MM FROM ROOF SLOPE