



GROUND FLOOR

TOTAL AREA : 55.87 sqm.

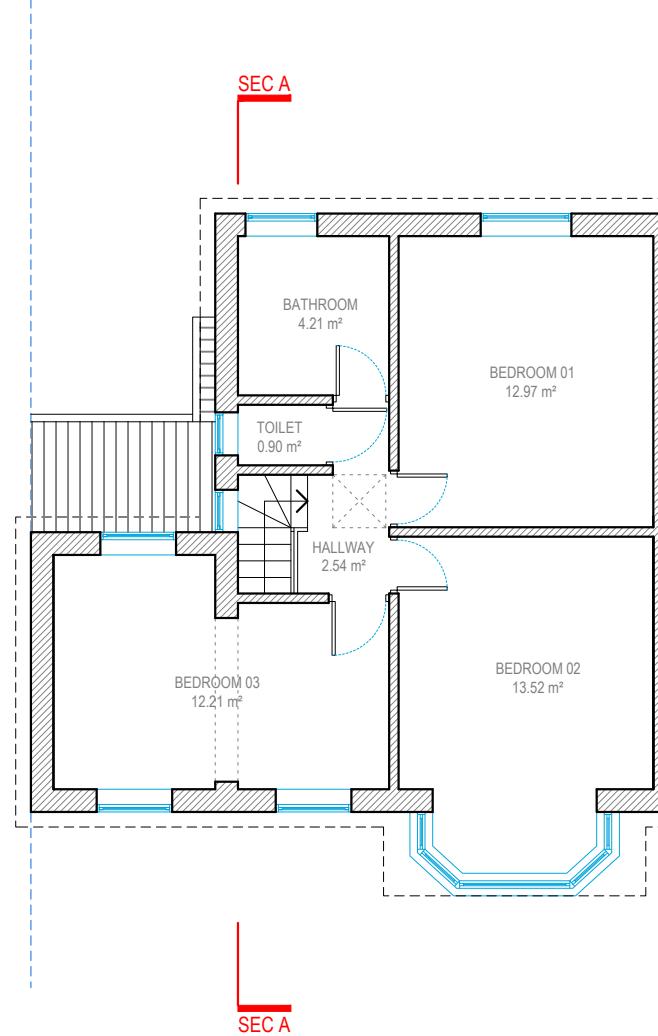


FIRST FLOOR

TOTAL AREA : 50.02 sqm.

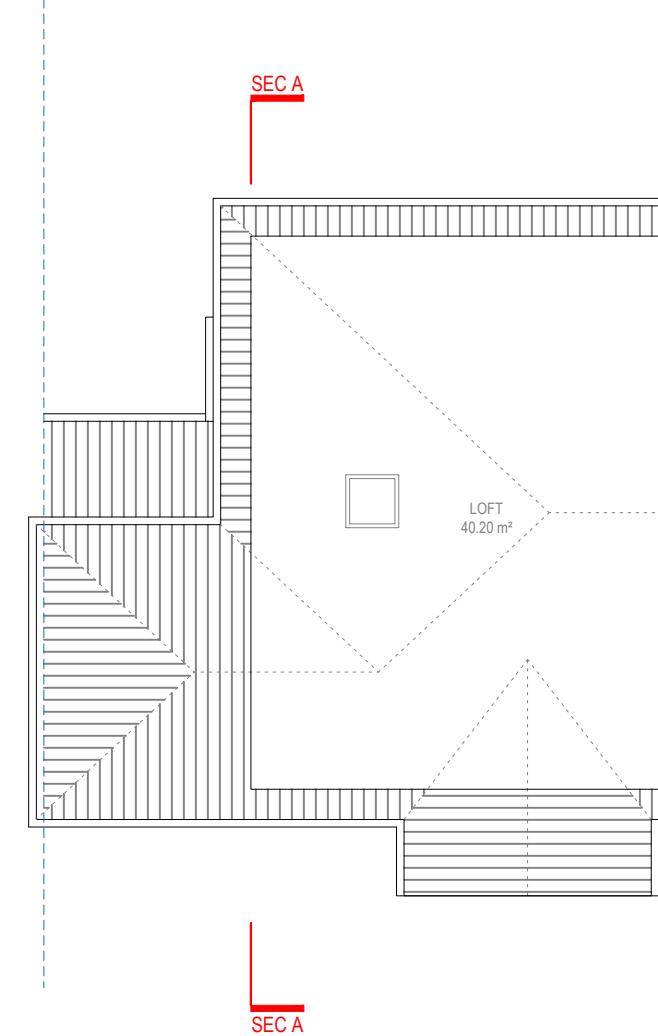

LOFT FLOOR

TOTAL AREA : 40.20 sqm.

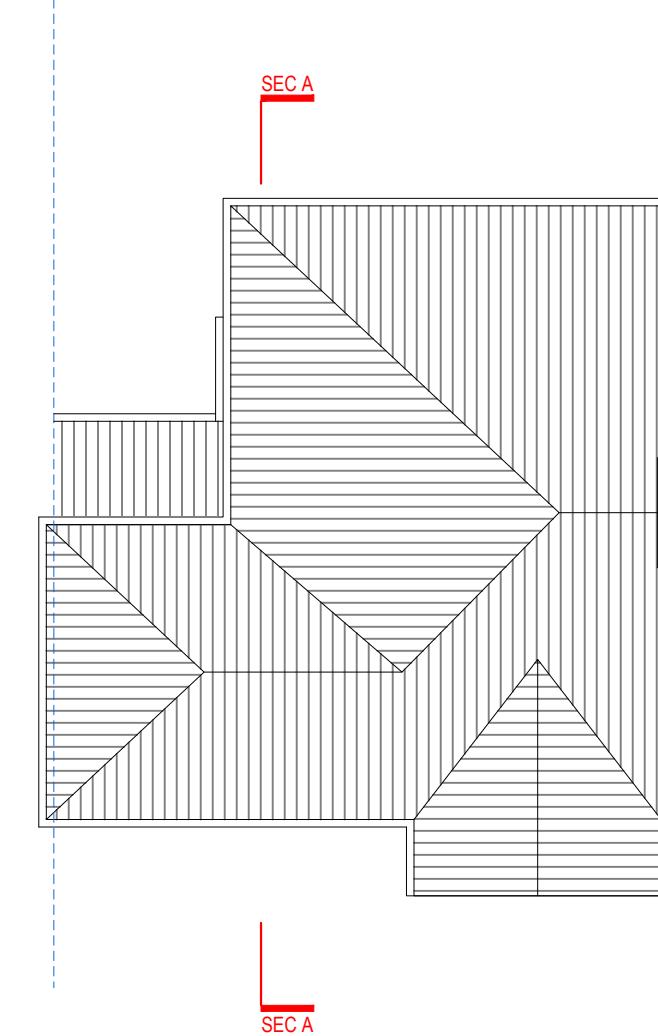

ROOF PLAN

REFERENCE: 12 CHURCH ROAD, NORTHWOOD HA6 1AS, UK

TITLE: EXISTING DRAWINGS
FLOOR PLANS

PROJECT No 2238 DATE: 17-04-2024

SHEET No E 01



0 1 2 5m scale 1:100 @A3

NOTES:

DRAWN BY JM

EDITED BY JJKC




FRONT ELEVATION




LEFT SIDE ELEVATION



REAR ELEVATION

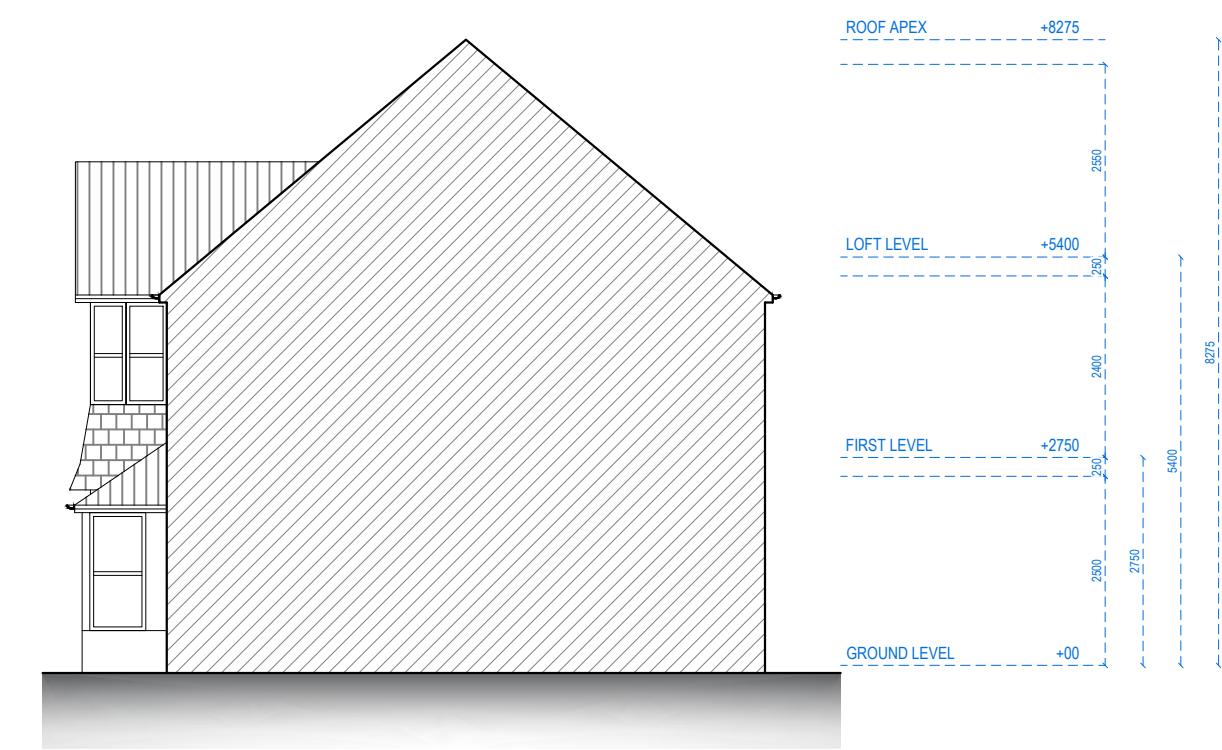


RIGHT SIDE ELEVATION

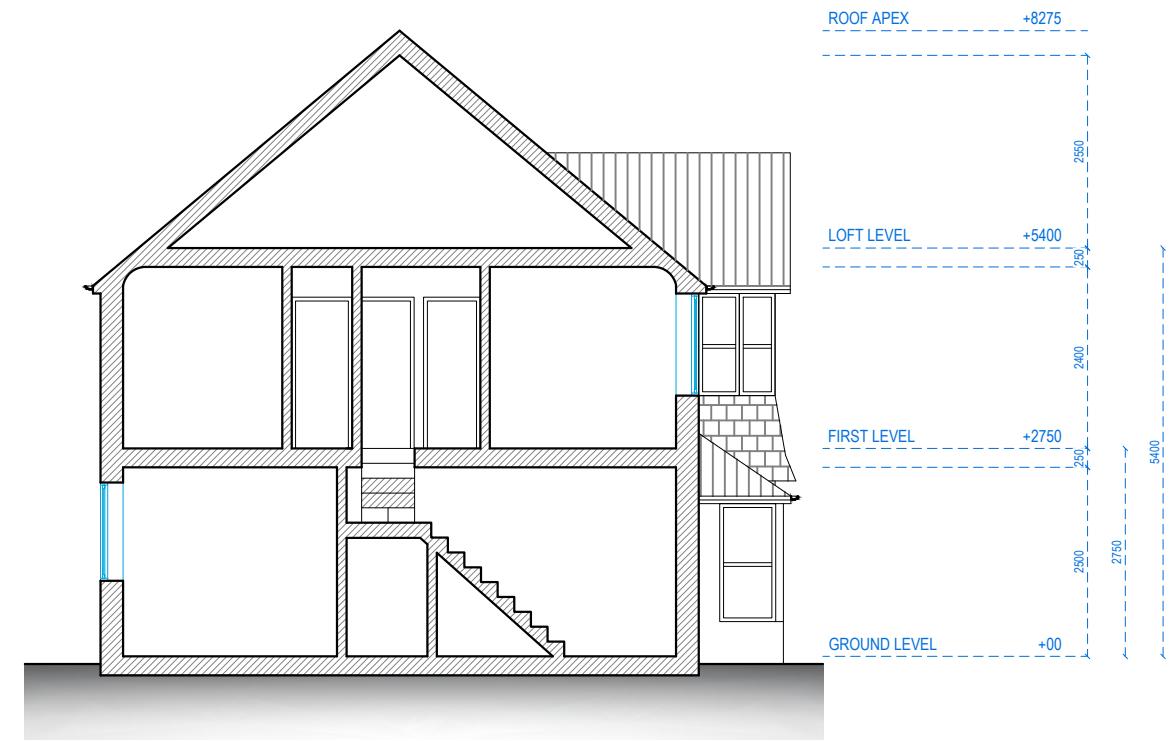


SECTION AA


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TITLE:	EXISTING DRAWINGS SECTION	
PROJECT No	2238	DATE: 17-04-2024
SHEET No	E 04	

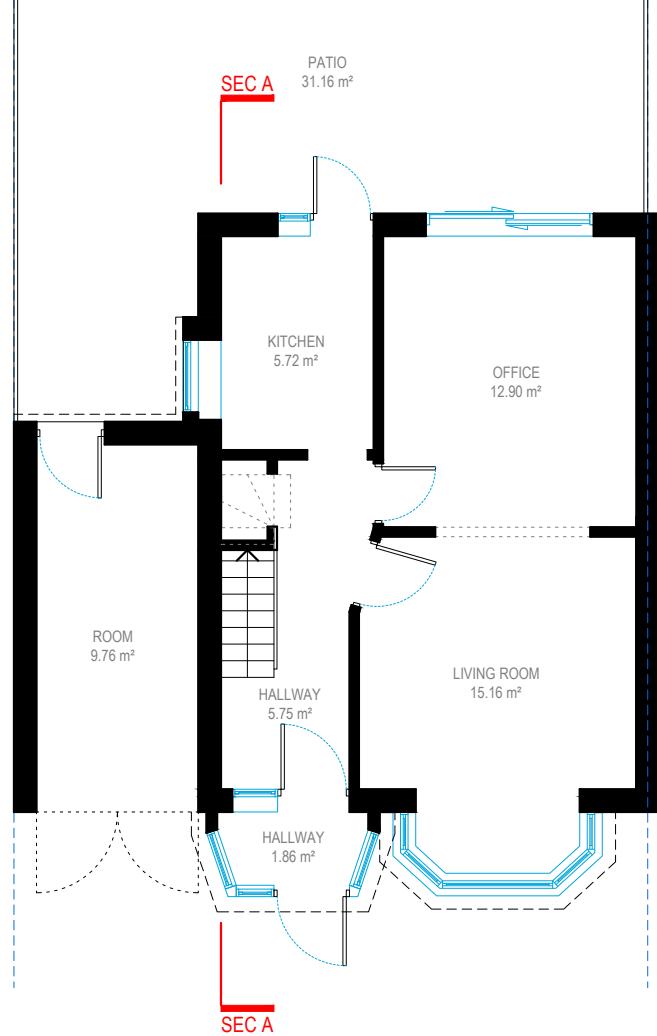


GROUND FLOOR

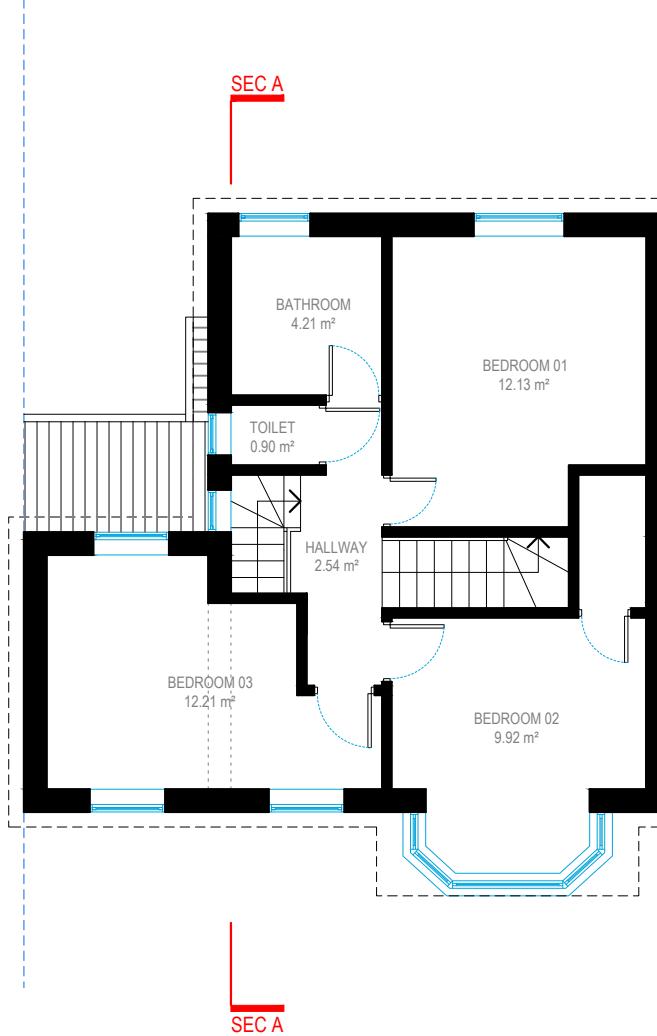

FIRST FLOOR

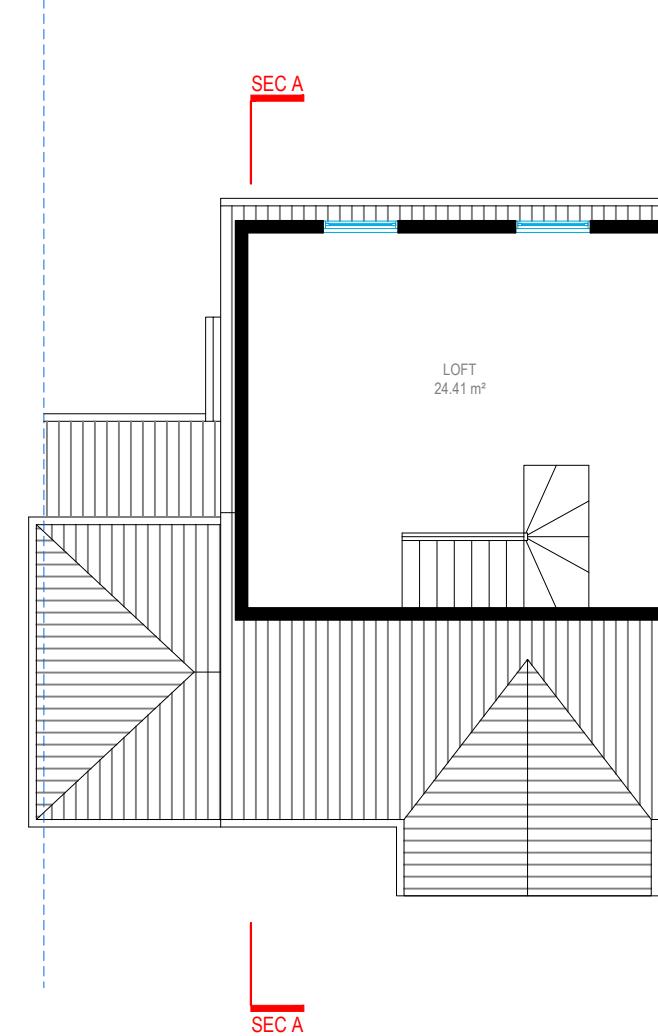

LOFT FLOOR

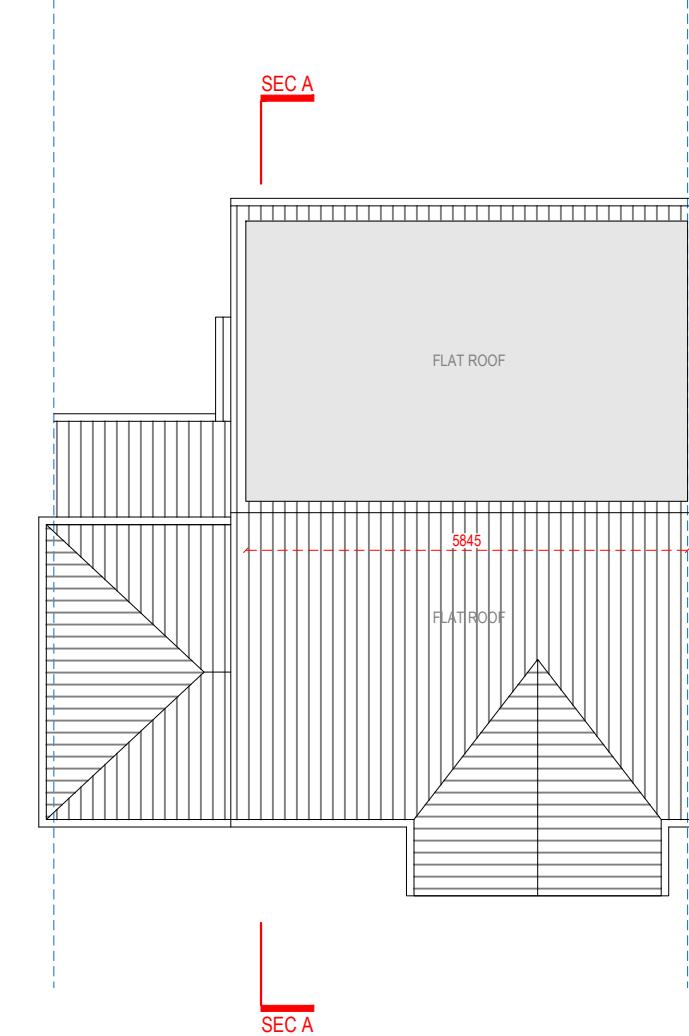


ROOF PLAN







FRONT ELEVATION

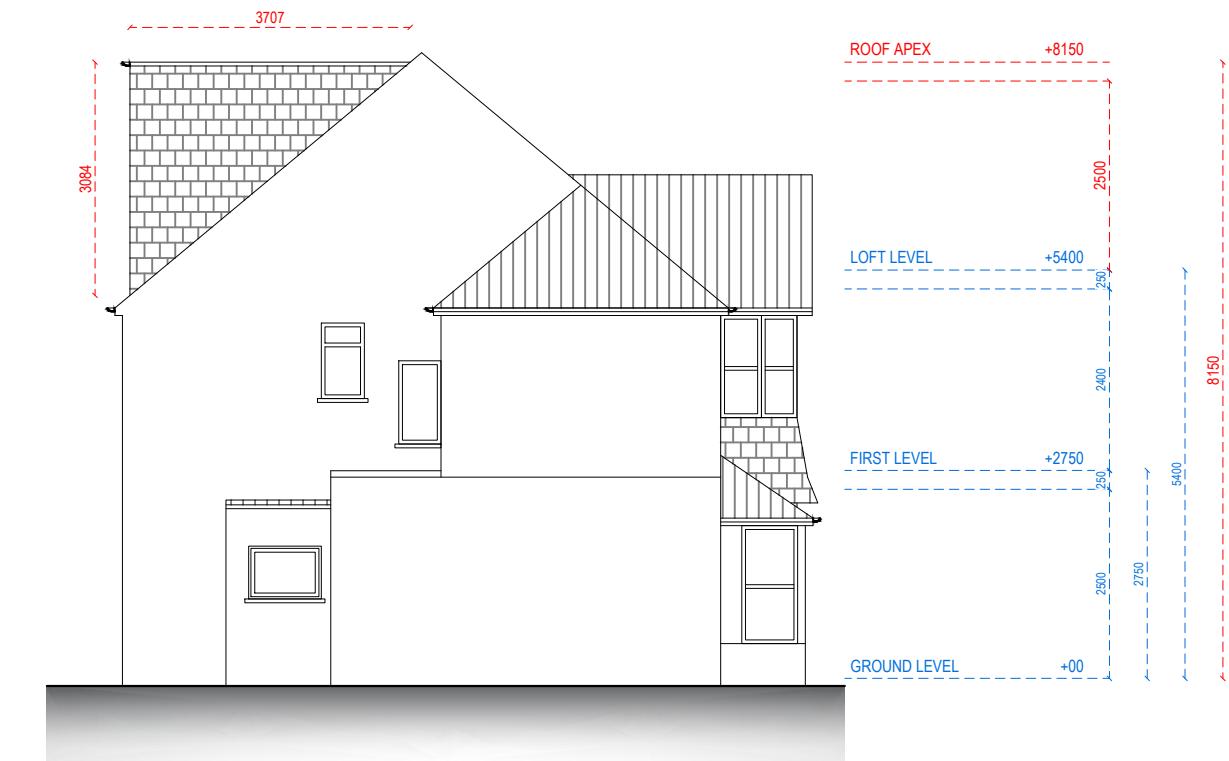


LEFT SIDE ELEVATION

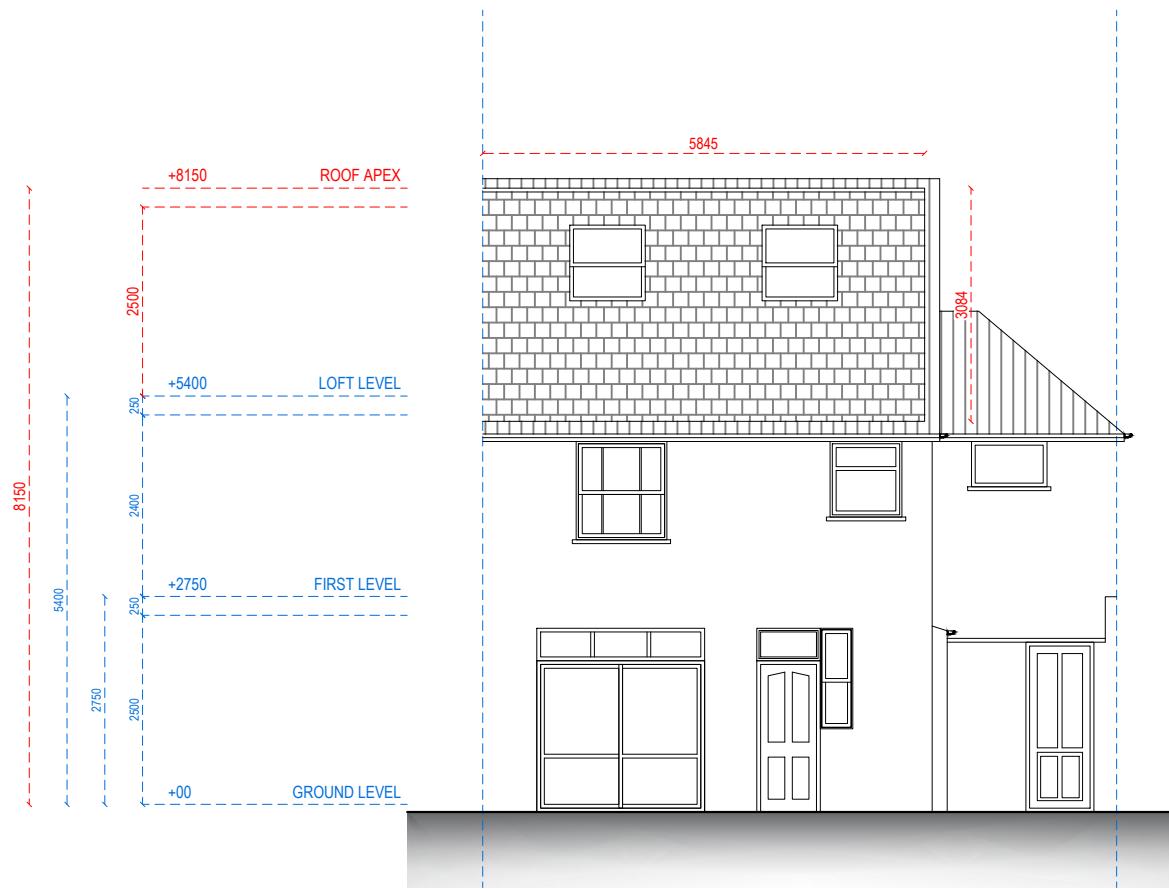


REAR ELEVATION

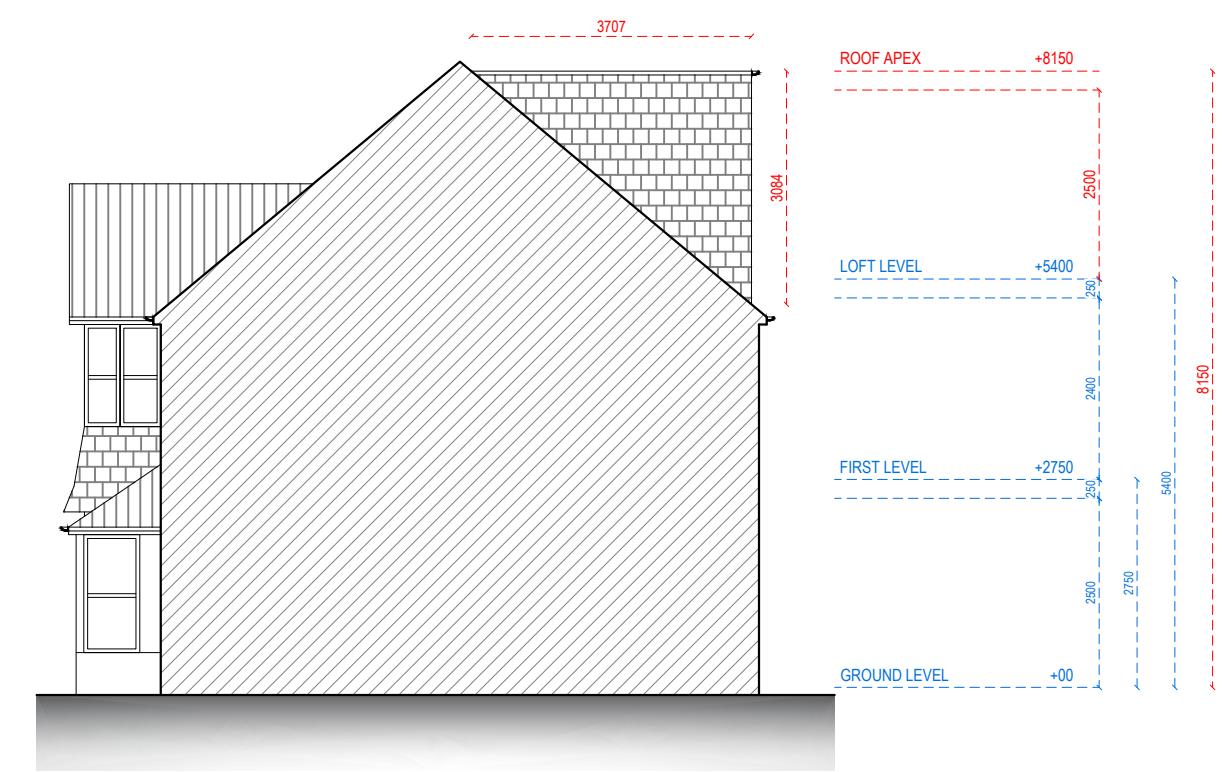

RIGHT SIDE ELEVATION

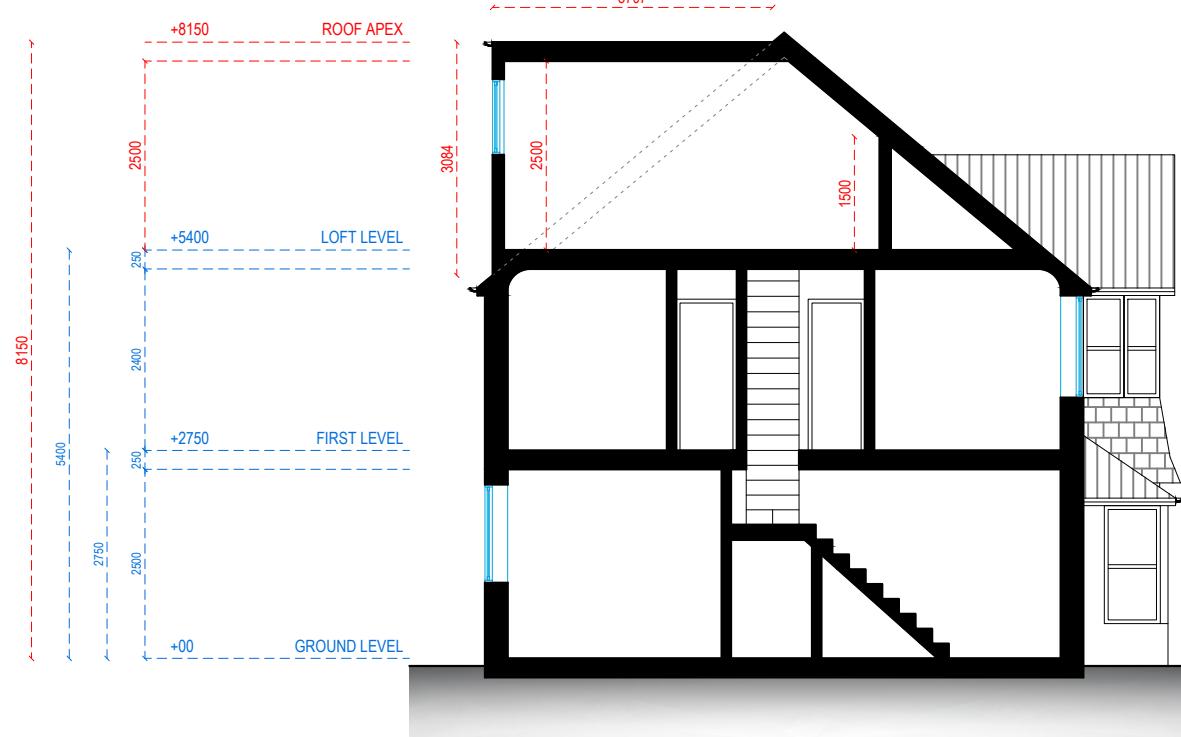

SECTION AA

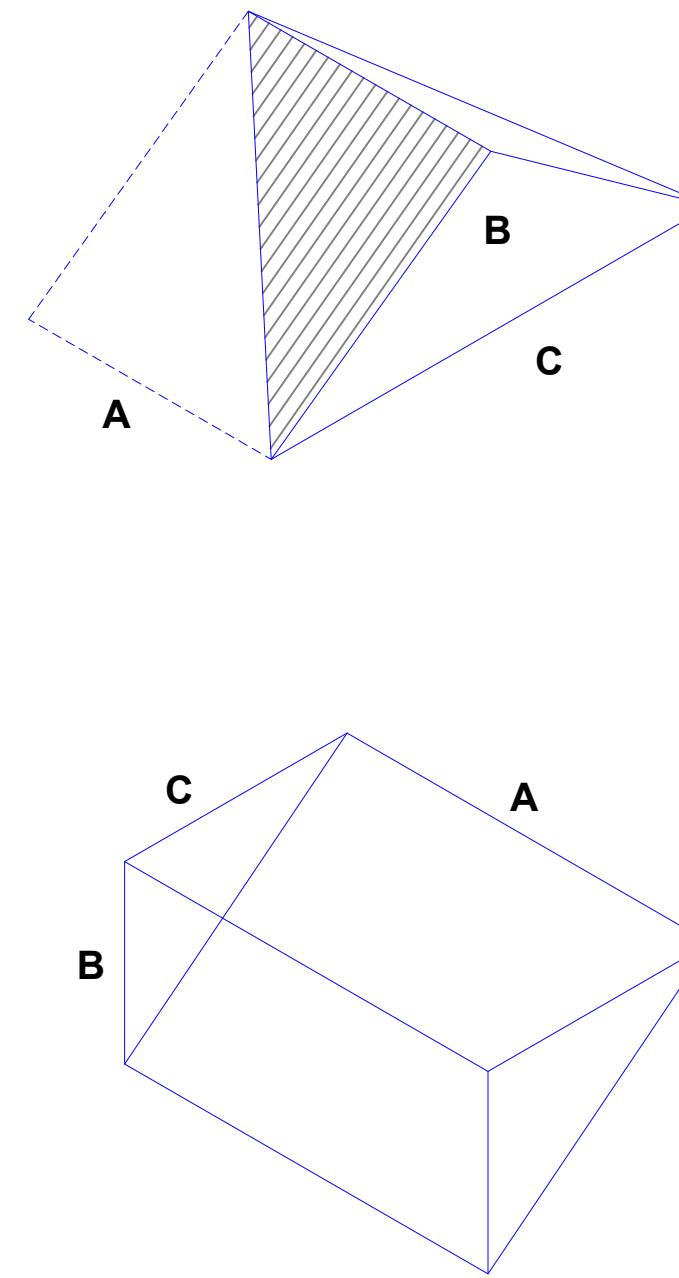

HIP TO GABLE ROOF CONVERSION

$$V = \frac{1}{3} (C \times B / 2) \times A$$

$$V = \frac{1}{3} (8.115m \times 4.345m / 2) \times 3.375m$$

$$V = 19.83m^3$$

DORMER 1

$$V = \frac{1}{2} \times A \times B \times C$$

$$V = \frac{1}{2} \times 5.845m \times 3.084m \times 3.707m$$

$$V = 33.41m^3$$