
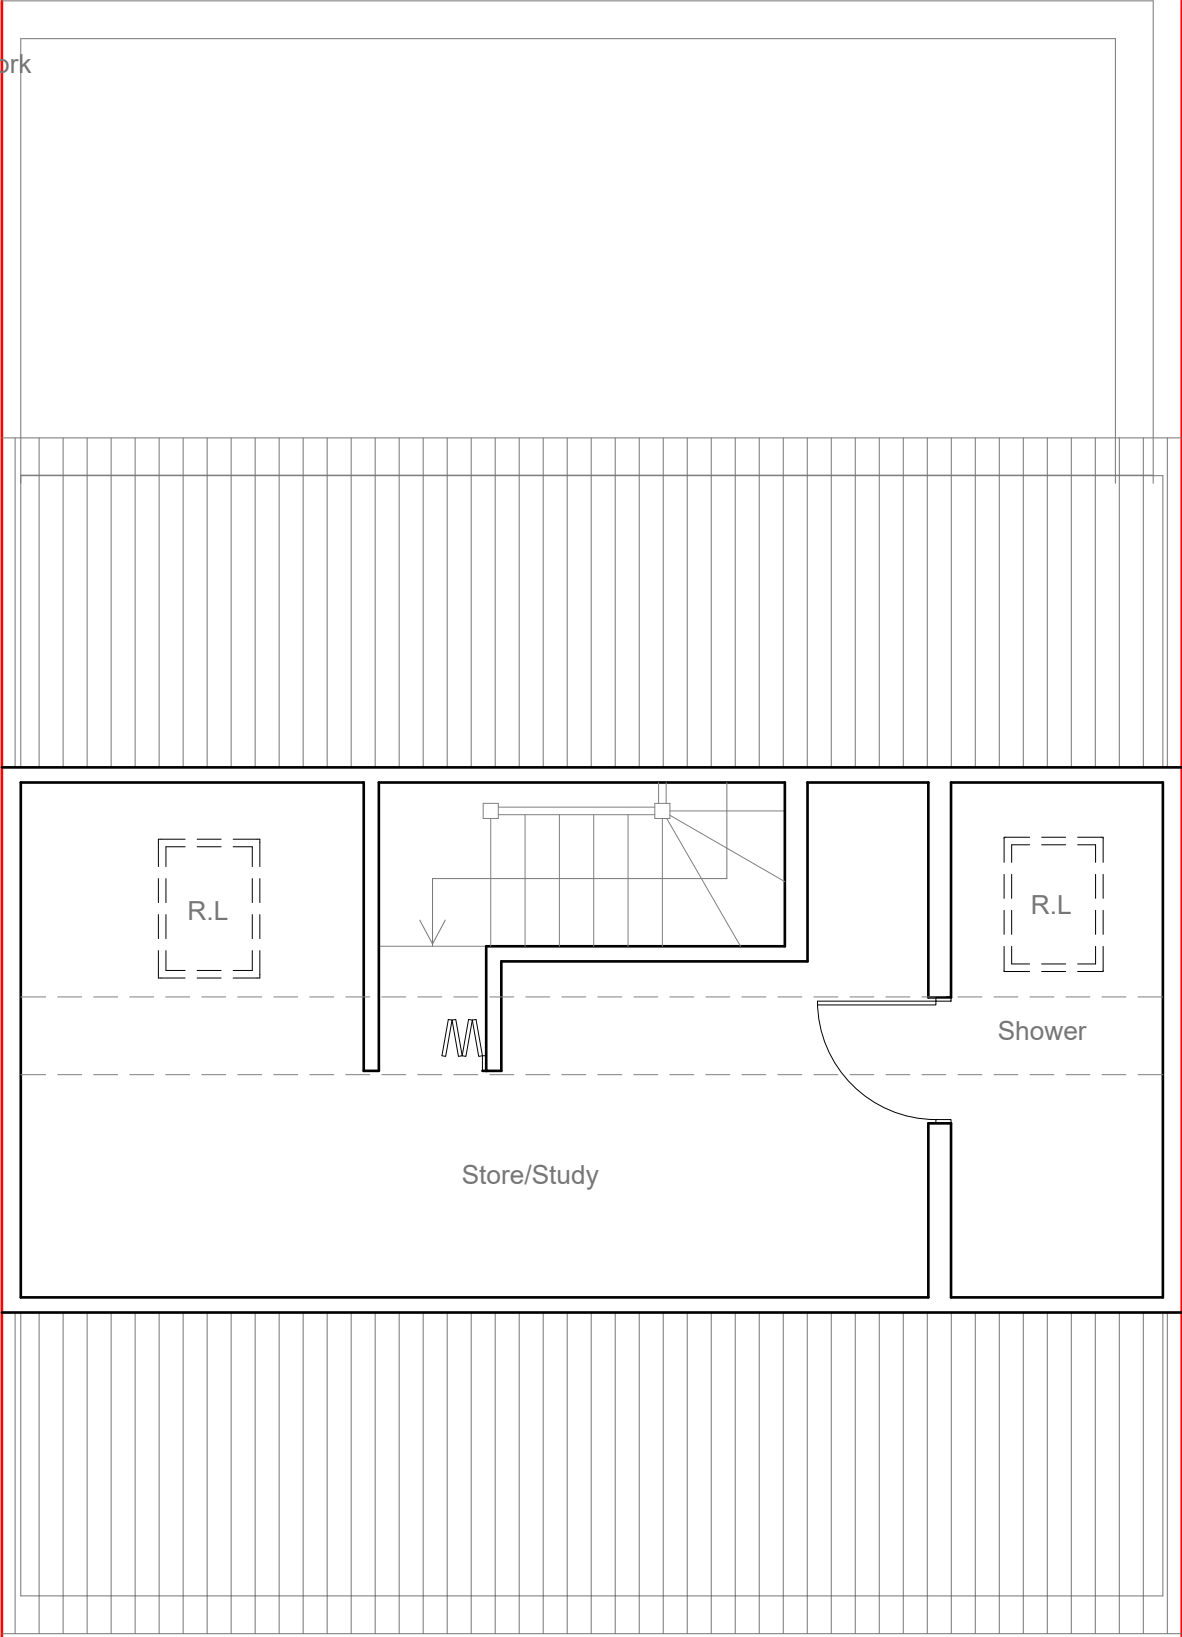


All work to comply with current building regulations and codes of practice

All dimensions to be checked on site before the start of any work

Proposed External Finish Materials to Match Existing External Finish Materials

Existing Ground Floor Plan  
Scale: 1:50

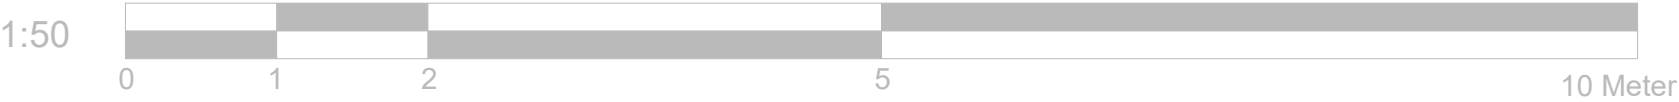

Existing First Floor Plan  
Scale: 1:50

Project:	Title:	Scale: 1:50 @ A3
62 Masfield Ln Hayes UB4 9AN	Existing Floor Plans	Date: 04 . 2024
		Drawing No.: 177 - 01/MT
		Revision


All work to comply with current building regulations and codes of practice

All dimensions to be checked on site before the start of any work


Proposed External Finish Materials to Match Existing External Finish Materials




Existing Front Elevation  
Scale:1:100

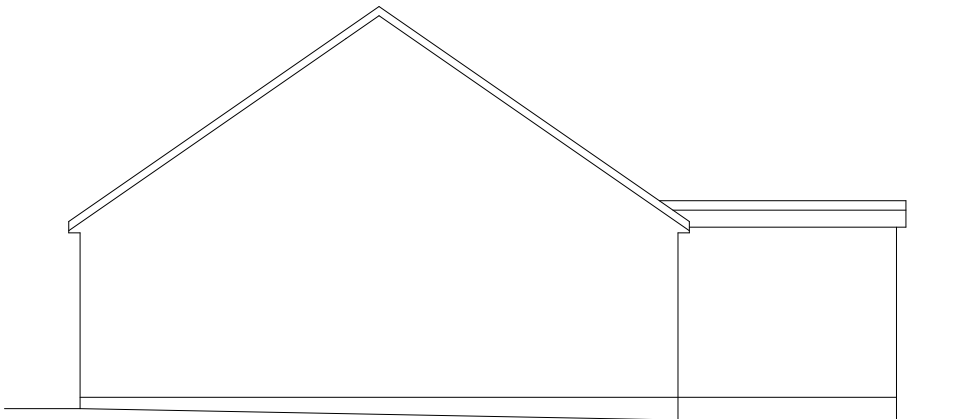

Existing Side Elevation  
Scale:1:100

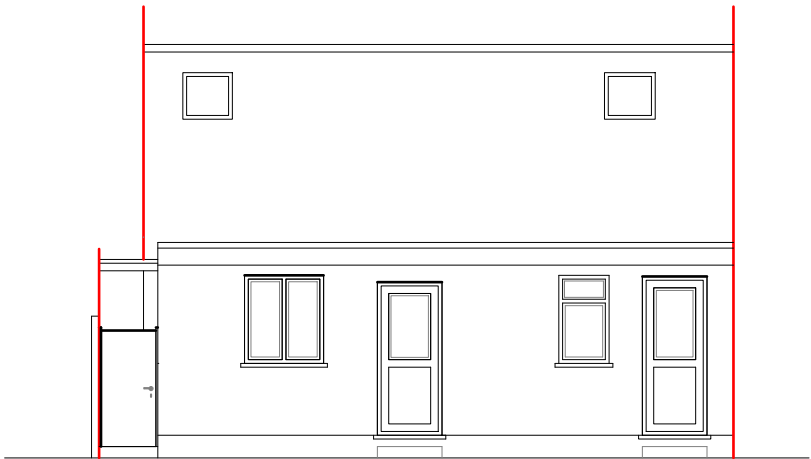

Existing Rear Elevation  
Scale:1:100

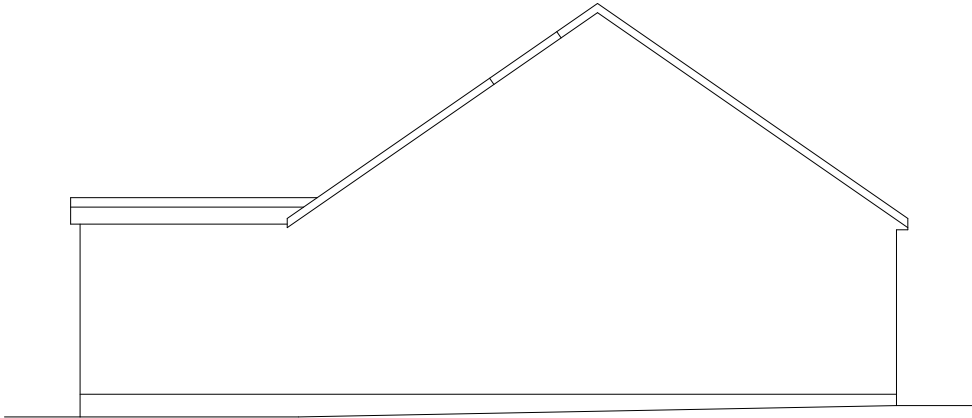


Existing Side Elevation  
Scale:1:100

1:100



10 Meter

Project:	Title:	Scale: 1:100 @ A3
62 Masfield Ln	Existing Elevations	Date: 04 . 2024
Hayes		Drawing No.: 177 - 02/MT
UB4 9AN		Revision

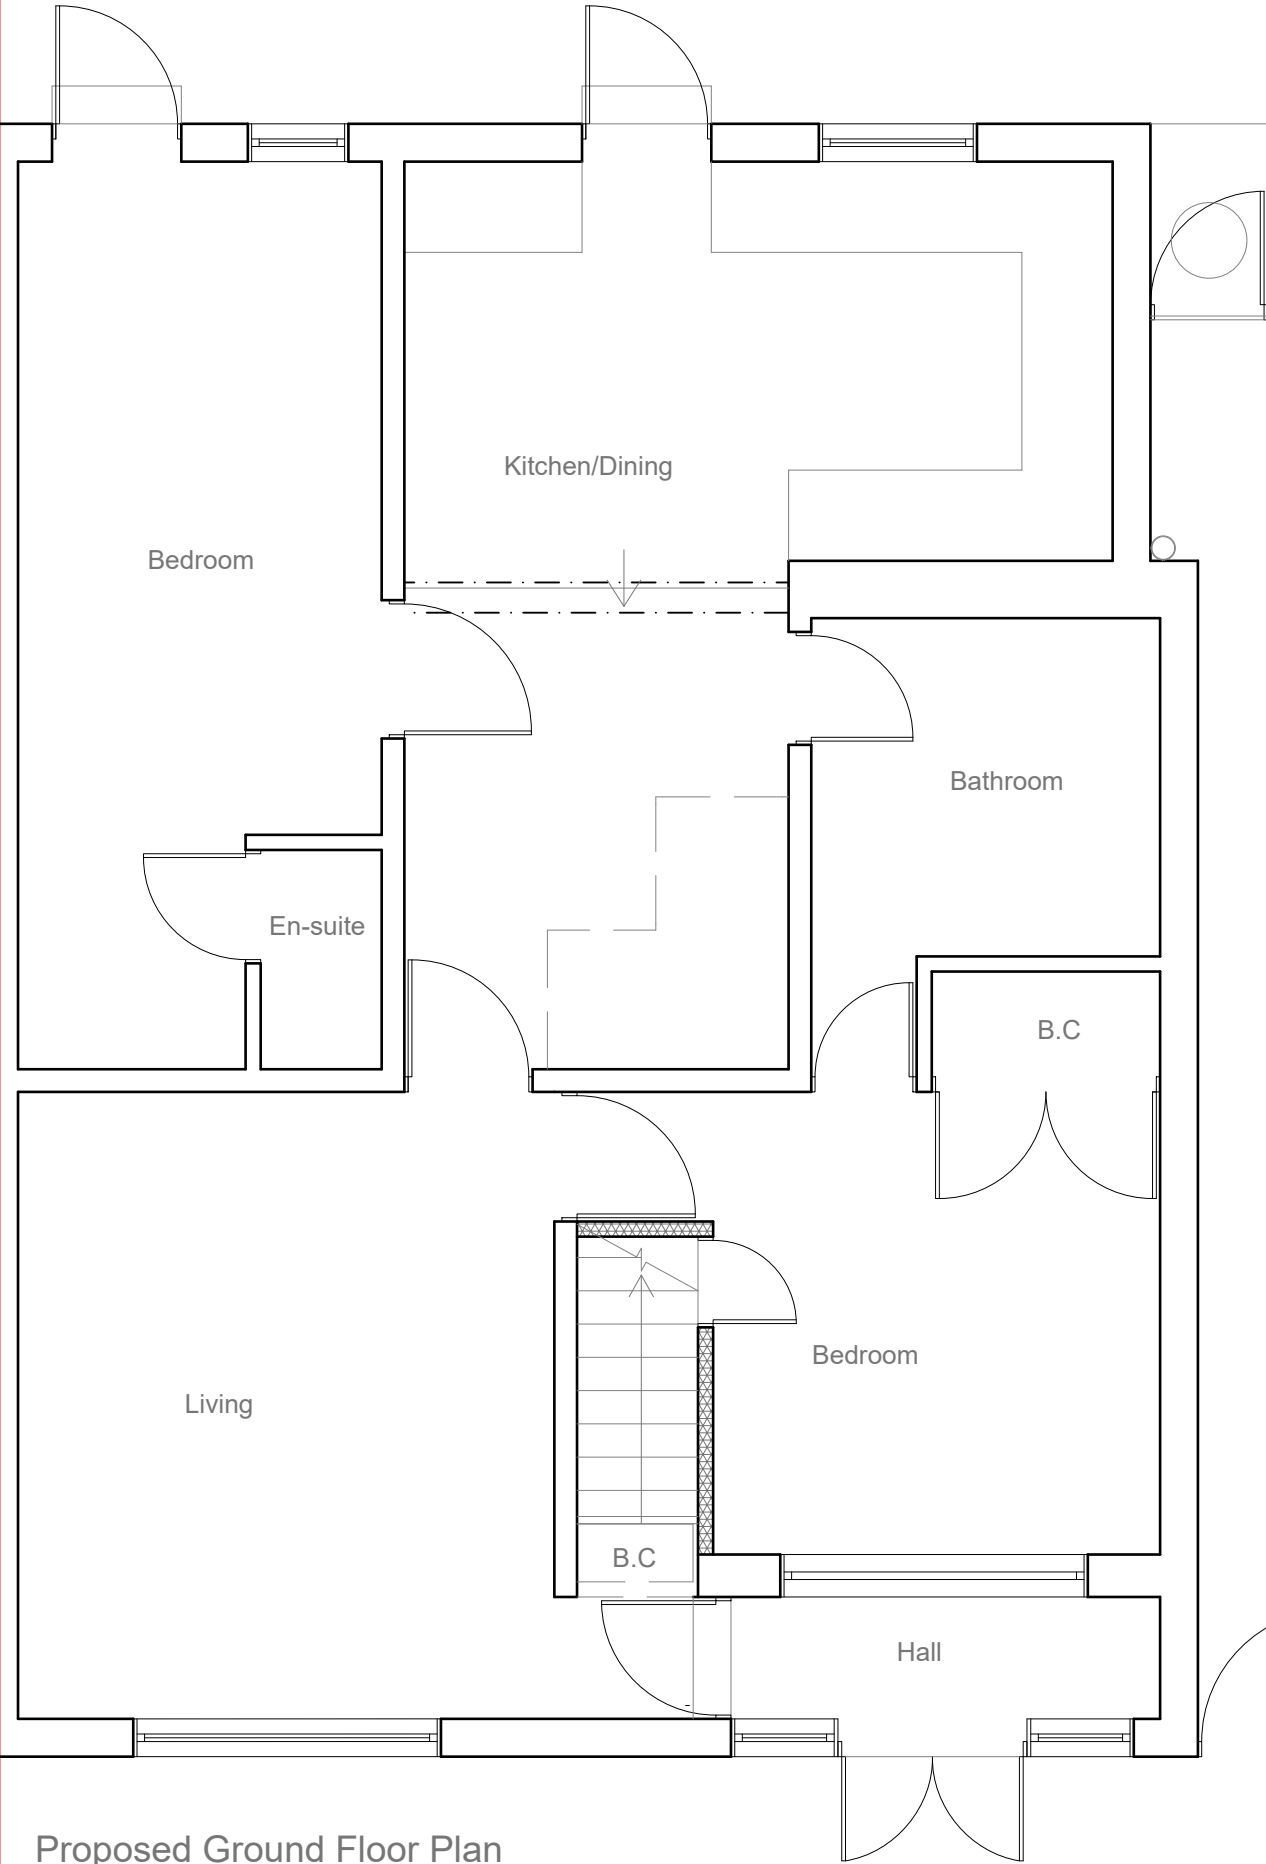


All work to comply with current building regulations and codes of practice

All dimensions to be checked on site before the start of any work


Proposed External Finish Materials to Match Existing External Finish Materials

Roof Lights to be installed as per manufacturer specification, not projected more than 150mm from the plane of roof slop

Proposed Ground Floor Plan  
Scale: 1:50

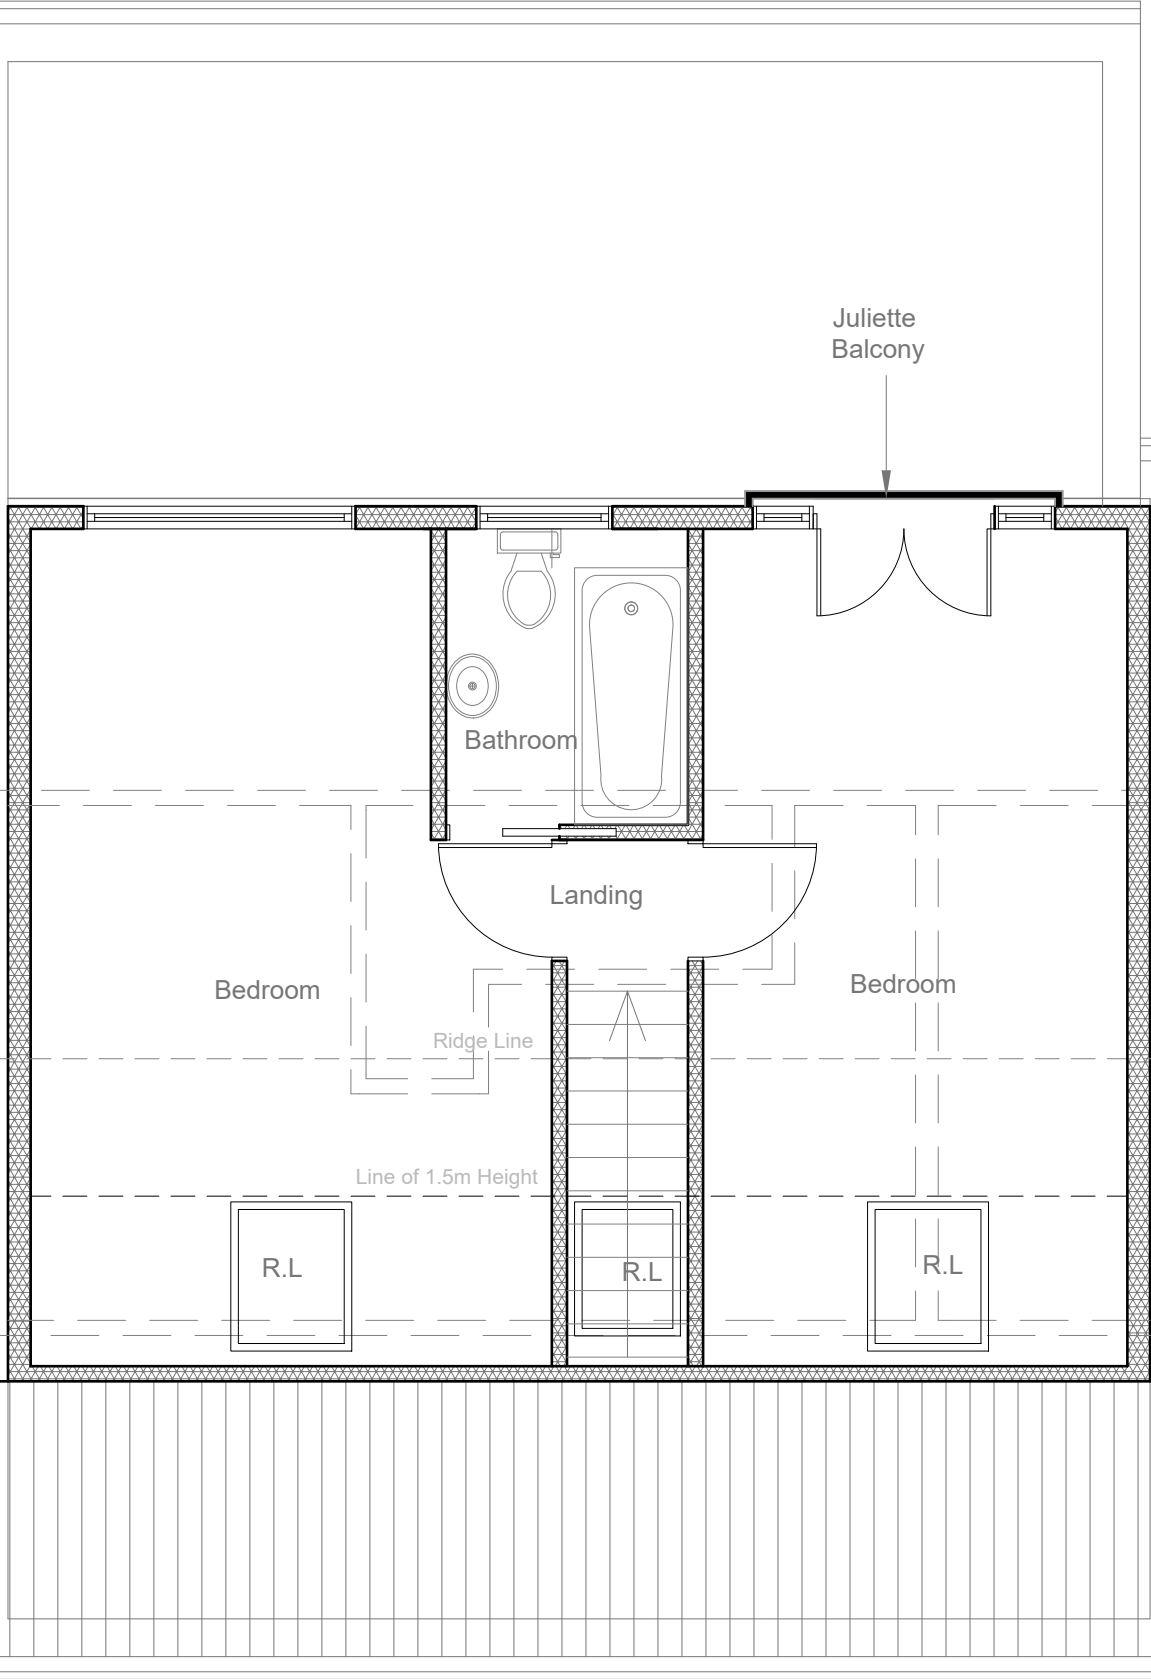

Proposed Loft Plan  
Scale: 1:50

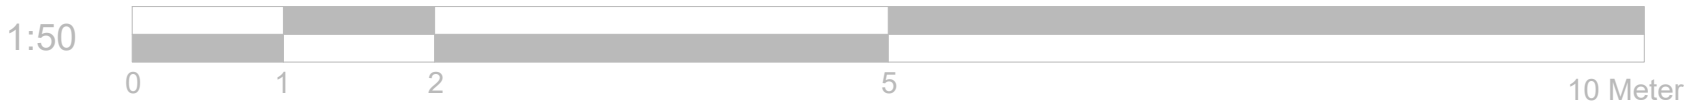


Project:	Title:	Scale: 1:50 @ A3
62 Masfield Ln	Proposed Floor Plans	Date: 04 . 2024
Hayes		Drawing No.: 177 - 02/MT
UB4 9AN		Revision

All work to comply with current building regulations and codes of practice


All dimensions to be checked on site before the start of any work

Proposed External Finish Materials to Match Existing External Finish Materials

Roof Lights to be installed as per manufacturer specification, not projected more than 150mm from the plane of roof slop

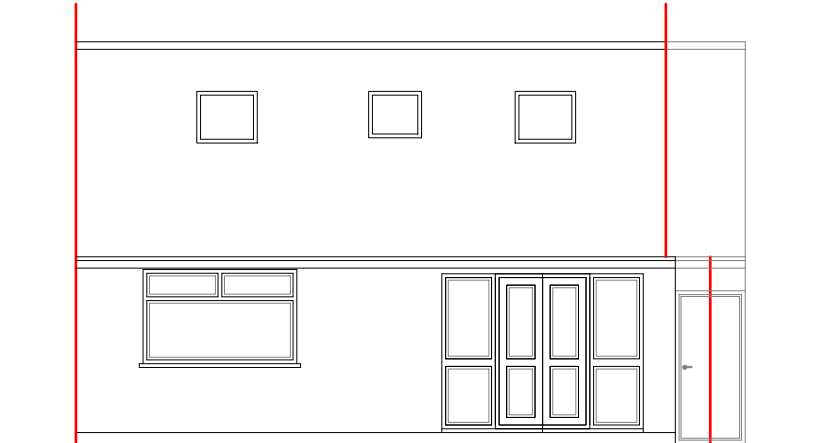


Propose Front Elevation  
Scale:1:100

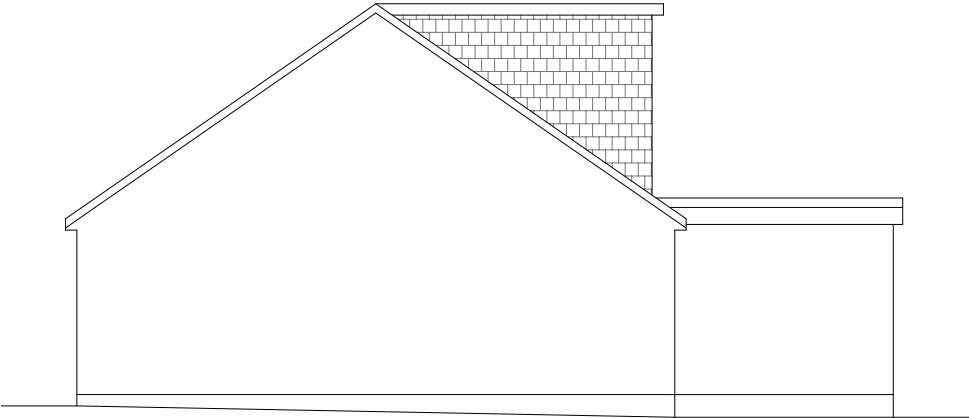


Propose Side Elevation  
Scale:1:100



Propose Rear Elevation  
Scale:1:100

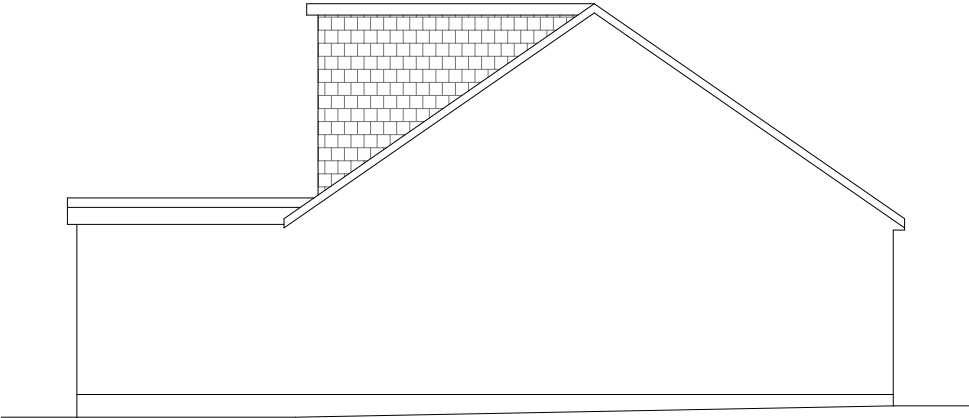

Propose Side Elevation  
Scale:1:100

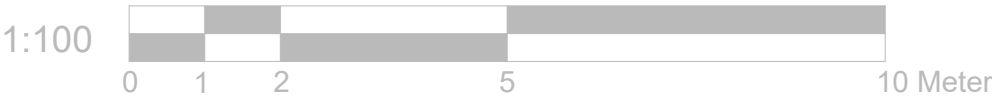


Project:	Title:	Scale: 1:100 @ A3
62 Masfield Ln	Proposed Elevations	Date: 04 . 2024
Hayes		Drawing No.: 177 - 02/MT
UB4 9AN		Revision

All work to comply with  
current building regulations  
and codes of practice

All dimensions to be checked  
on site before the start of any work


Proposed External Finish  
Materials to Match Existing  
External Finish Materials

Roof Lights to be installed as  
per manufacturer specification,  
not projected more than 150mm  
from the plane of roof slop

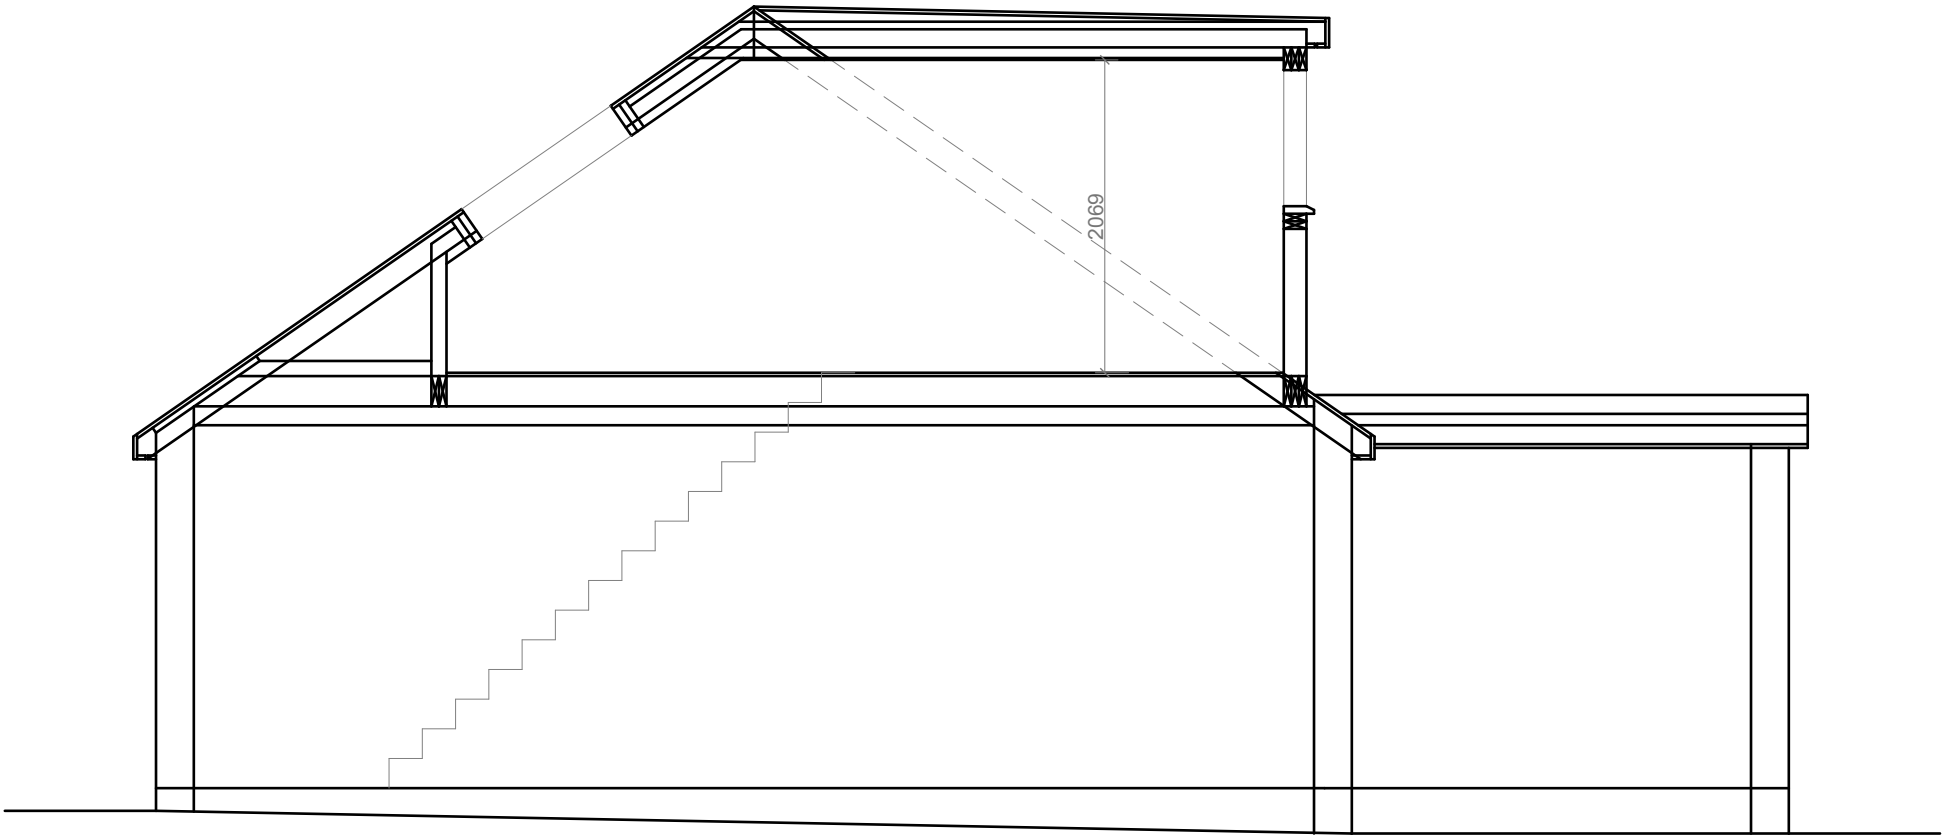

Proposed Section  
Scale:1:50

1:50

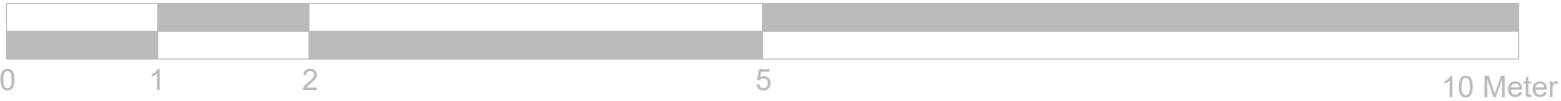

Project:	Title:	Scale: 1:50 @ A3
62 Masfield Ln	Proposed Section	Date: 04 . 2024
Hayes		Drawing No.: 177 - 05/MT
UB4 9AN		Revision