



Existing Ground Floor Plan
Scale 1:100

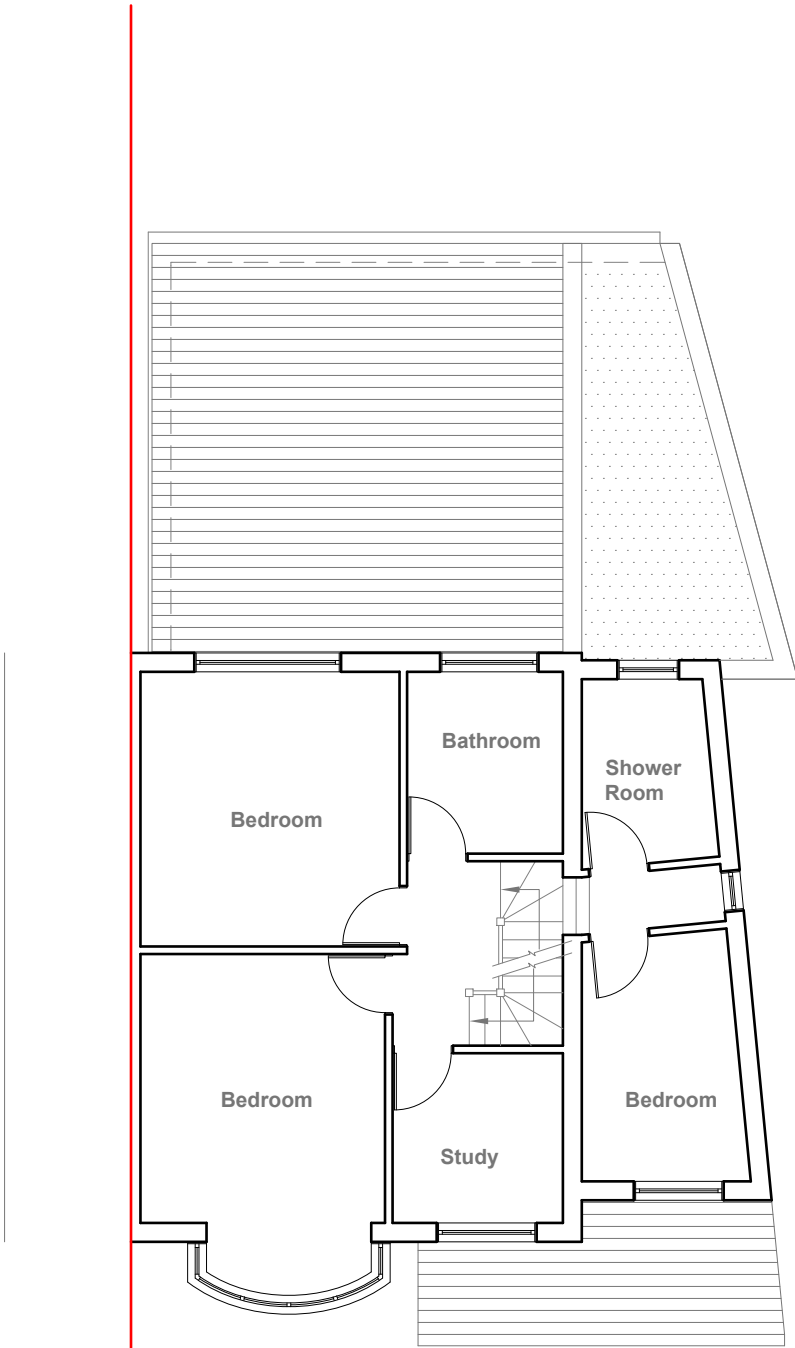

Existing First Floor Plan
Scale 1:100

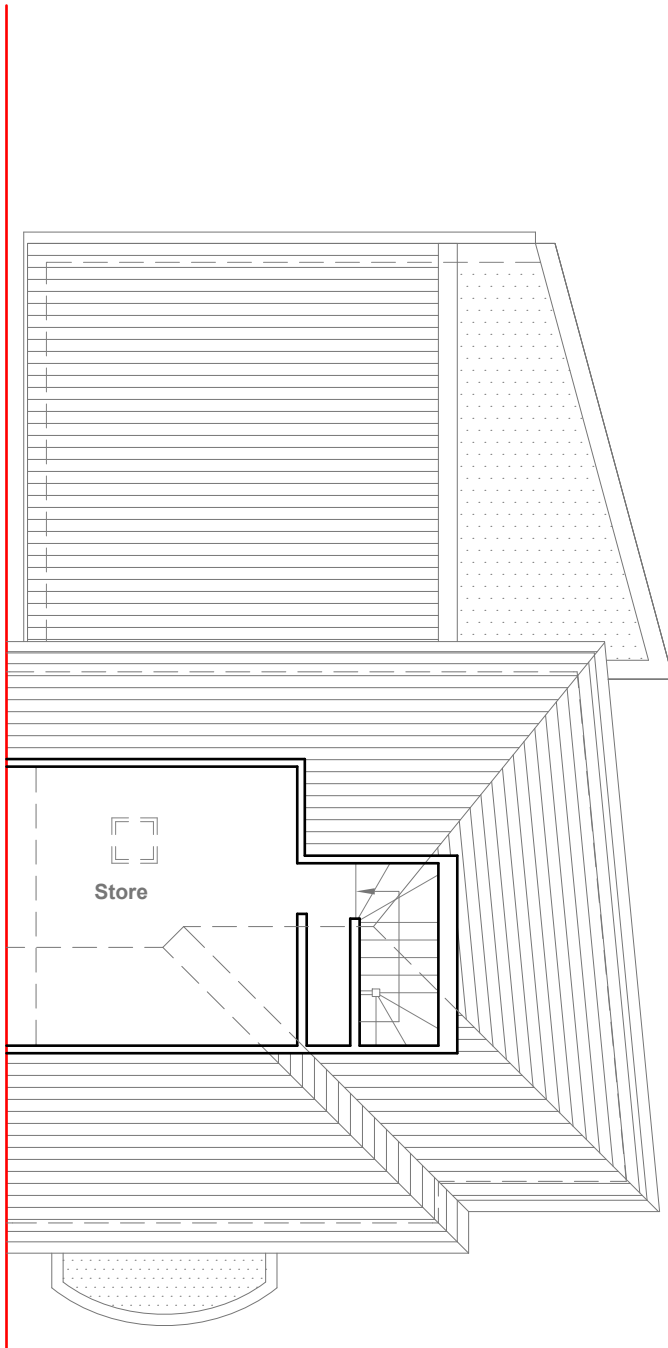

Existing First Floor Plan
Scale 1:100



GENERAL NOTES:
1. ALL DIMENSIONS ARE IN MILLIMETER.
2. VERIFY ALL DIMENSIONS AND CONDITIONS BEFORE BUILDING OR STARTING CONSTRUCTION. NOTIFY THE DESIGNER IMMEDIATELY OF ANY DISCREPANCY OR VARIATION.
3. ALL WORK TO COMPLY WITH CURRENT BUILDING REGULATIONS AND CODES OF PRACTICE


Title:

Existing Floor Plans


Site Address	Scale: 1:100 @A3	Revision Date:	Faluck Patel
7 Stirling Road, Hayes, Middx. UB3 3AQ	Date: 26/07/2022		
	Drawing No.: 2022/100 -01		
	Drawn By: RO	e:mail - faluckpatel@yahoo.com (M) +44 (0) 7871 466 254	




Existing Front Elevation
Scale 1:100

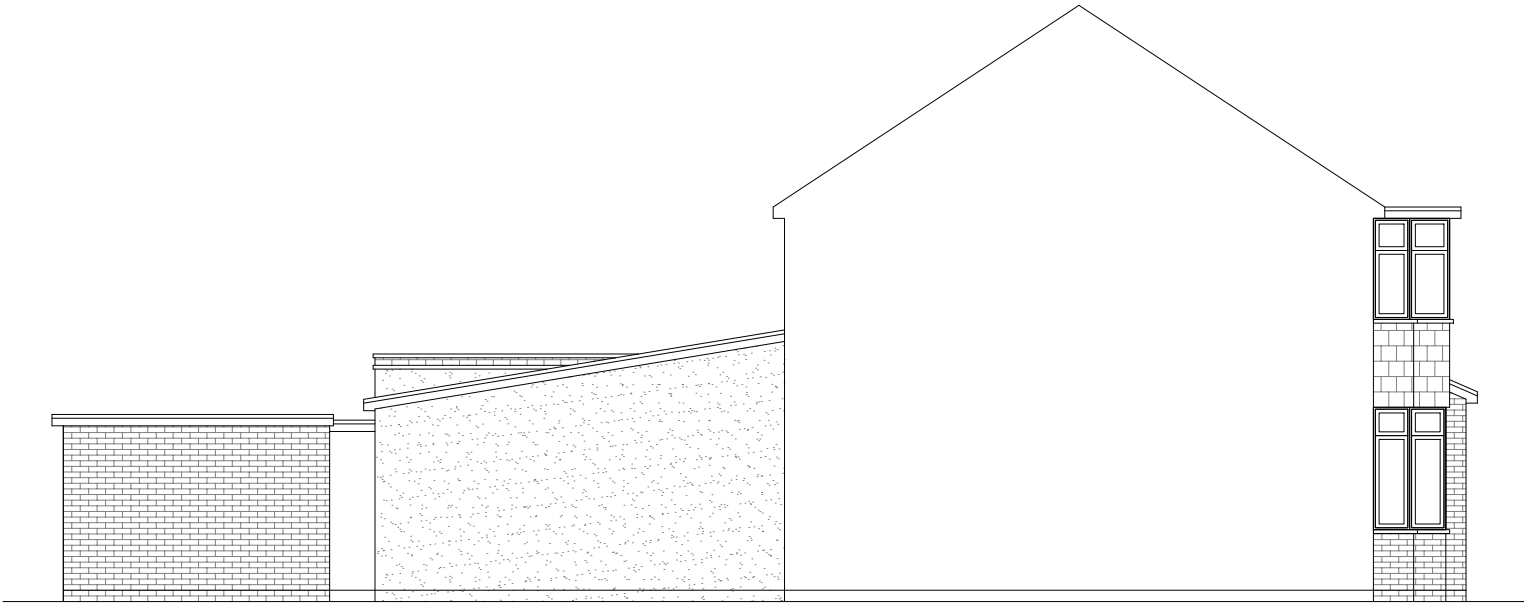

Existing Side Elevation
Scale 1:100

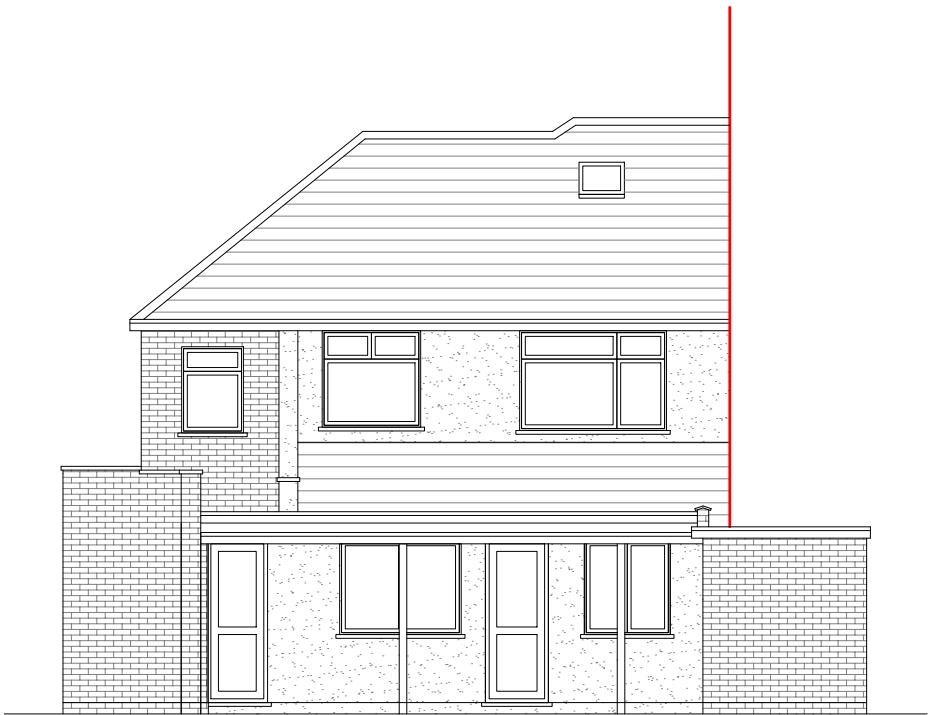

Existing Rear Elevation
Scale 1:100

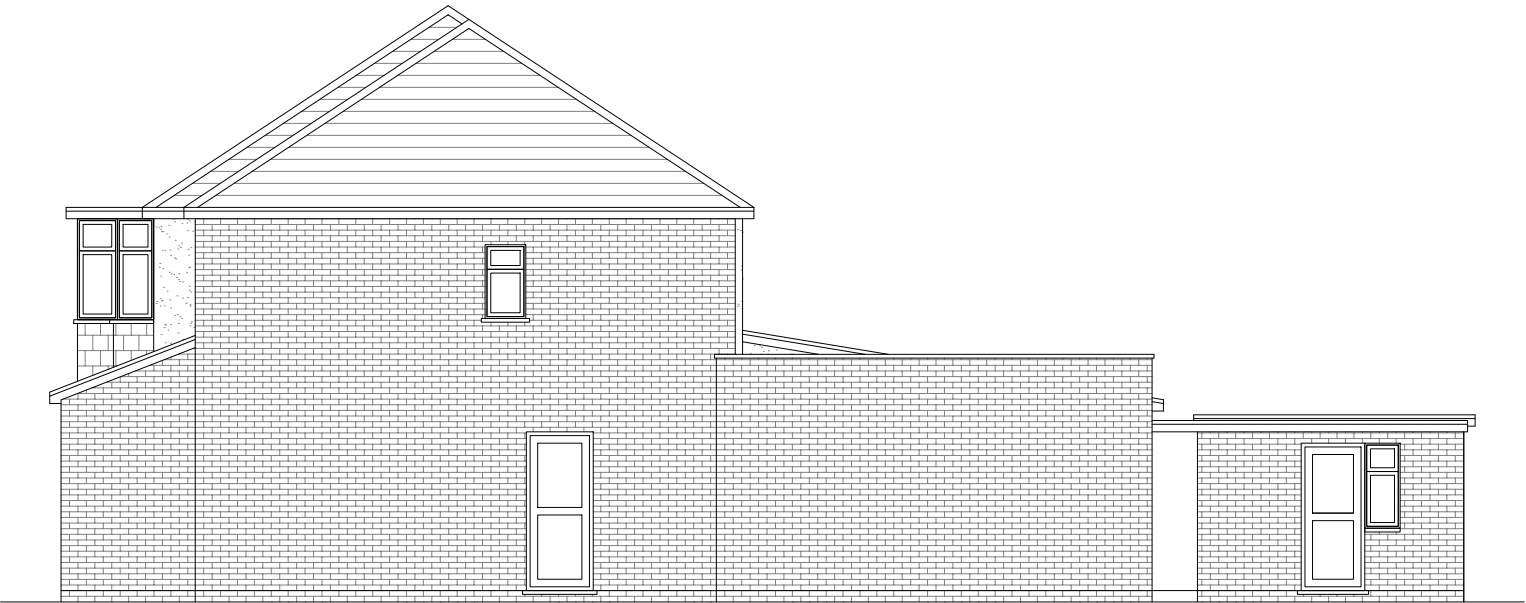

Existing Side Elevation
Scale 1:100




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Title:


Existing Elevations

Site Address	Scale: 1:100 @A3	Revision Date:
7 Stirling Road, Hayes, Middx. UB3 3AQ	Date: 26/07/2022	
	Drawing No.: 2022/100 -02	
	Drawn By: RO	e:mail - faluckpatel@yahoo.com (M) +44 (0) 7871 466 254



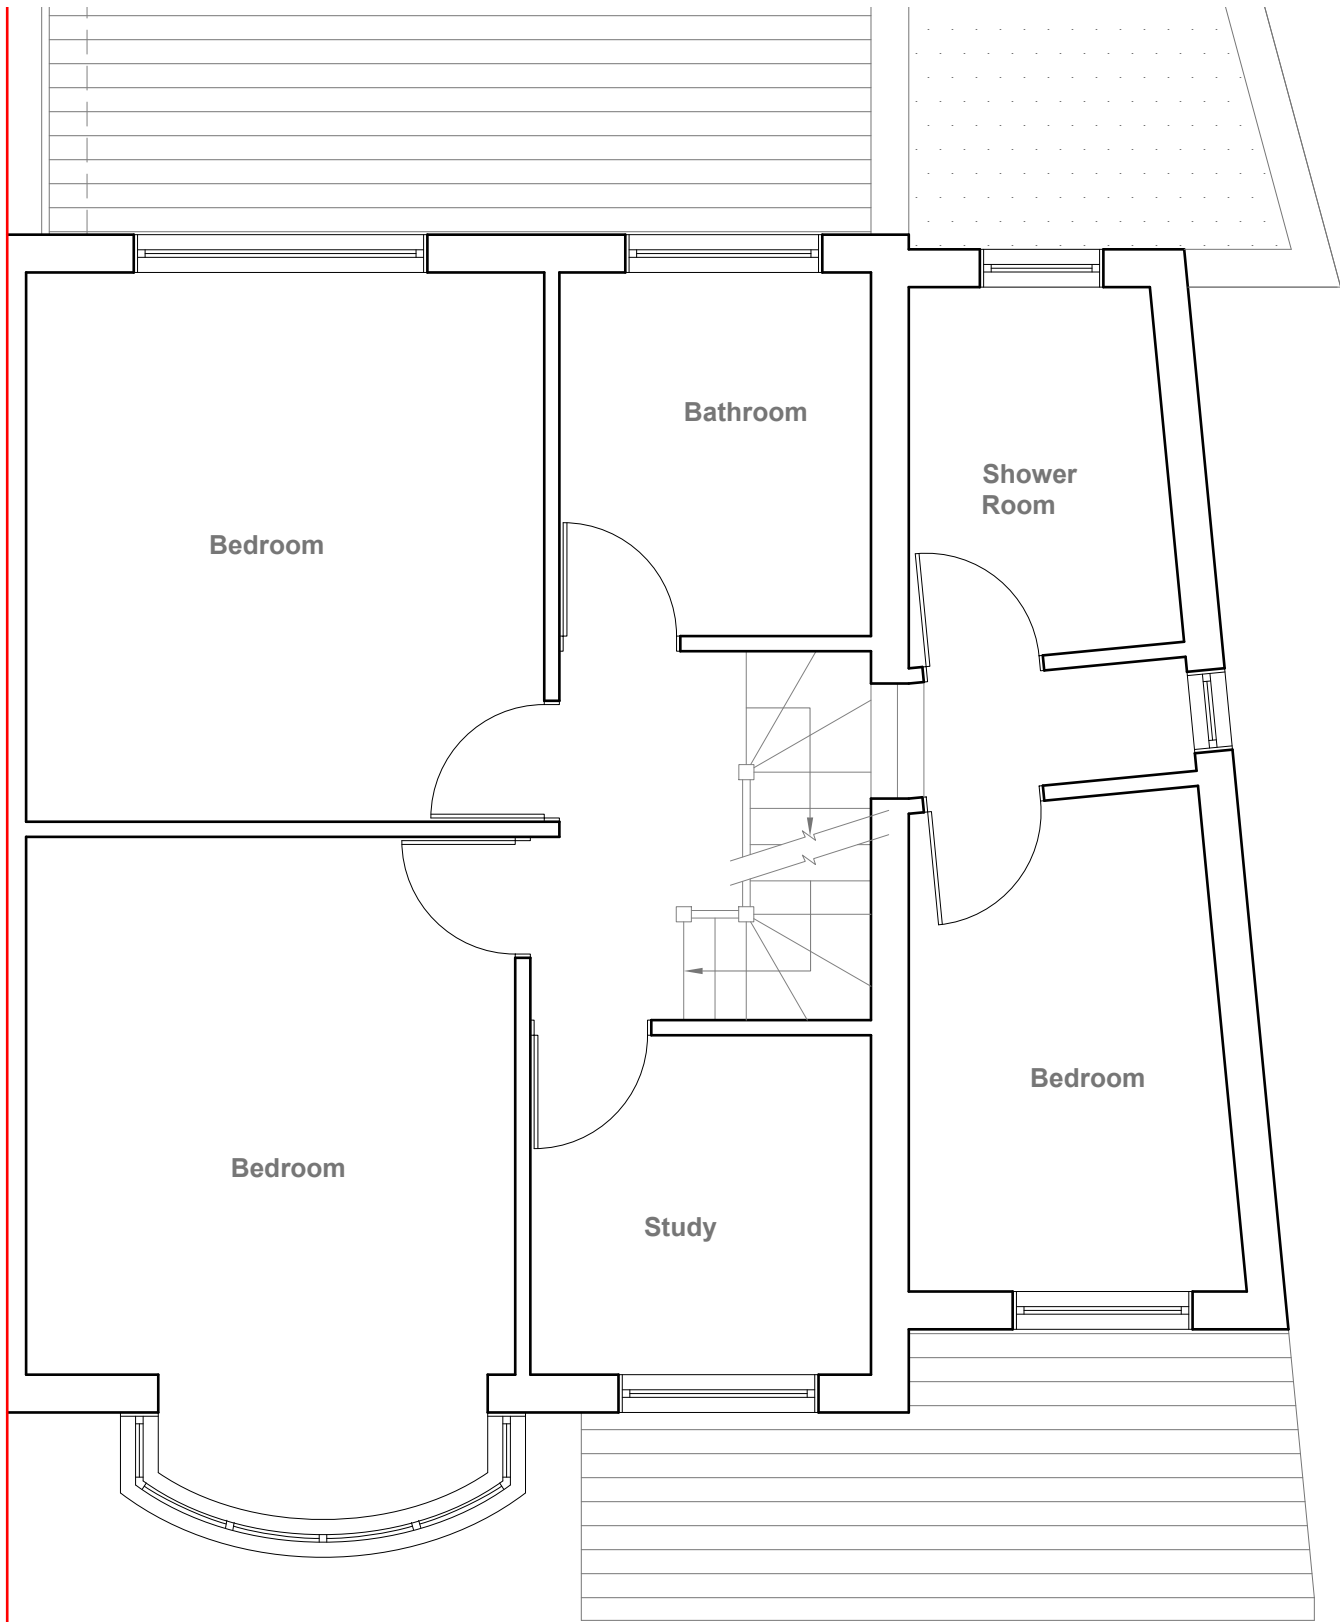

Proposed First Floor Plan
Scale 1:50

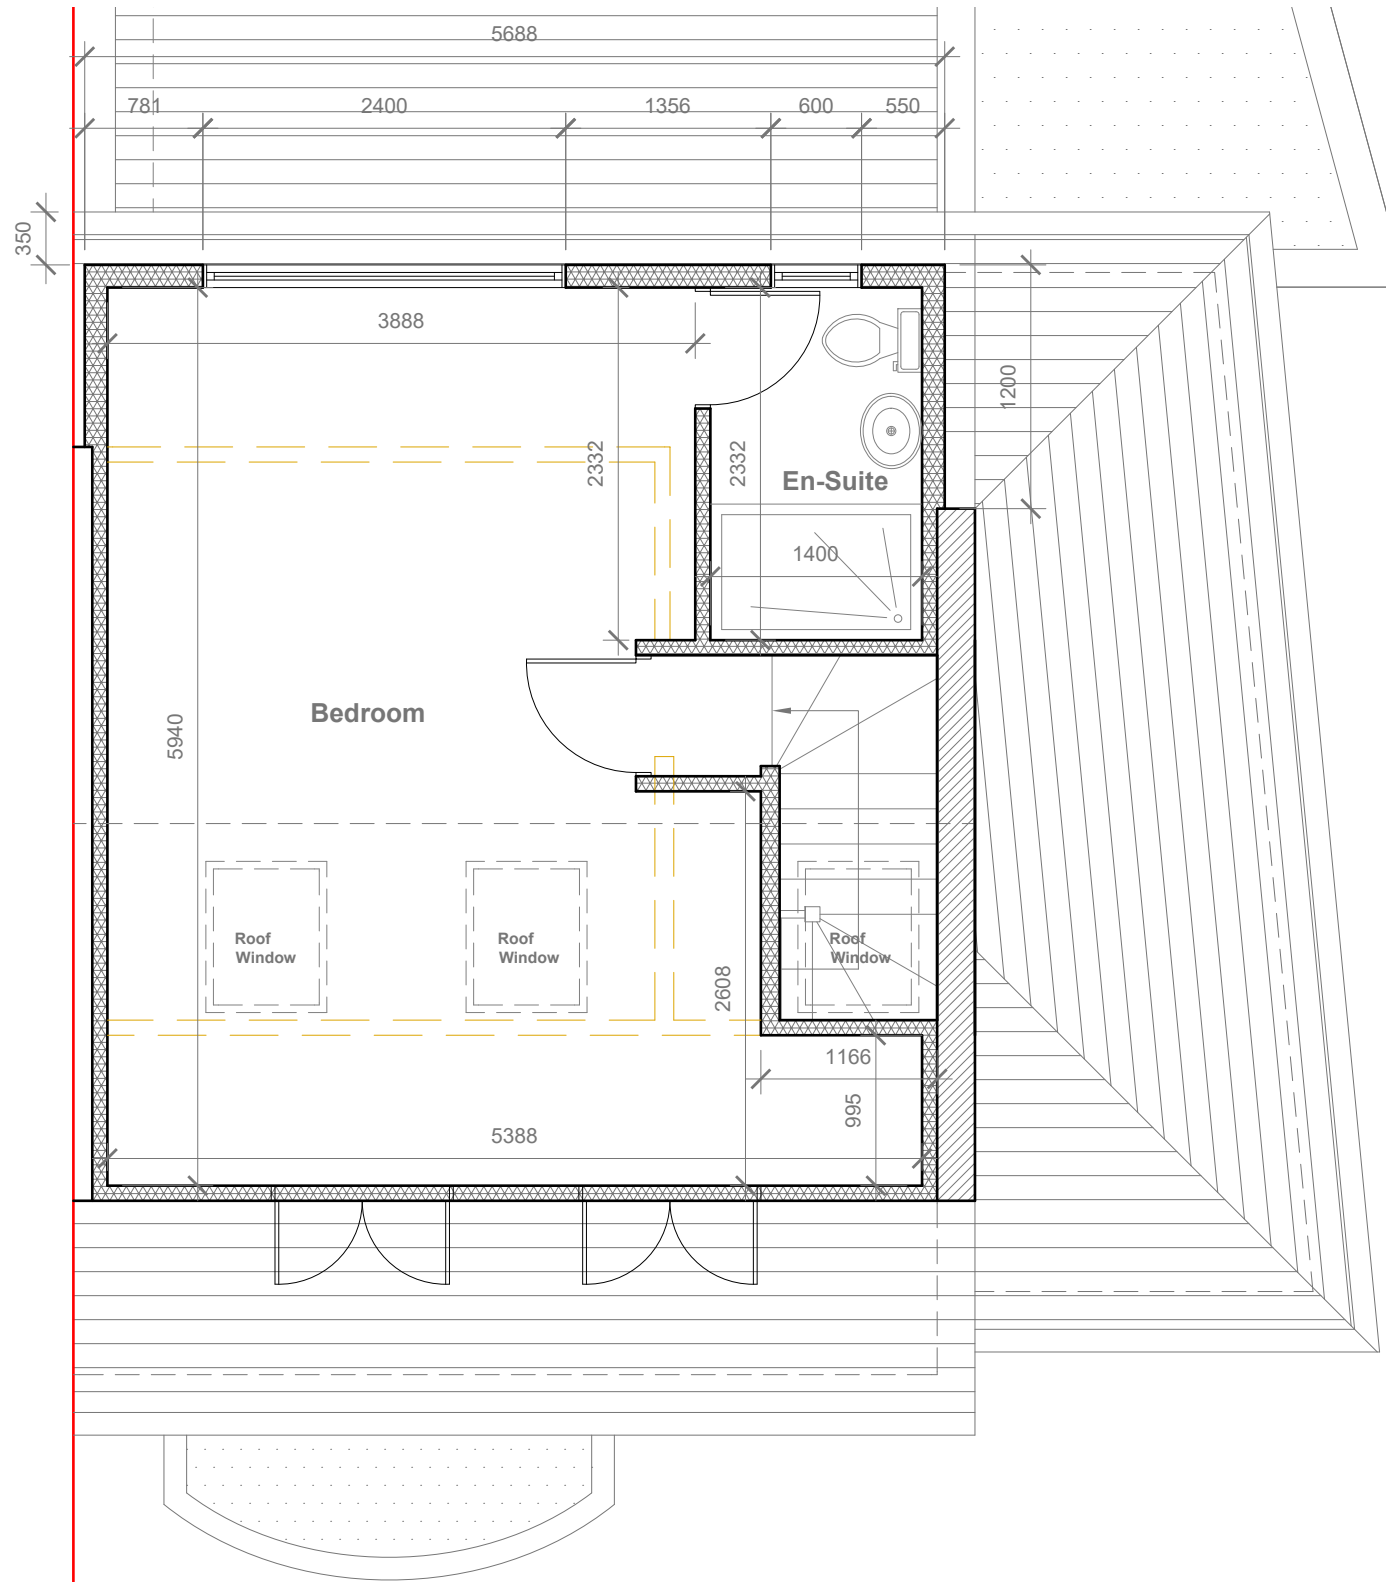

Proposed Loft Floor Plan
Scale 1:50

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Title:

Proposed First Floor & Loft Plans


Site Address
7 Stirling Road,
Hayes, Middx.
UB3 3AQ

Scale: 1:50 @A3
Date: 26/07/2022
Drawing No.:
2022/100 -03
Drawn By:
RO


Revision Date:

e:mail -
faluckpatel@yahoo.com
(M) +44 (0) 7871 466 254

**Faluck
Patel**

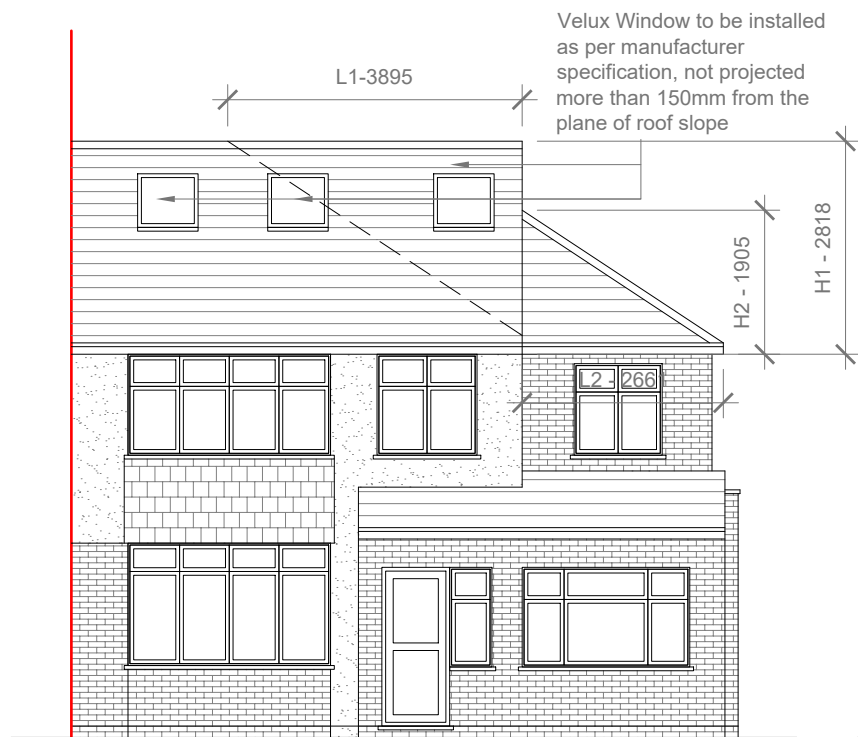


Proposed Front Elevation
Scale 1:100

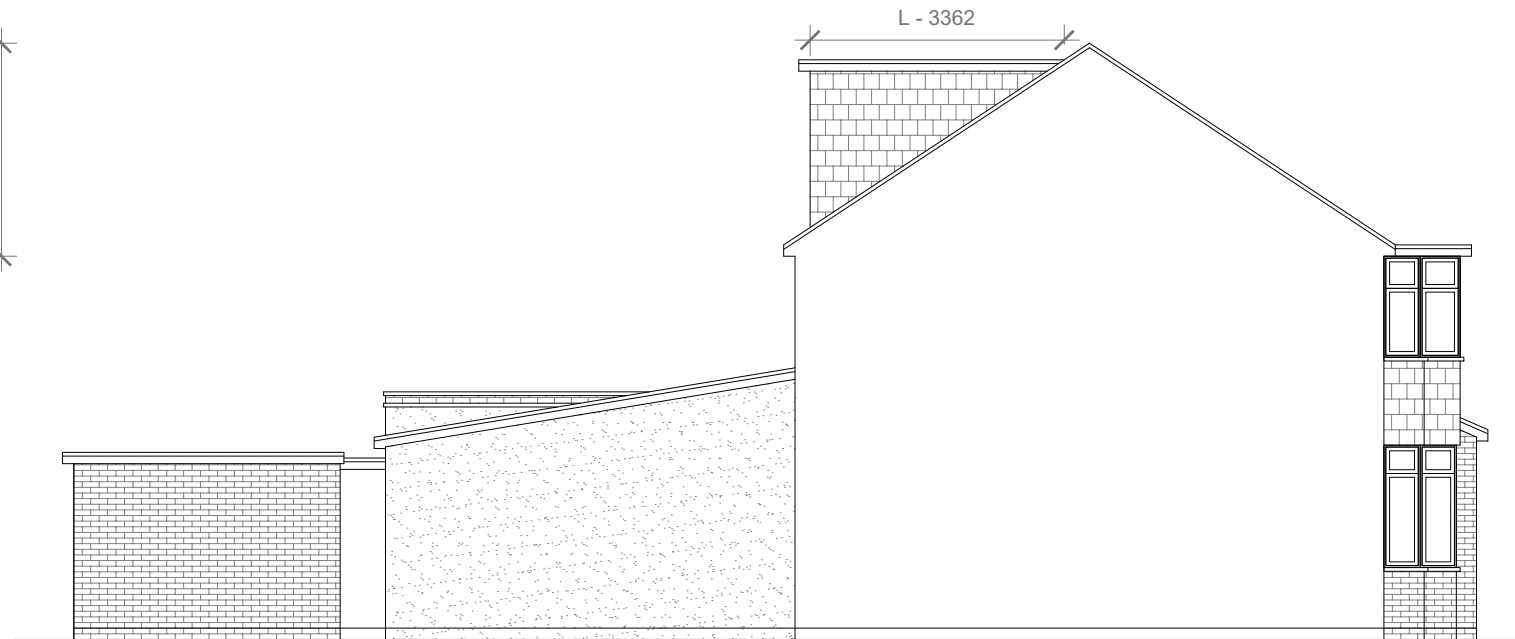

Proposed Side Elevation
Scale 1:100



Proposed Rear Elevation
Scale 1:100

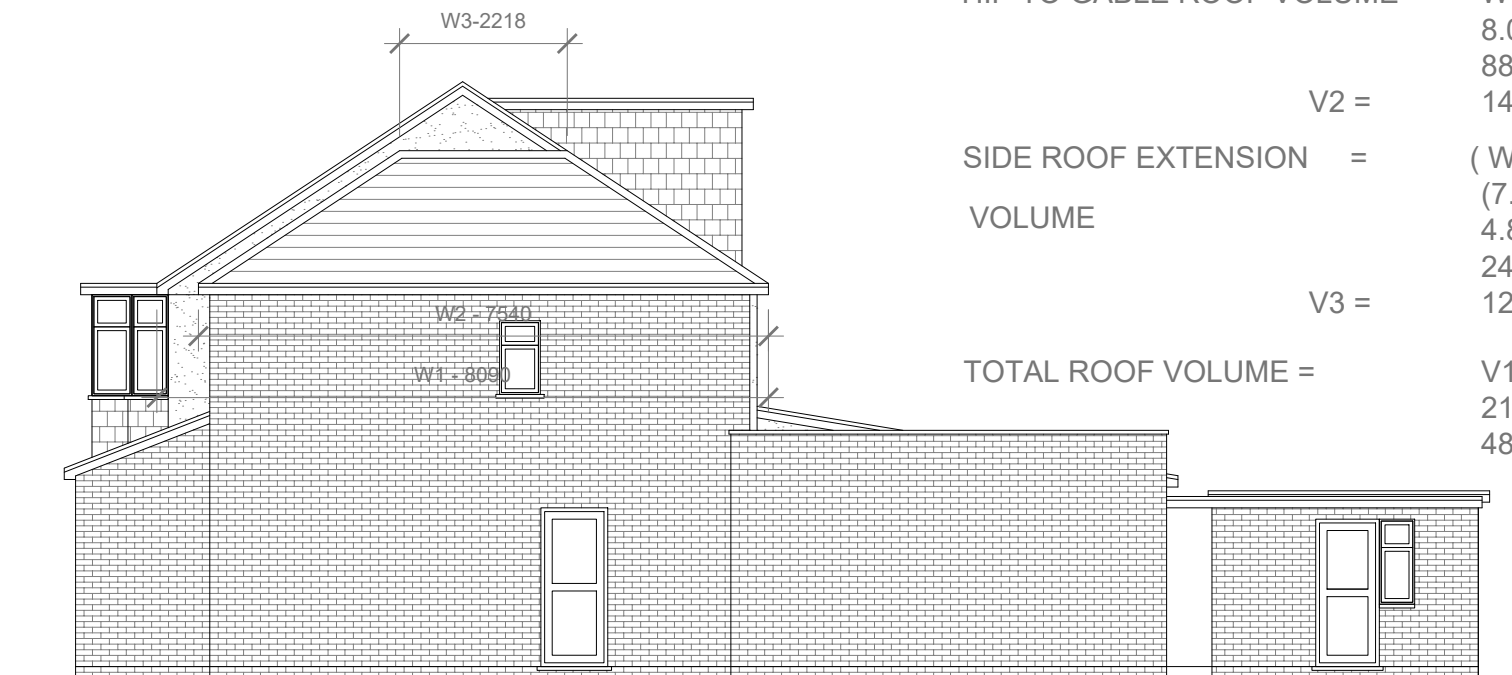

Proposed Side Elevation
Scale 1:100

REAR DORMER VOLUME = $W \times H \times L / 2$
 $5.688 \times 2.217 \times 3.362 / 2$
 $42.39 / 2$
V1 = 21.19 CU.MT.

HIP TO GABLE ROOF VOLUME = $W1 \times H1 \times L1 / 6$
 $8.090 \times 2.818 \times 3.895 / 6$
 $88.79 / 6$
V2 = 14.79 CU.MT.

SIDE ROOF EXTENSION VOLUME = $(W2+W3 / 2) \times H2 \times L2 / 2$
 $(7.540+2.218 / 2) \times 1.905 \times 2.661 / 2$
 $4.879 \times 1.905 \times 2.661 / 2$
 $24.73 / 2$
V3 = 12.36 CU.MT.

TOTAL ROOF VOLUME = $V1 + V2 + V3$
 $21.19 + 14.79 + 12.36$
48.34 CU.MT.< 50.00 CU.MT

Proposed External Finish
Materials to Match Existing
External Finish Materials

Proposed Flank Wall Window
to be Obscure Glazed and
Non Opening below 1.7m
from FFL



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Title:

Proposed Elevations

Site Address

7 Stirling Road,
Hayes, Middx.
UB3 3AQ

Scale: 1:100 @A3

Date: 26/07/2022

Drawing No.:
2022/100 -04

Drawn By:
RO

Revision Date:

e:mail - faluckpatel@yahoo.com (M) +44 (0) 7871 466 254	

**Faluck
Patel**