




EXISTING FRONT ELEVATION
SCALE 1:100

EXISTING SIDE ELEVATION
SCALE 1:100


EXISTING REAR ELEVATION
SCALE 1:100

ROOF EXTENSION VOLUME		
PROPOSED HIP TO GABLE EXTENSION	$\frac{4.04(w) \times 8.14(g) \times 2.84(h)}{6}$	= 15.57 M3
PROPOSED REAR DORMER EXTENSION	$\frac{5.15(w) \times 3.80(g) \times 2.64(h)}{2}$	= 25.83 M3
TOTAL ROOF EXTENSION = 41.40 M3		


IMPORTANT NOTE:
ALL DIMENSIONS TO BE CHECKED AND CONFIRMED ON SITE. TOTAL ROOF EXTENSIONS MUST NOT EXCEED 50 CUBIC METRES MEASURED EXTERNALLY. HEIGHT MUST NOT EXCEED HEIGHT OF ORIGINAL MAIN ROOF RIDGE. ALL WORK MUST BE CONTAINED WITHIN THE SITE BOUNDARIES

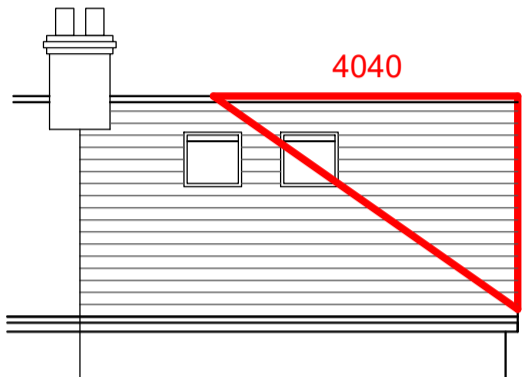


PROPOSED FRONT ELEVATION
SCALE 1:100

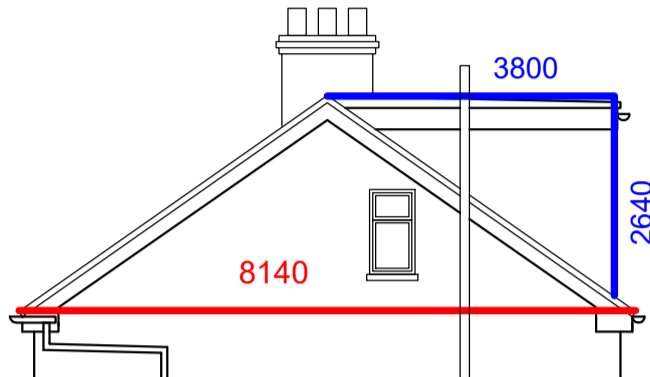


PROPOSED SIDE ELEVATION
SCALE 1:100

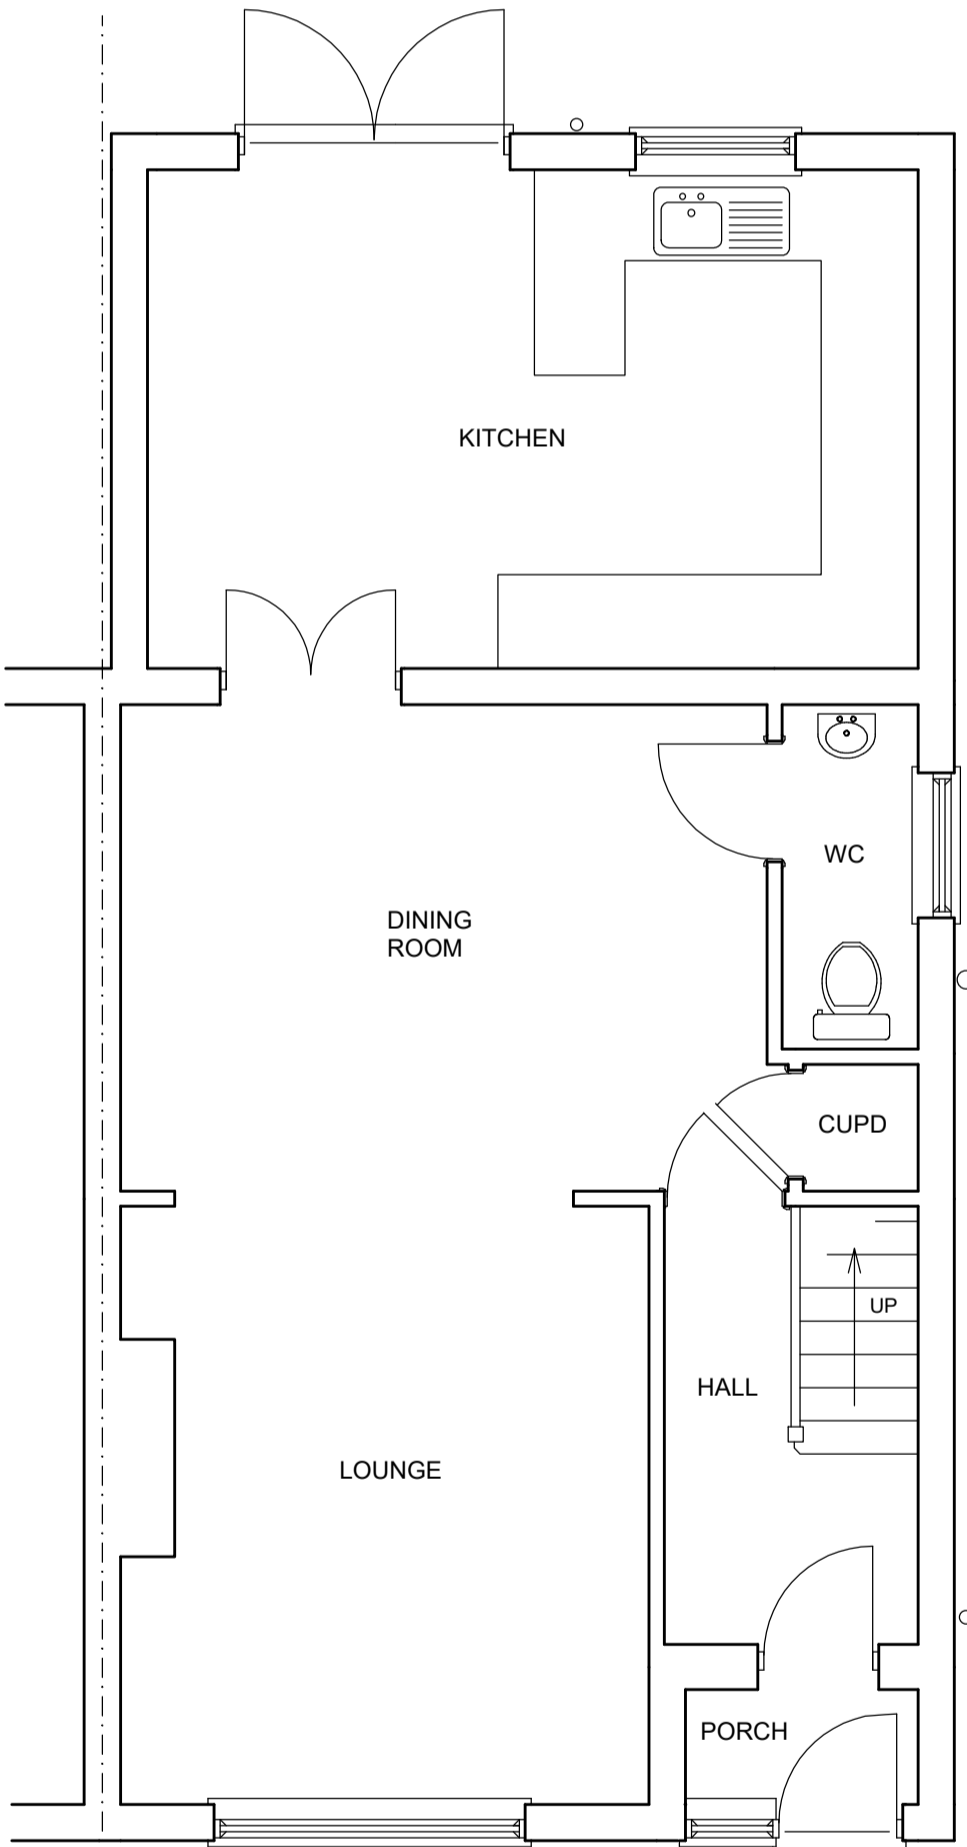

EXISTING GROUND FLOOR PLAN

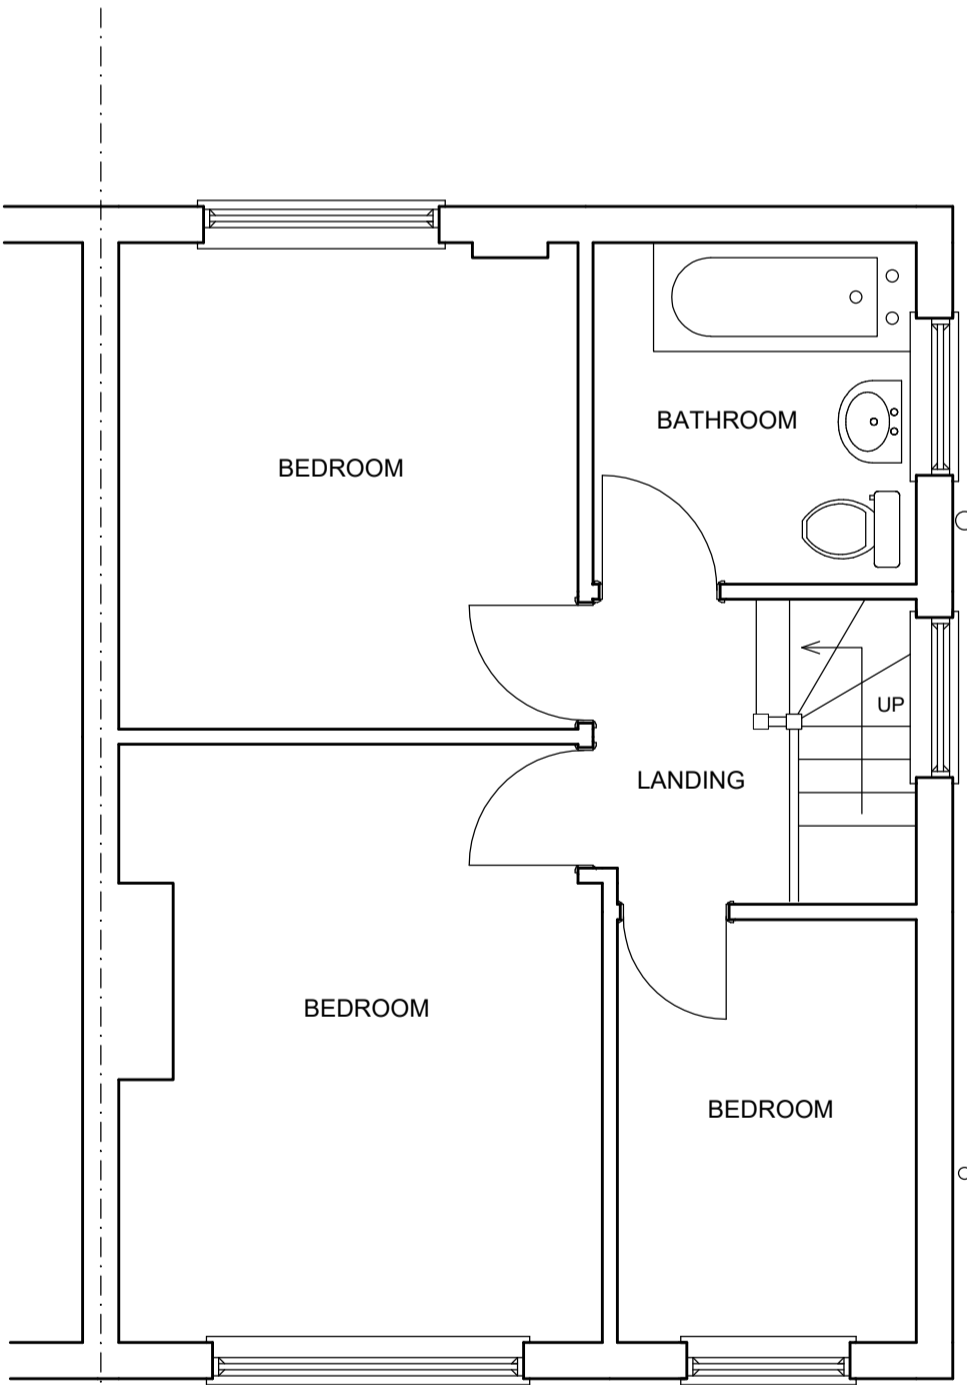

EXISTING FIRST FLOOR PLAN

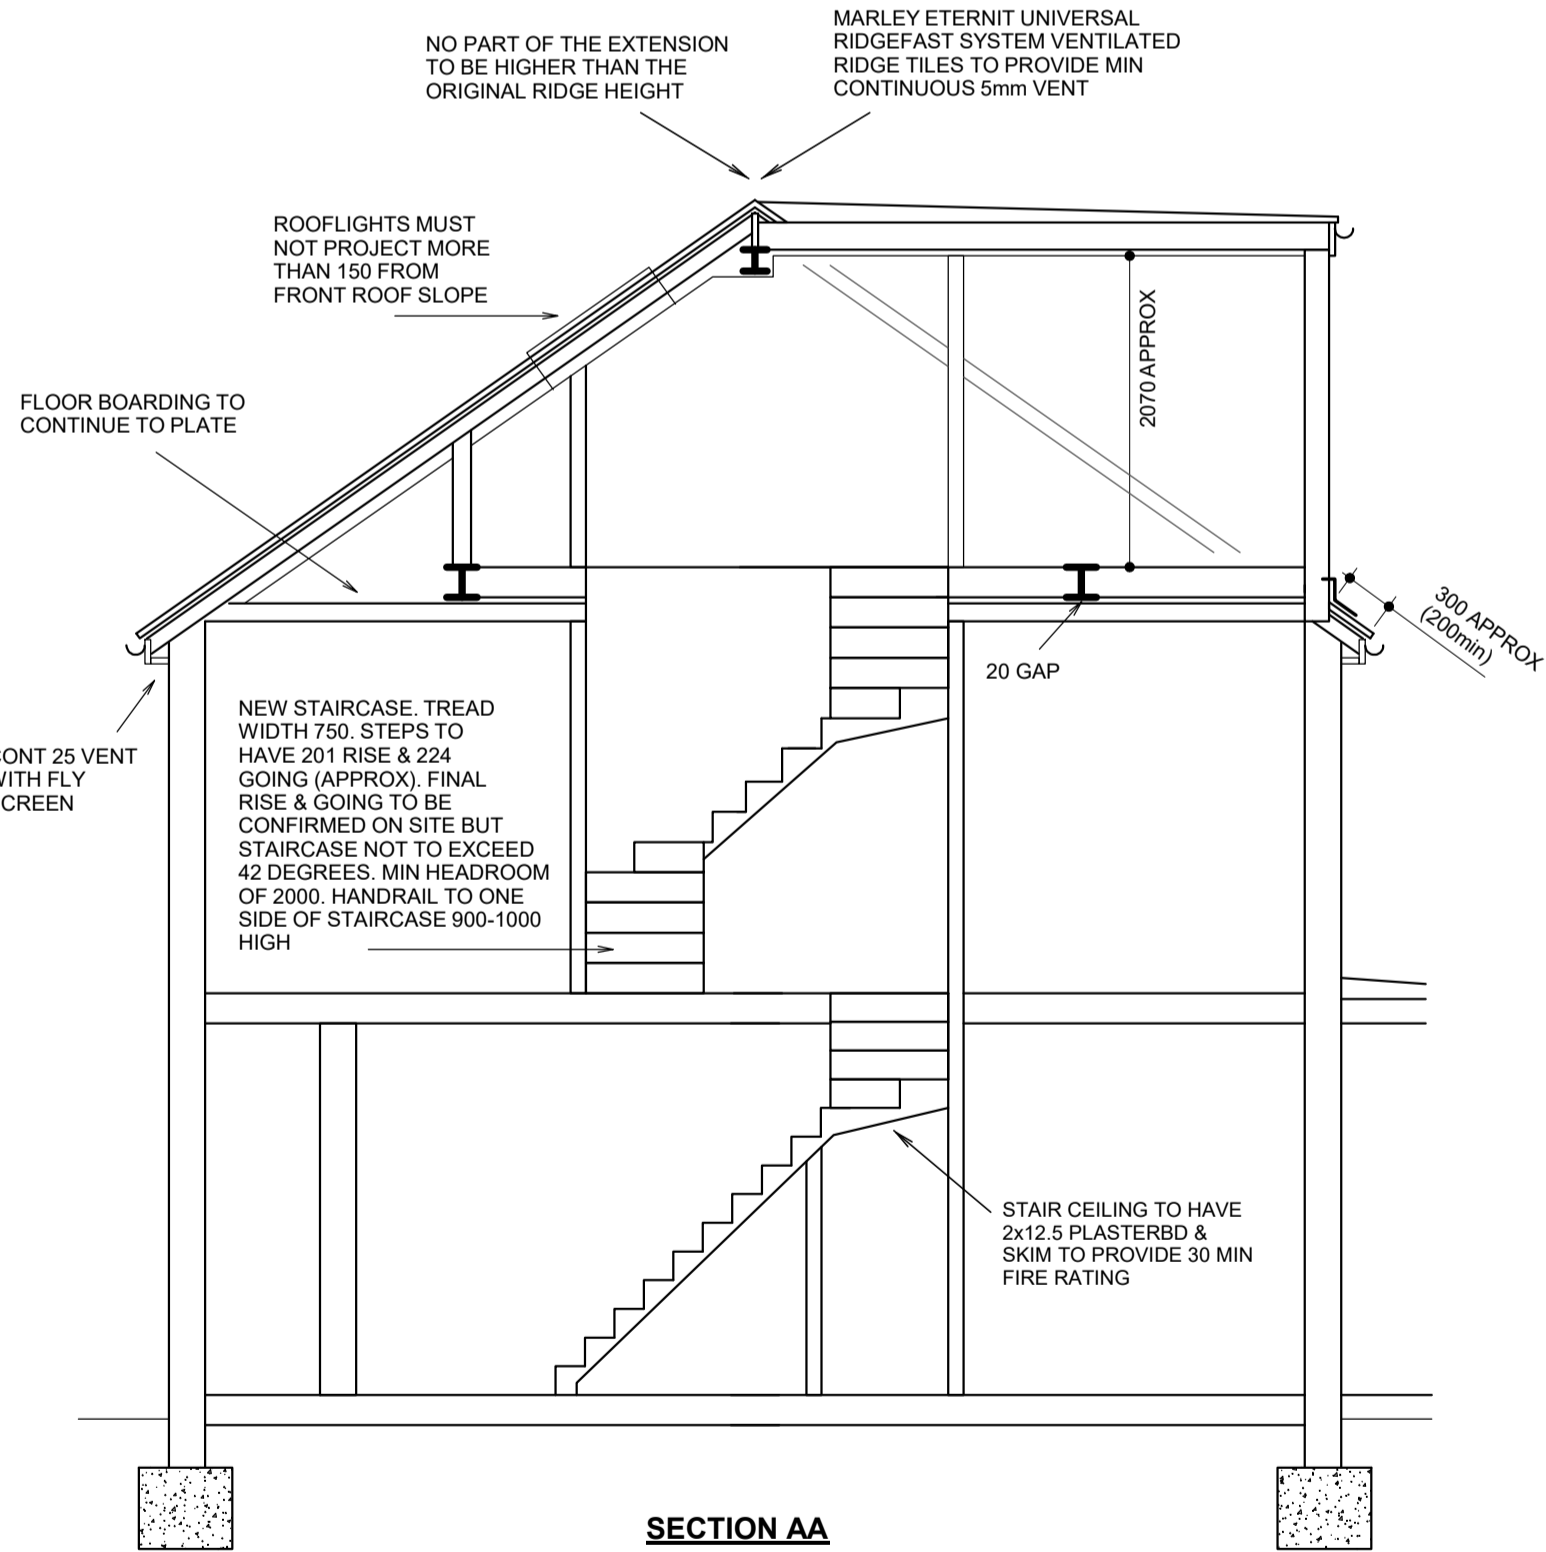

SECTION AA

15 TAVISTOCK ROAD ICKENHAM MIDDx UB10 8PW

LOFT CONVERSION

SCALE 1:50 / 1:100 @ A1

MAY 2022

DRG No. 2311.1

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10.00 METRES @ 1:100

5.00 METRES @ 1:50

BOUNDARIES ESTIMATED AND TO BE CONFIRMED ON SITE. ALL NEW WORKS TO BE CONTAINED WITHIN TRUE BOUNDARIES UNLESS STATED OTHERWISE ON PLAN. ALL NEW WORK TO COMPLY WITH CURRENT BUILDING REGULATIONS. DIMENSIONS IN MILLIMETRES AND TO BE CONFIRMED ON SITE. ALL STEEL DIMENSIONS TO BE CONFIRMED ON SITE AND NOT BE TAKEN FROM STRUCTURAL CALCULATIONS. ALL DRAINS & TREES ARE ESTIMATED AND ARE TO BE CHECKED & CONFIRMED ON SITE BEFORE ANY WORK COMMENCES. CLIENT TO SERVE PARTY WALL ACT NOTICE BEFORE WORK COMMENCES. ALL WORK TO BE CARRIED OUT & SUPERVISED BY COMPETENT OPERATIVES.

DUE TO SURVEY LIMITATIONS EXISTING JOIST SPANS ASSUMED UNTIL CONFIRMED ON SITE. ALL WALLS & PARTITIONS TO BE CONSIDERED LOADBEARING UNTIL OPENED UP ON SITE AND CHECKED BY COMPETENT PERSON TO CONFIRM OTHERWISE. MUST BE CONFIRMED BEFORE ANY WORK COMMENCES. IF STRUCTURAL ENGINEERS DESIGN RELATING TO STRUCTURAL ELEMENTS CONTRADICTS ARCHITECTURAL DRAWINGS/SPED - ENGINEERS DESIGN PREVAILS. THIS DRAWING IS FOR PLANNING & BUILDING REGULATION APPLICATION PURPOSES ONLY. BUILDER/CLIENT TO APPOINT COM CONSULTANT TO ENSURE WORKS COMPLY WITH COM REGULATIONS BEFORE WORK COMMENCES. SINCE WE HAVE NO ACCESS TO THE DEEDS OF THE PROPERTY IT IS THE RESPONSIBILITY OF THE CLIENT TO ENSURE THAT THE WORKS DO NOT CONTRAVENE ANY RESTRICTIVE COVENANTS CONTAINED IN THE DEEDS.