





EXISTING & PROPOSED
GROUND FLOOR
Scale 1 : 100 @ A3
Scale 1 : 50 @ A1

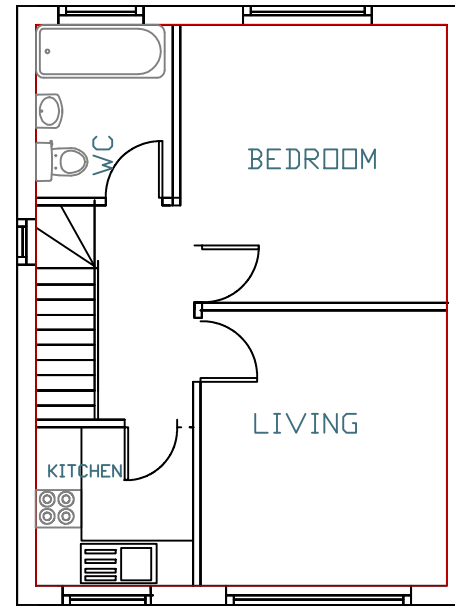


EXISTING FIRST FLOOR
Scale 1 : 100 @ A3
Scale 1 : 50 @ A1

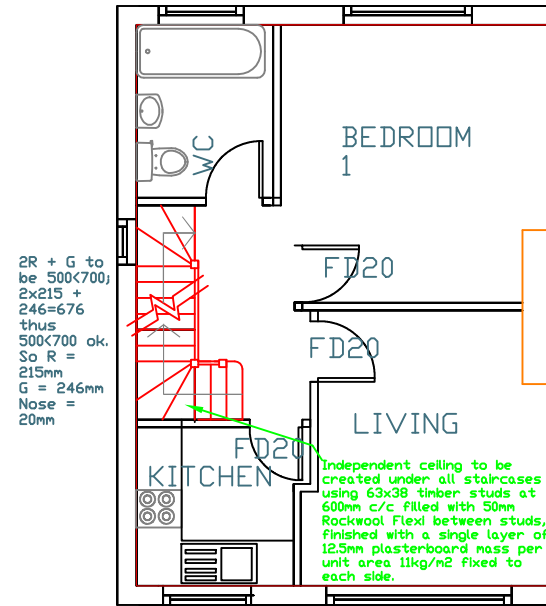

PROPOSED FIRST FLOOR
Scale 1 : 100 @ A3
Scale 1 : 50 @ A1

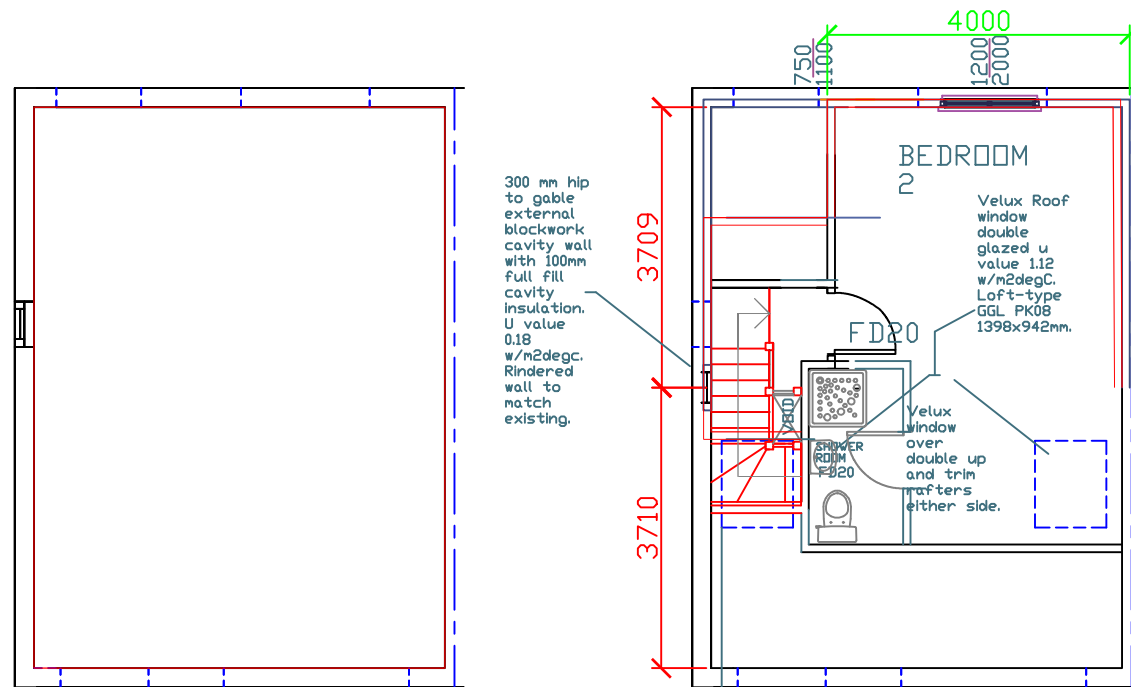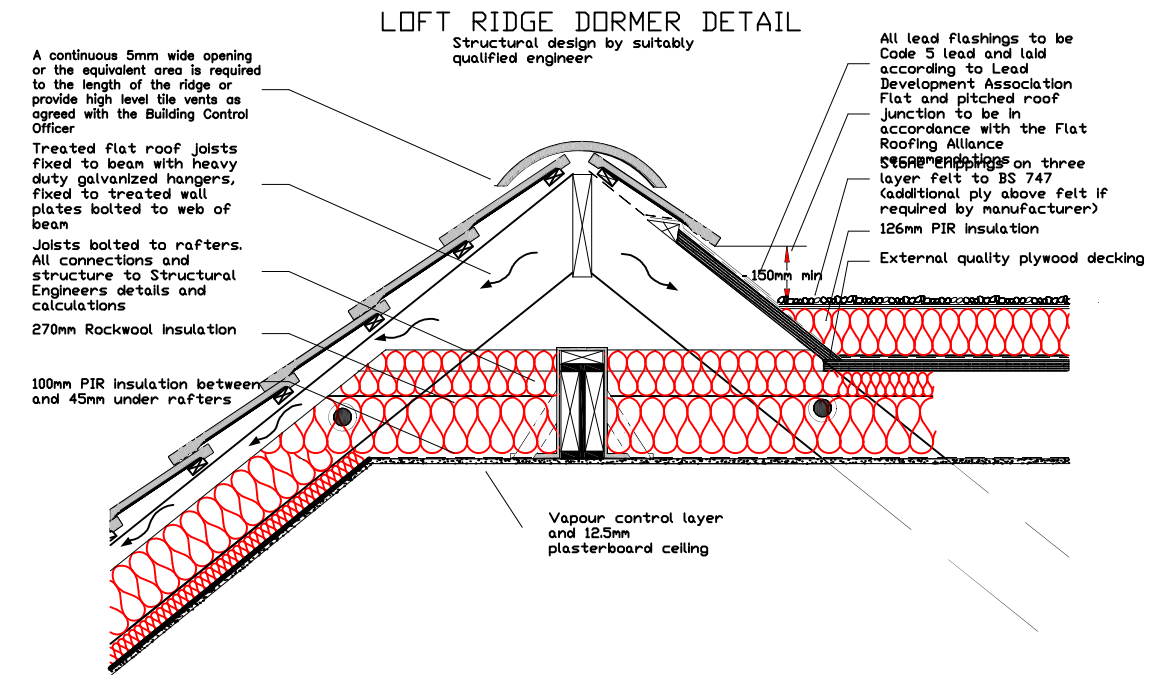


EXISTING LOFT
Scale 1 : 100 @ A3
Scale 1 : 50 @ A1

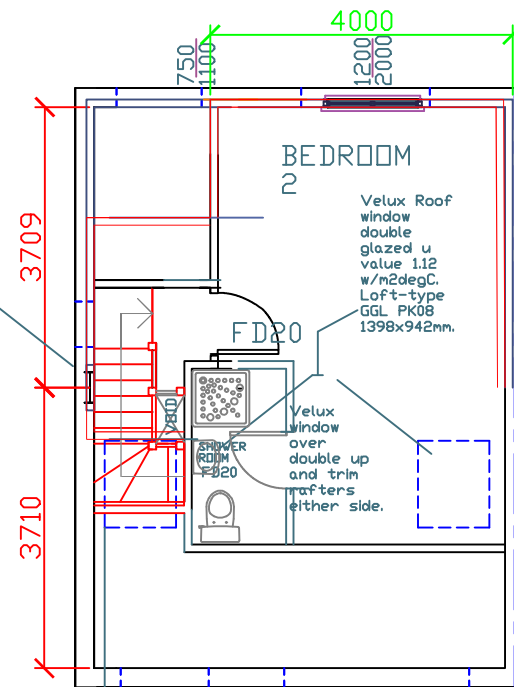

PROPOSED LOFT PLAN
Scale 1 : 100 @ A3
Scale 1 : 50 @ A1


Tiled/Slate/Copper Roof to match existing/adjoining properties

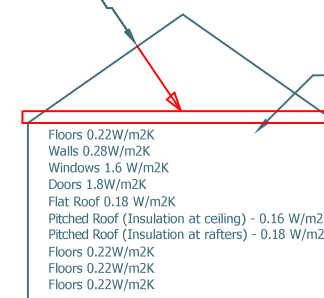

The **new extension** should comply with the requirements of Part L1b of Building Regulations in regard to insulation above.

If the contractor wants to deviate from standard detail specs. provided, then, please provide details of how these U-Values values will be achieved.

NOTE: Where the party wall is upgraded a lesser value of 0.30 W/m²K is acceptable

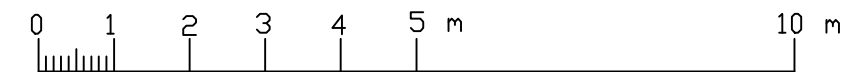

CLIENT		SCALE	
KAMLASH ANANAD		1:50 @	
PROJECT		DATE	
PROPOSED LOFT CONVERSION AT First Floor, 4A DOGHURST AVENUE HARLINGDON, HAYES MIDDLESEX UB3 5BJ		08.06.2022	
DRAWING TITLE	DWG. NO.	REV.	
EXISTING AND PROPOSED FLOOR PLANS AND LOFT PLAN	4DOGH/HIPL01		