


Existing Ground Floor Plan
Scale 1:100



Existing First Floor Plan
Scale 1:100

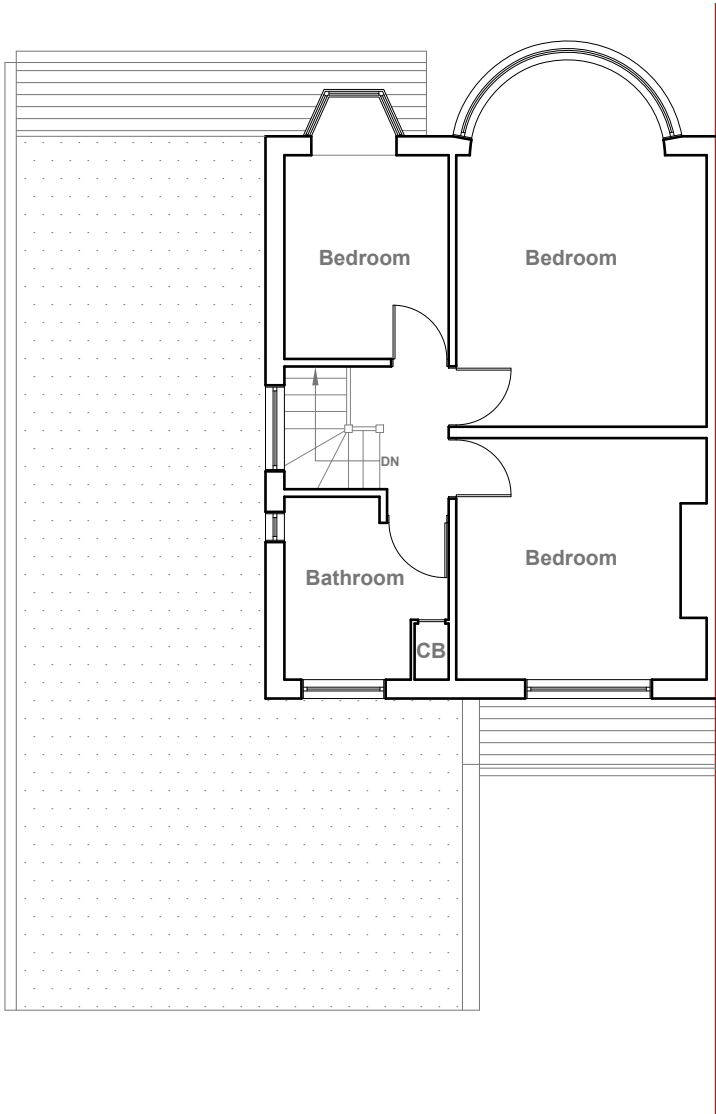

GENERAL NOTES:
1. ALL DIMENSIONS ARE IN MILLIMETER.
2. VERIFY ALL DIMENSIONS AND CONDITIONS BEFORE BUILDING OR STARTING CONSTRUCTION. NOTIFY THE DESIGNER IMMEDIATELY OF ANY DISCREPANCY OR VARIATION.
3. ALL WORK TO COMPLY WITH CURRENT BUILDING REGULATIONS AND CODES OF PRACTICE

Title:

Existing Floor Plans

Site Address
127 Cornwall Road
Ruislip
Middlesex
HA4 6AH

Scale: 1:100 @A3
Date: 15/11/2025
Drawing No.: 2021/169 -01
Drawn By: RO

Revision Date:

e:mail -
faluckpatel@yahoo.com
(M) +44 (0) 7871 466 254






Existing Front Elevation
Scale 1:100



Existing Side Elevation
Scale 1:100



Existing Rear Elevation
Scale 1:100

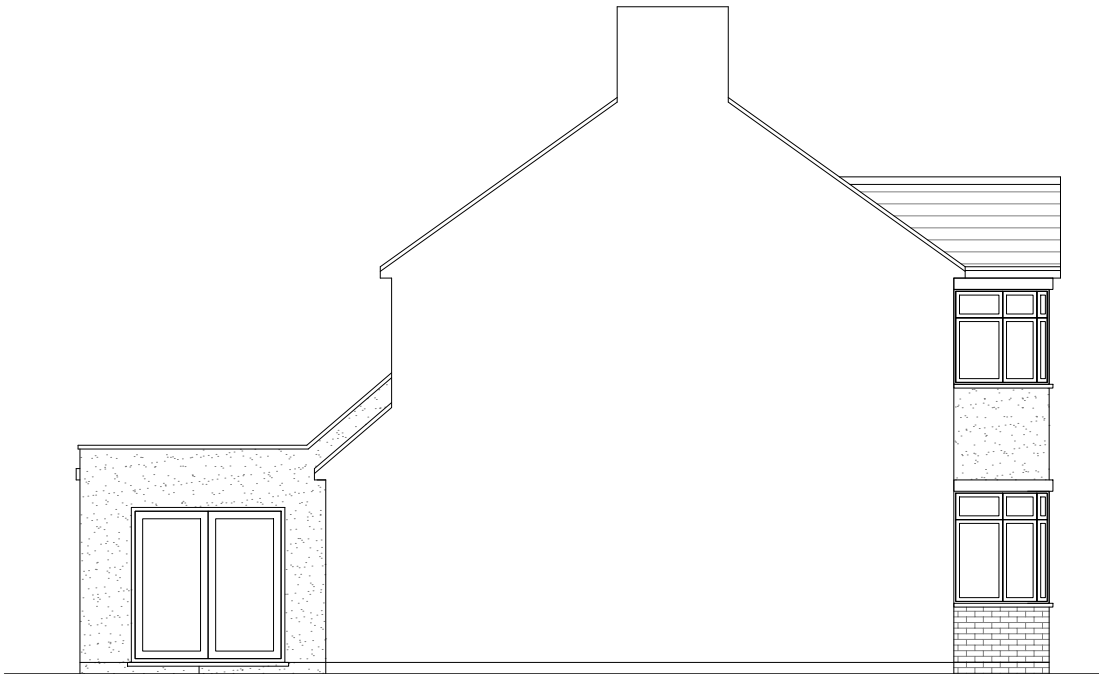

Existing Side Elevation
Scale 1:100



GENERAL NOTES:
1. ALL DIMENSIONS ARE IN MILLIMETER.
2. VERIFY ALL DIMENSIONS AND CONDITIONS BEFORE BUILDING OR STARTING CONSTRUCTION. NOTIFY THE DESIGNER IMMEDIATELY OF ANY DISCREPANCY OR VARIATION.
3. ALL WORK TO COMPLY WITH CURRENT BUILDING REGULATIONS AND CODES OF PRACTICE

Title:

Existing Elevations


Site Address
127 Cornwall Road
Ruislip
Middlesex
HA4 6AH

Scale: 1:100 @A3
Date: 15/11/2025
Drawing No.: 2021/169 -02
Drawn By: RO


Revision Date:

e:mail -
faluckpatel@yahoo.com
(M) +44 (0) 7871 466 254



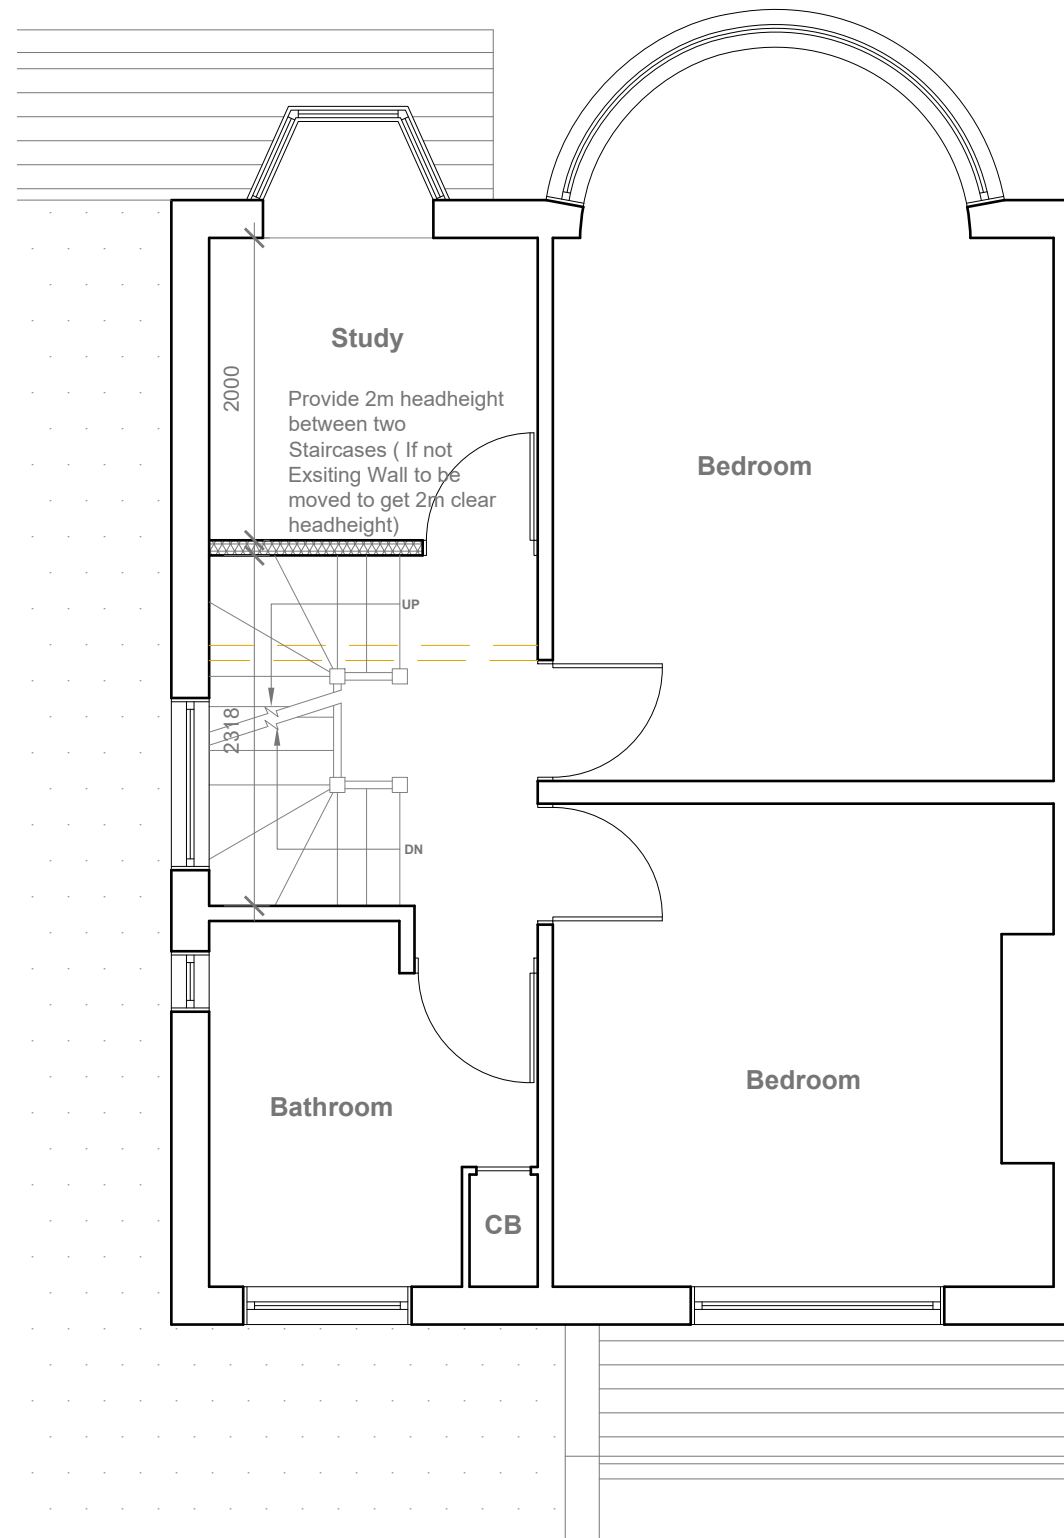

Proposed First Floor Plan
Scale 1:50

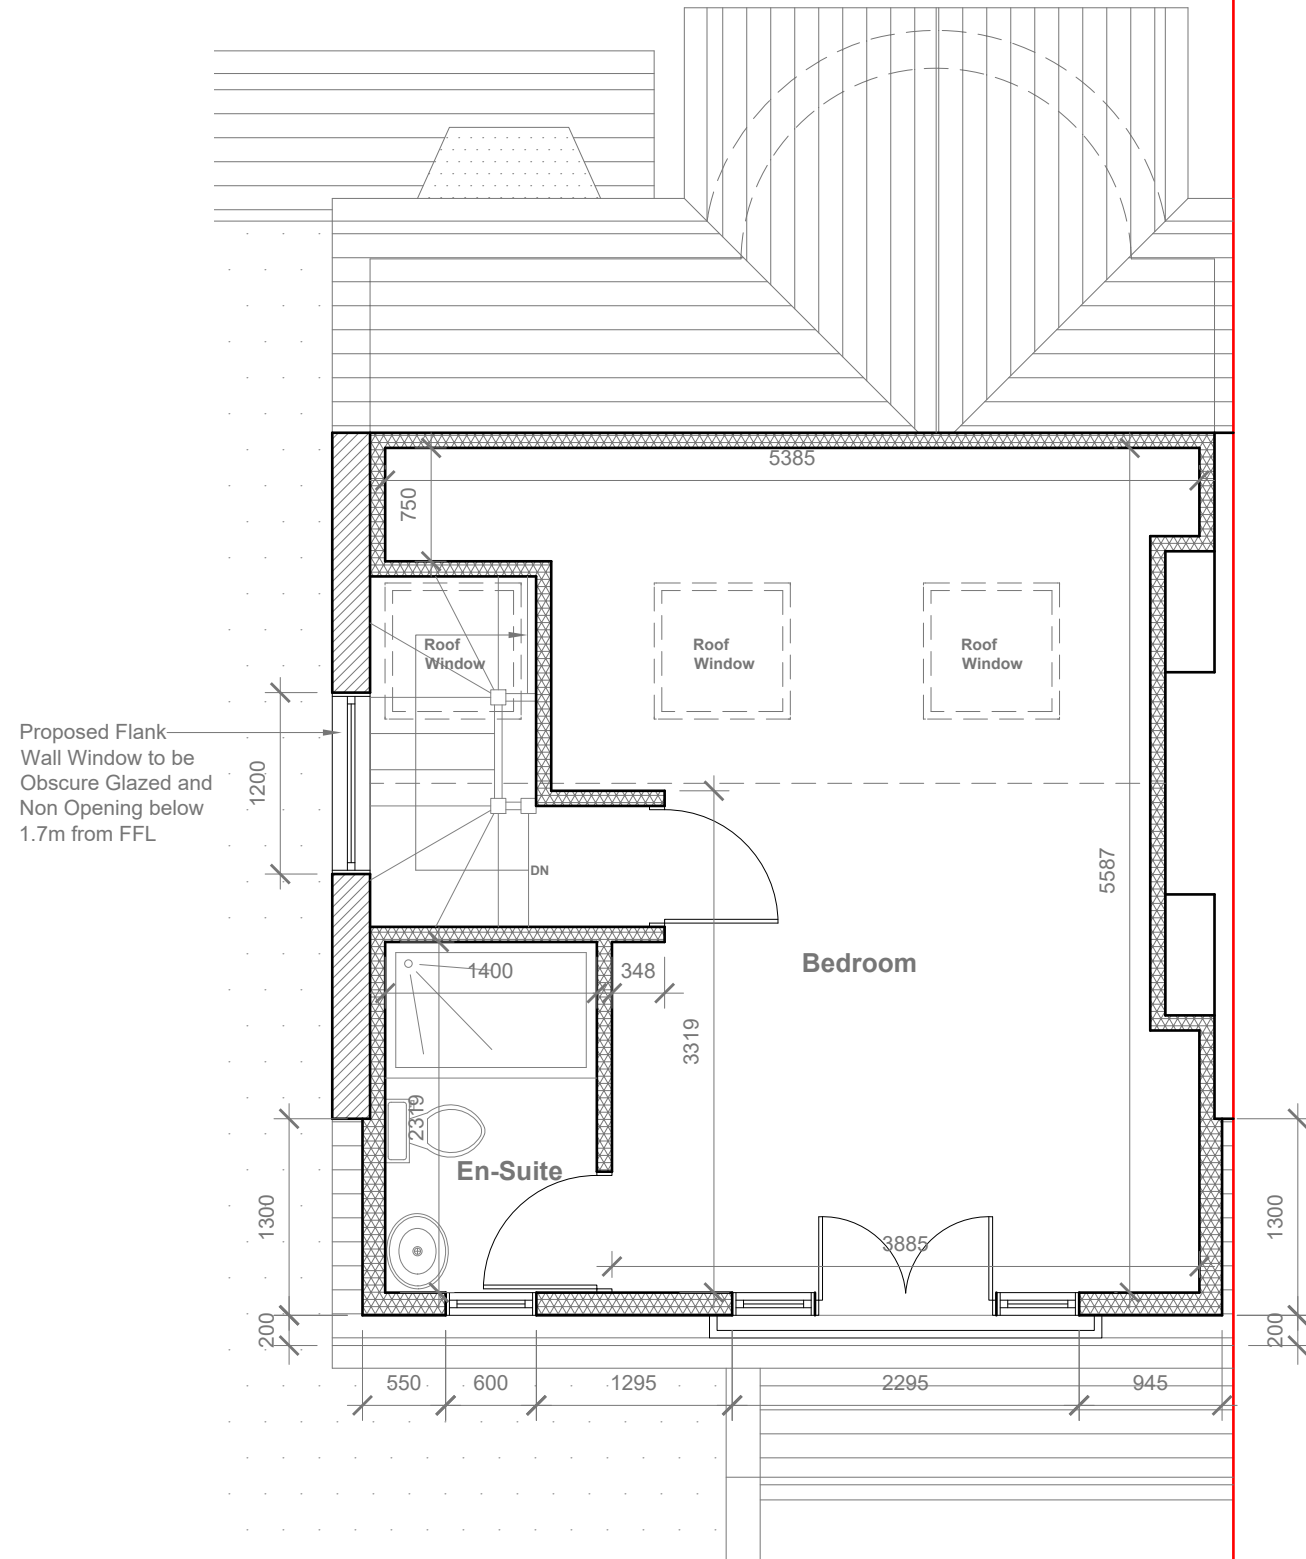

Proposed Loft Floor Plan
Scale 1:50

Velux Window to be installed as per manufacturer specification, not projected more than 150mm from the plane of roof slop



- GENERAL NOTES:
1. ALL DIMENSIONS ARE IN MILLIMETER.
 2. VERIFY ALL DIMENSIONS AND CONDITIONS BEFORE BUILDING OR STARTING CONSTRUCTION. NOTIFY THE DESIGNER IMMEDIATELY OF ANY DISCREPANCY OR VARIATION.
 3. ALL WORK TO COMPLY WITH CURRENT BUILDING REGULATIONS AND CODES OF PRACTICE

Title:

Proposed First Floor & Loft Plans

Site Address

127 Cornwall Road
Ruislip
Middlesex
HA4 6AH

Scale: 1:50 @A3

Date: 15/11/2025

Drawing No.:
2021/169 -03

Drawn By:
RO

Revision Date:

e:mail - faluckpatel@yahoo.com (M) +44 (0) 7871 466 254	

**Faluck
Patel**




Proposed Front Elevation
Scale 1:100



Proposed Rear Elevation
Scale 1:100



Proposed Side Elevation
Scale 1:100

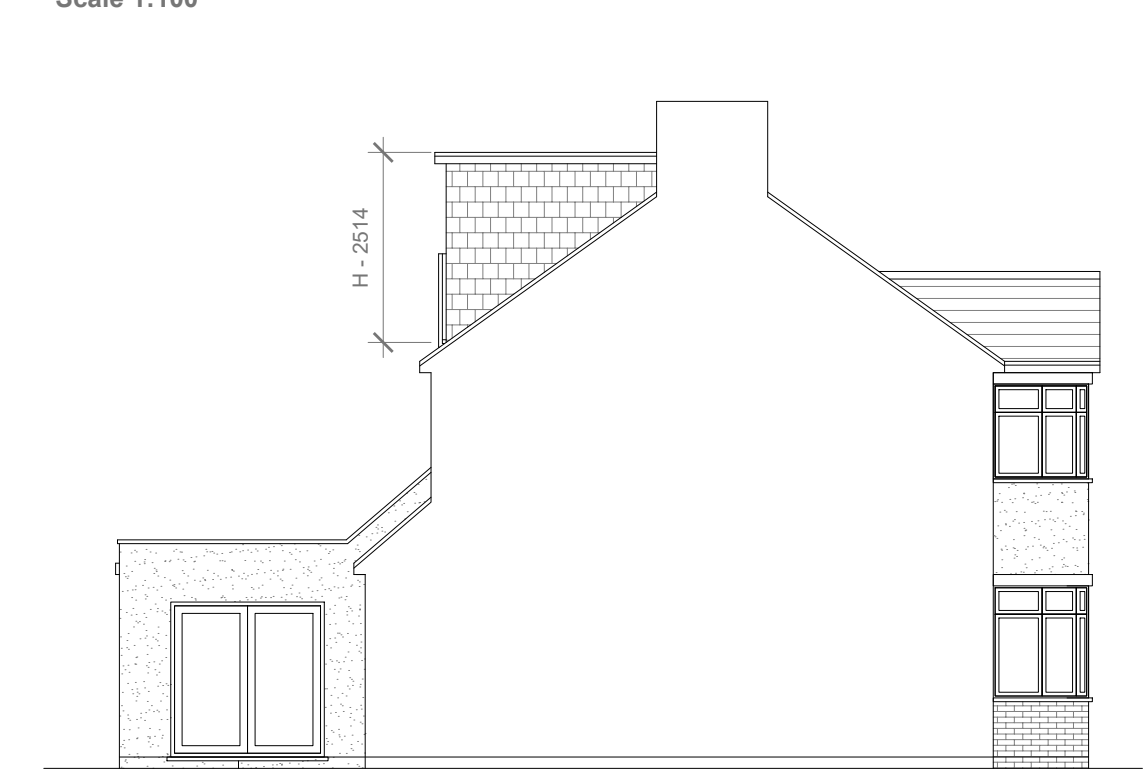

Proposed Side Elevation
Scale 1:100

Proposed External Finish
Materials to Match Existing
External Finish Materials

REAR DORMER VOLUME = $W \times H \times L / 2$
 $5.689 \times 2.514 \times 3.518 / 2$
 $50.31 / 2$
V1 = 25.15 CU.MT.

HIP TO GABLE ROOF VOLUME = $W1 \times H1 \times L1 / 6$
 $7.737 \times 2.914 \times 3.722 / 6$
 $83.91 / 6$
V2 = 13.98 CU.MT.

TOTAL ROOF VOLUME = $V1 + V2$
 $25.15 + 13.98$
39.13 CU.MT.< 40.00 CU.MT



GENERAL NOTES:
1. ALL DIMENSIONS ARE IN MILLIMETER.
2. VERIFY ALL DIMENSIONS AND CONDITIONS BEFORE BUILDING OR STARTING CONSTRUCTION. NOTIFY THE DESIGNER IMMEDIATELY OF ANY DISCREPANCY OR VARIATION.
3. ALL WORK TO COMPLY WITH CURRENT BUILDING REGULATIONS AND CODES OF PRACTICE

Title:

Proposed Elevations

Site Address	Scale: 1:100 @A3	Revision Date:
127 Cornwall Road	Date: 15/11/2025	
Ruislip	Drawing No.:	
Middlesex	2021/169 -04	
HA4 6AH	Drawn By:	
	RO	e:mail - faluckpatel@yahoo.com (M) +44 (0) 7871 466 254

