

General Notes:

All dimensions are in millimeters unless noted otherwise.


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1 LOCATION PLAN
SCALE 1:1250 @ A3




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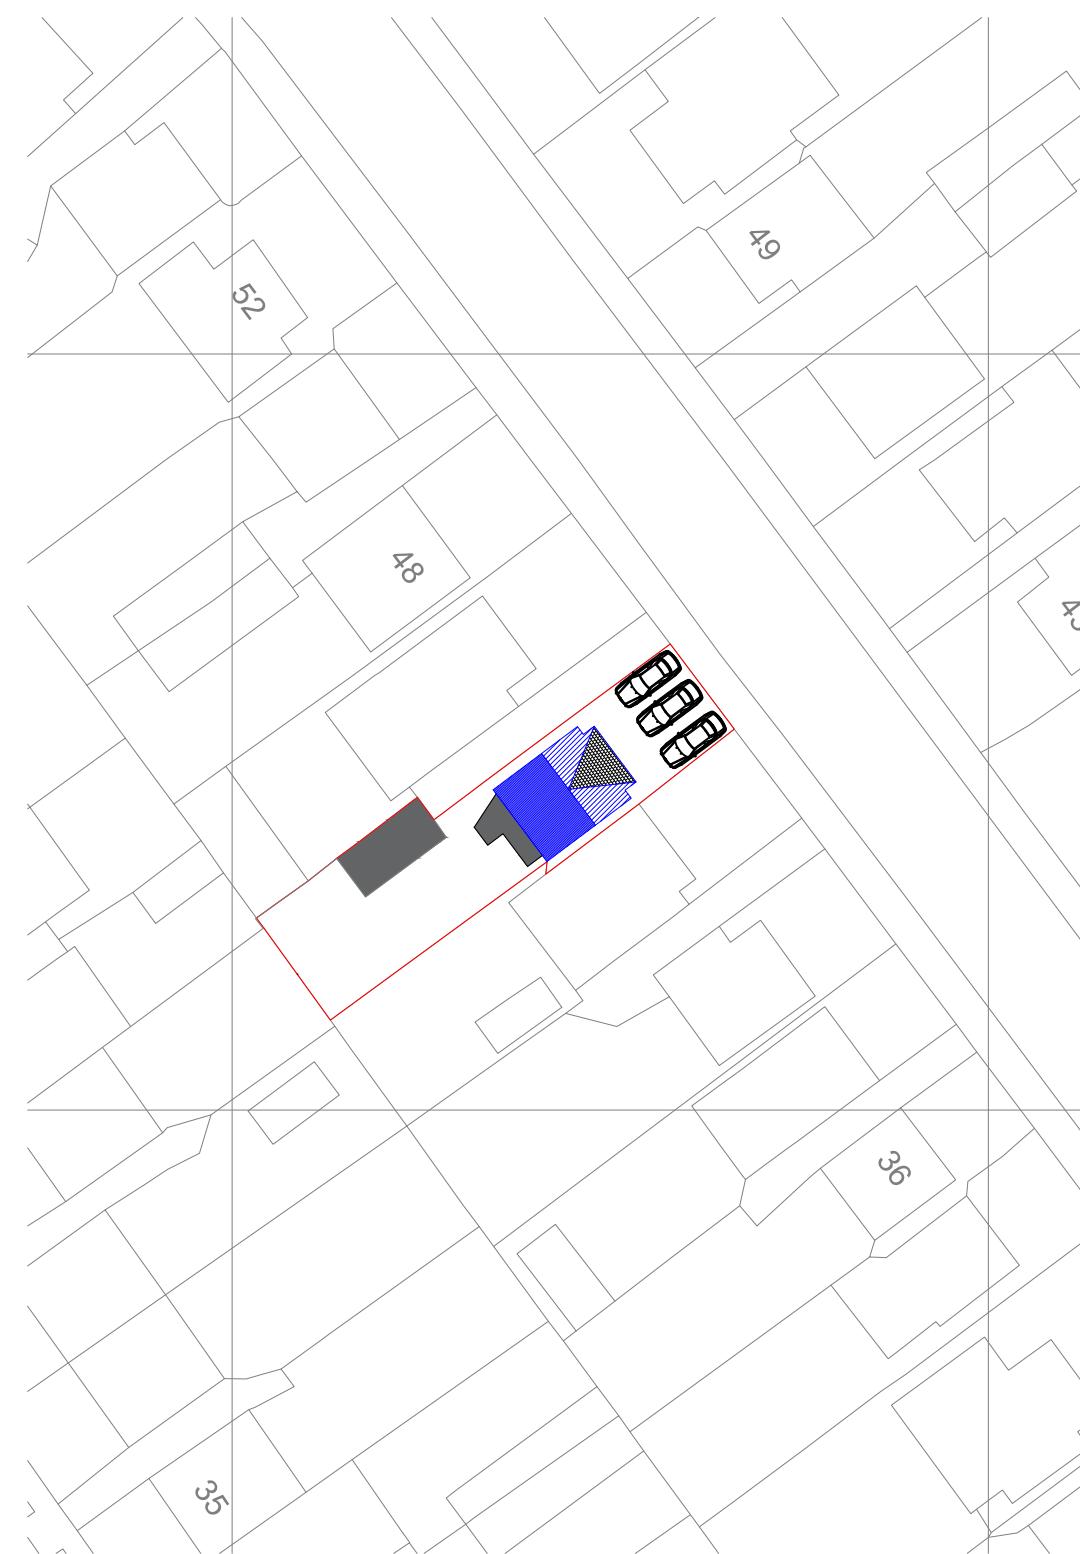
Contact: 0207 459 4194
Email: support@statimbuild.com

Client:	Alan Rock
Project Title:	Loft conversion
Project Address:	44 Mount Pleasant, Ruislip HA4 9HG, UK
Client ID:	564452143


Drawing Title	Date: 14.07.2022
Location plan	
Scale	1:1250
Drawn By: DP	Checked By: ZA
Approved By: AR	
Drawing No. SB22/AR/001	Revisions 01

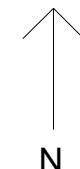

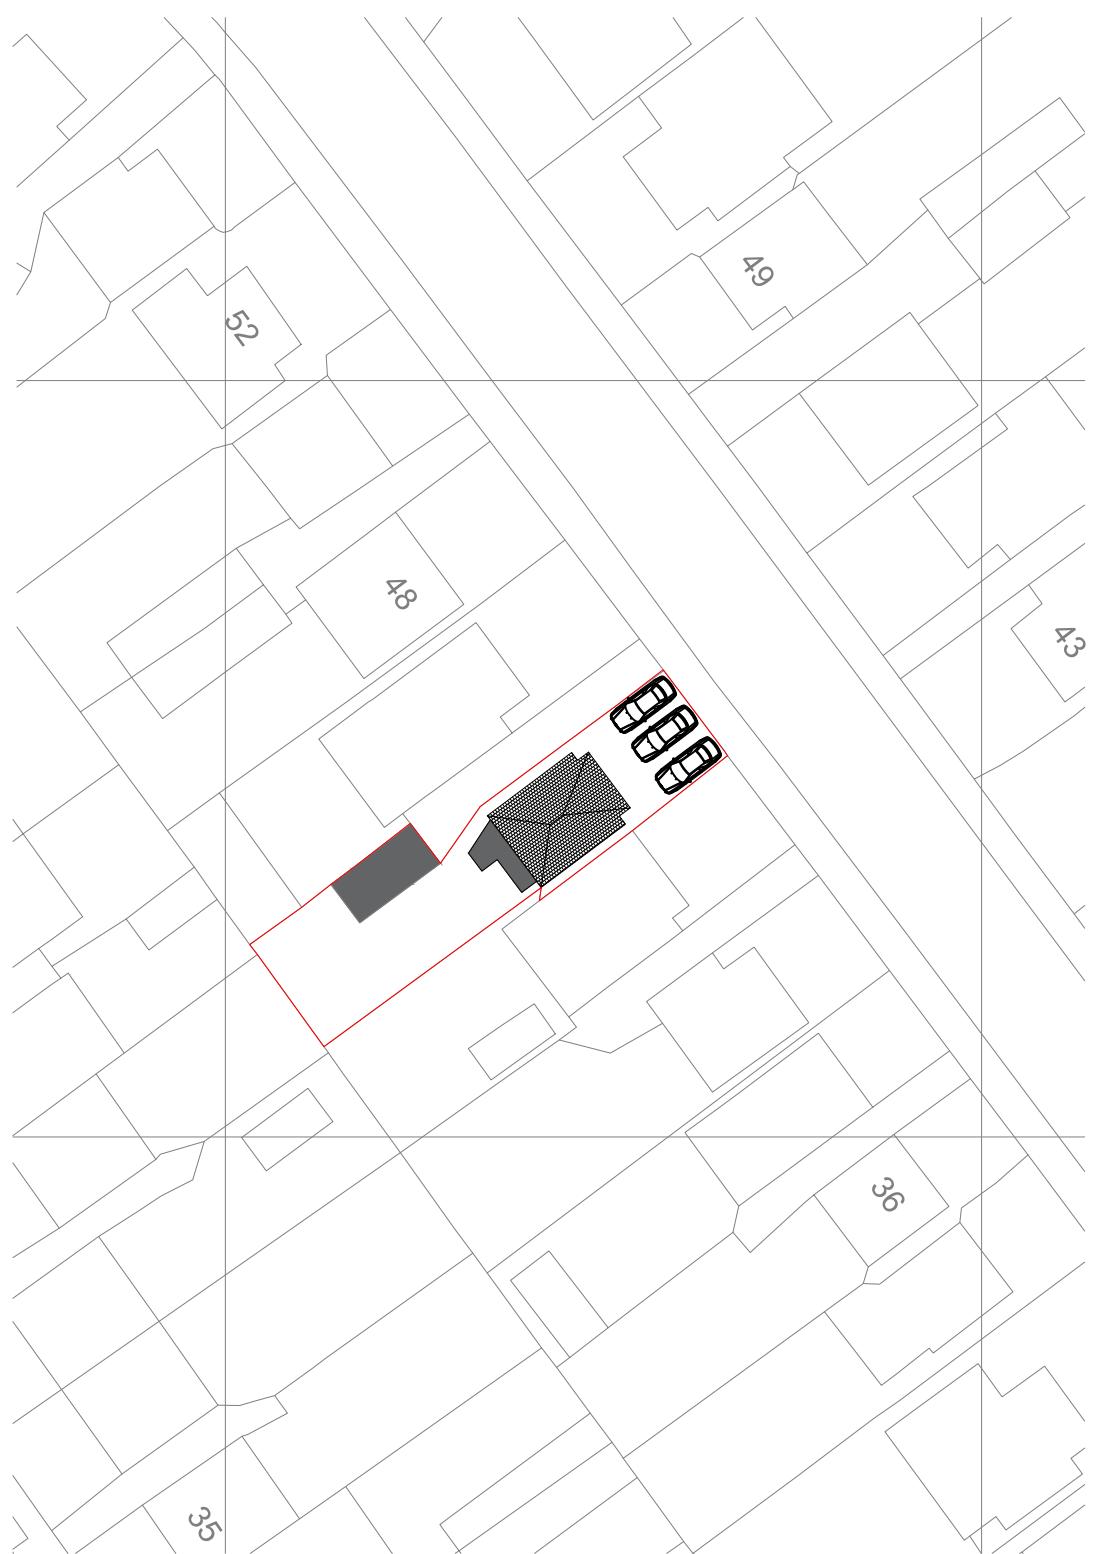2 BLOCK PLAN EXISTING
SCALE 1:500 @ A3



3 BLOCK PLAN PROPOSED
SCALE 1:500 @ A3

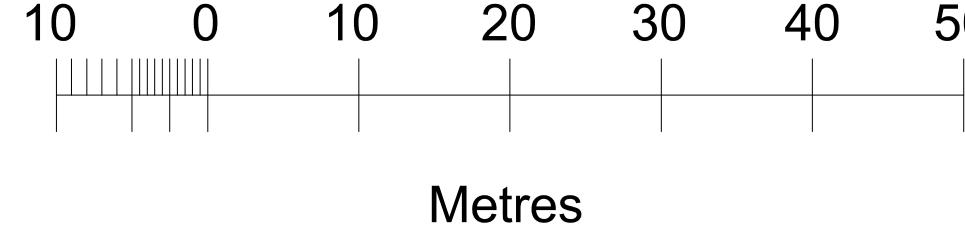

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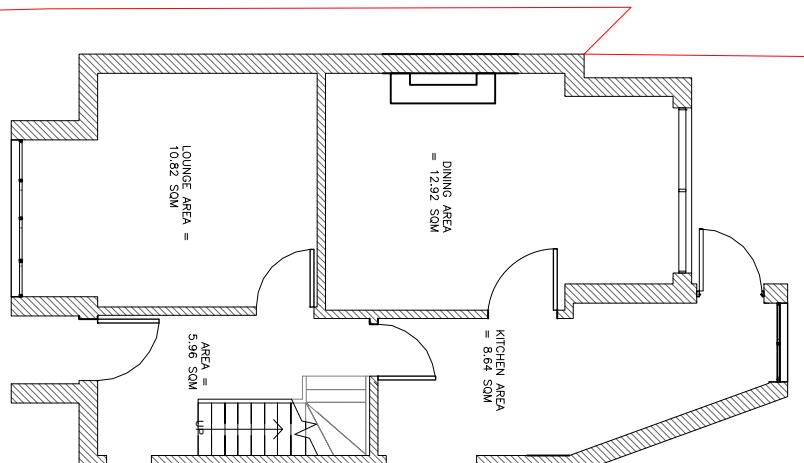
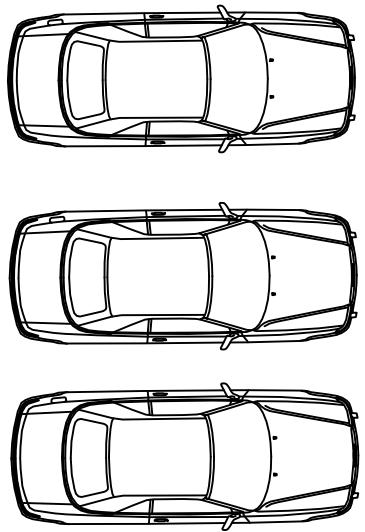
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London, W5 3HJ

Contact: 0207 459 4194
Email: support@statimbuild.com

Client:
Alan Rock
Project Title:
Loft Conversion Rear Dormer
Project Address:
44 Mount Pleasant, Ruislip
HA4 9HG
Client ID:
564452143

Drawing Title Date: 19.08.2022
Block Plans
Scale 1:500 A3
Drawn By: ZA Checked By: HM Approved By: MA
Drawing No. SB21/AR/002 Revisions 04

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Existing Ground Floor Area (measured externally) = 49.72 sqm

**4 EXISTING GROUND FLOOR
PLAN** SCALE 1:100 @ A3



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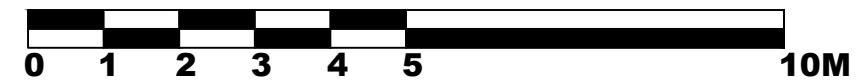
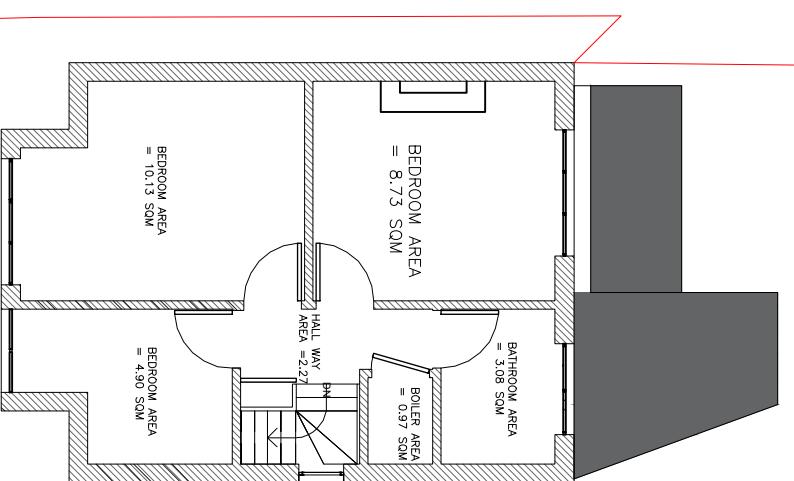
Contact: 0207 459 4194
Email: support@statimbuild.com

Client:	Alan Rock
Project Title:	Loft conversion
Project Address:	44 Mount Pleasant, Ruislip HA4 9HG, UK
Client ID:	564452143


Drawing Title	Date: 19.08.2022
Existing plans	
Scale	1:200
Drawn By: ZA	Checked By: HM
Approved By: AR	Revisions 01
Drawing No. SB22/AR/003	

Existing First Floor Area (measured externally) = 40.51 sqm

**5 EXISTING FIRST FLOOR
PLAN** SCALE 1:100 @ A3



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Existing Loft Floor Area (measured externally)= 40.51 sqm

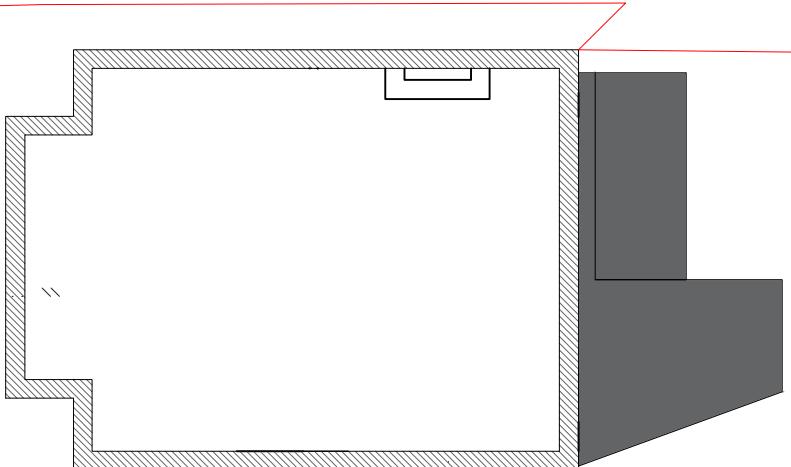
6 EXISTING LOFT PLAN
 SCALE 1:100 @ A3




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 Ealing House,
 33 Hanger Lane,
 London, W5 3HJ

Contact: 0207 459 4194
 Email: support@statimbuild.com

Client:
 Alan Rock
 Project Title:
 Loft conversion
 Project Address:
 44 Mount Pleasant,
 Ruislip HA4 9HG, UK
 Client ID:
 564452143

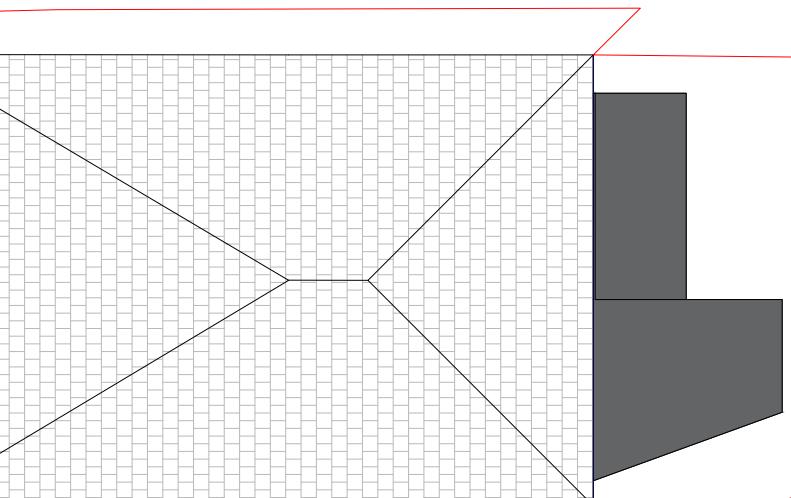


7 EXISTING ROOF PLAN
 SCALE 1:100 @ A3

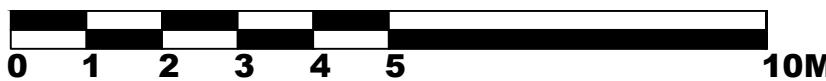

Drawing Title | Date: 19.08.2022
 Existing plans
 Scale
 1:200 | A3
 Drawn By: ZA | Checked By: HM | Approved By: AR
 Drawing No. SB22/AR/004 | Revisions 01

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8 EXISTING FRONT ELEVATION

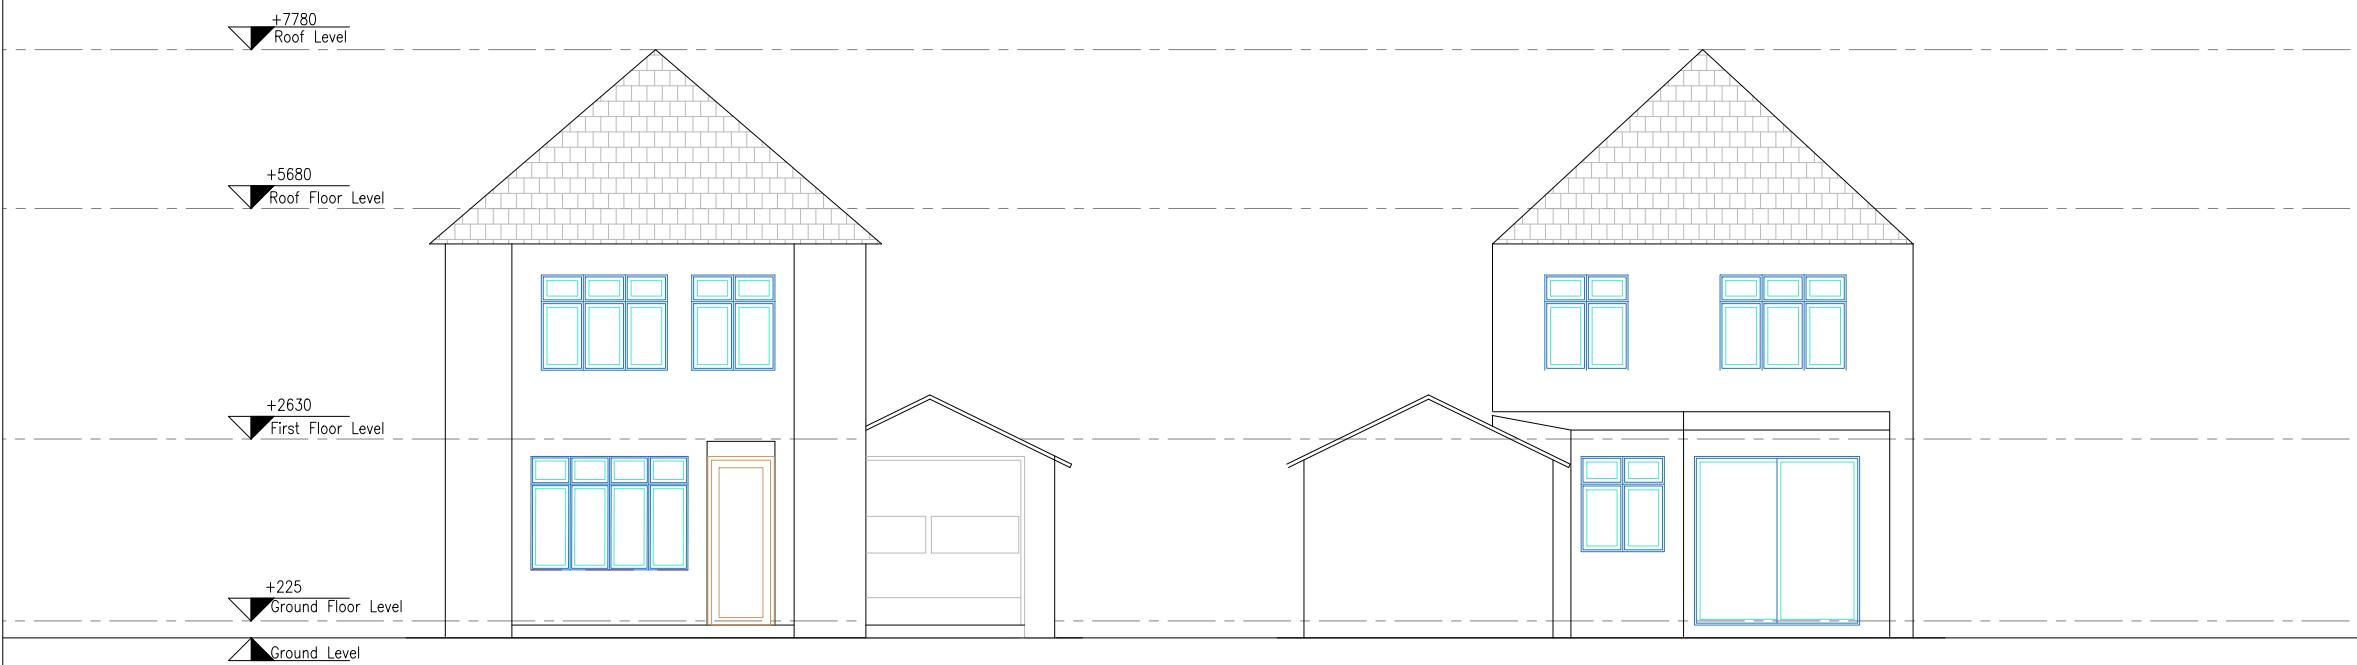SCALE 1:100 @ A3

9 EXISTING REAR ELEVATION

SCALE 1:100 @ A3




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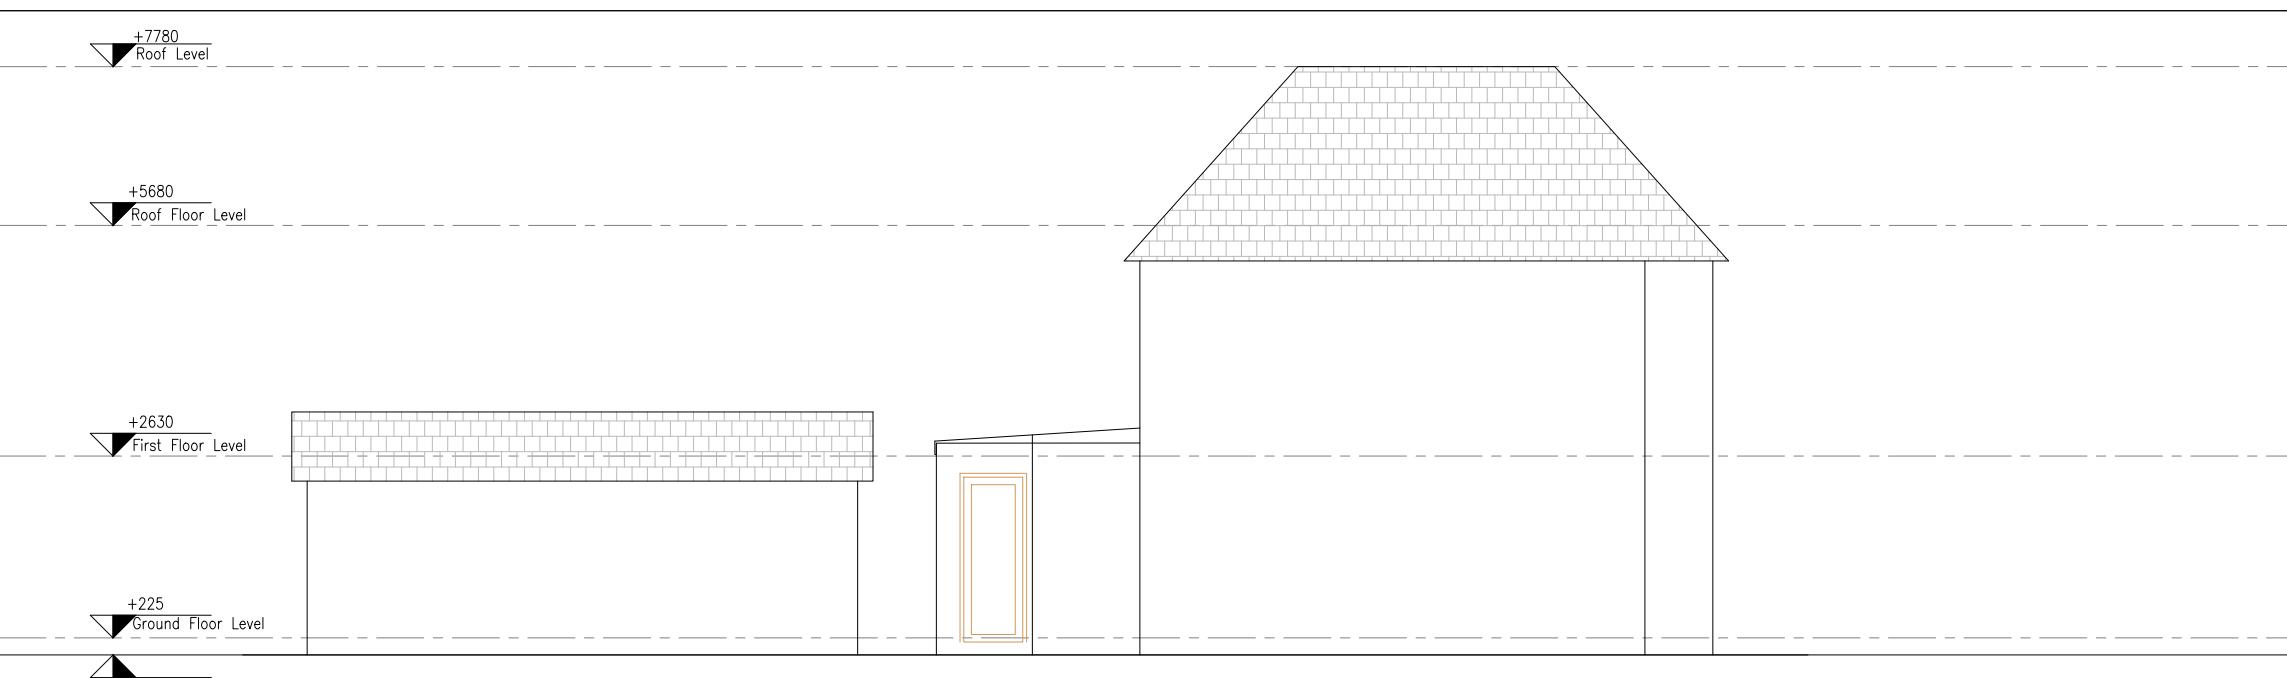
Contact: 0207 459 4194
 Email: support@statimbuild.com

Client:	Alan Rock
Project Title:	Loft conversion
Project Address:	44 Mount Pleasant, Ruislip HA4 9HG, UK
Client ID:	564452143

Drawing Title	Date: 19.08.2022
Existing elevations	
Scale	A3
1:100	
Drawn By: ZA	Checked By: DP
Approved By: AR	
Drawing No. SB22/AR/005	Revisions 01

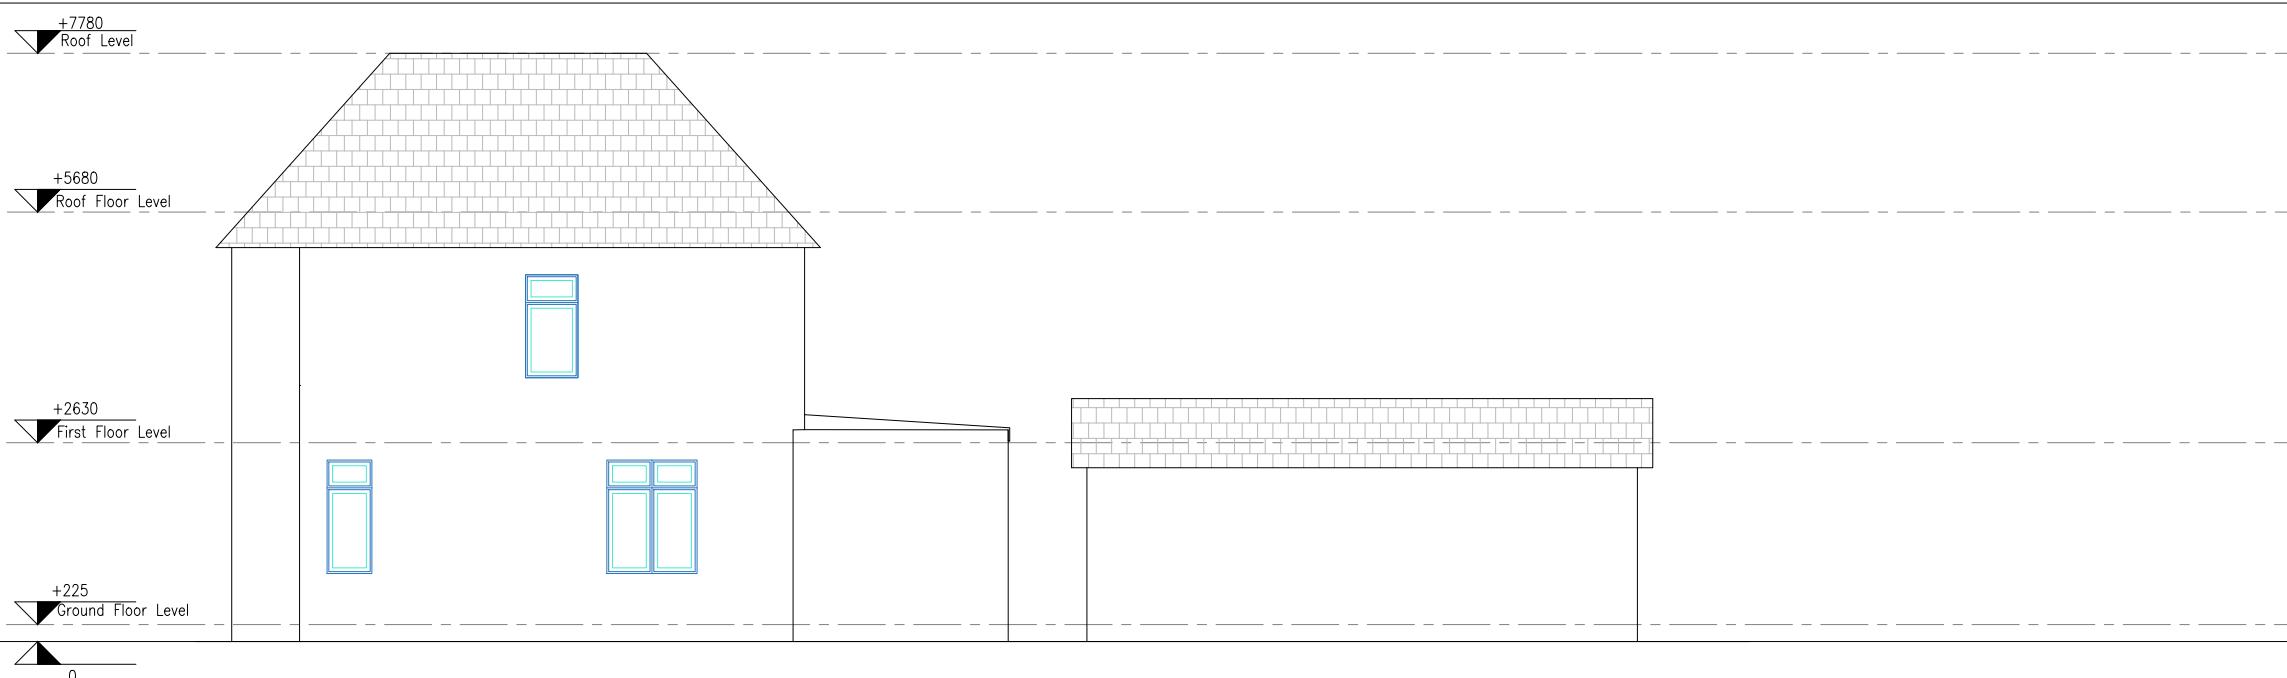

10 EXISTING SIDE ELEVATION
SCALE 1:100 @ A3



11 EXISTING SIDE ELEVATION
SCALE 1:100 @ A3

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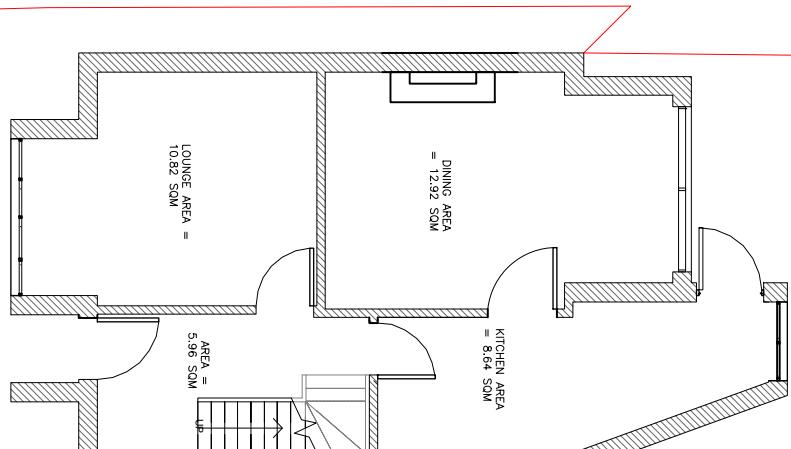
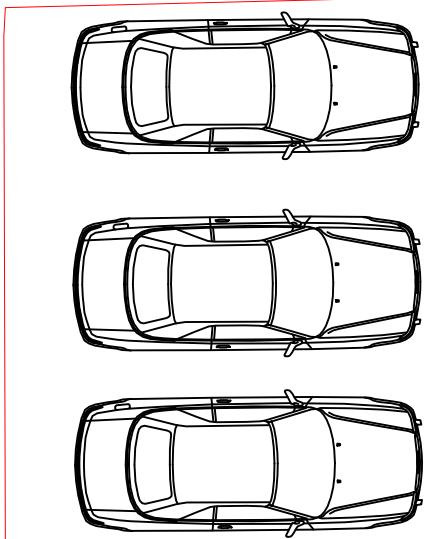


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Ealing House,
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Contact: 0207 459 4194
Email: support@statimbuild.com

Client:	Alan Rock
Project Title:	
Loft conversion	
Project Address:	44 Mount Pleasant, Ruislip HA4 9HG, UK
Client ID:	564452143

Drawing Title	Date: 19.08.2022
Existing elevations	
Scale	1:100
Drawn By: ZA	Checked By: DP
Approved By: AR	
Drawing No. SB22/AR/006	Revisions 01



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Existing Ground Floor Area (measured externally) = 49.72 sqm


12 PROPOSED GROUND FLOOR PLAN

SCALE 1:100 @ A3



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 33 Hanger Lane,
 London, W5 3HJ

Contact: 0207 459 4194
 Email: support@statimbuild.com

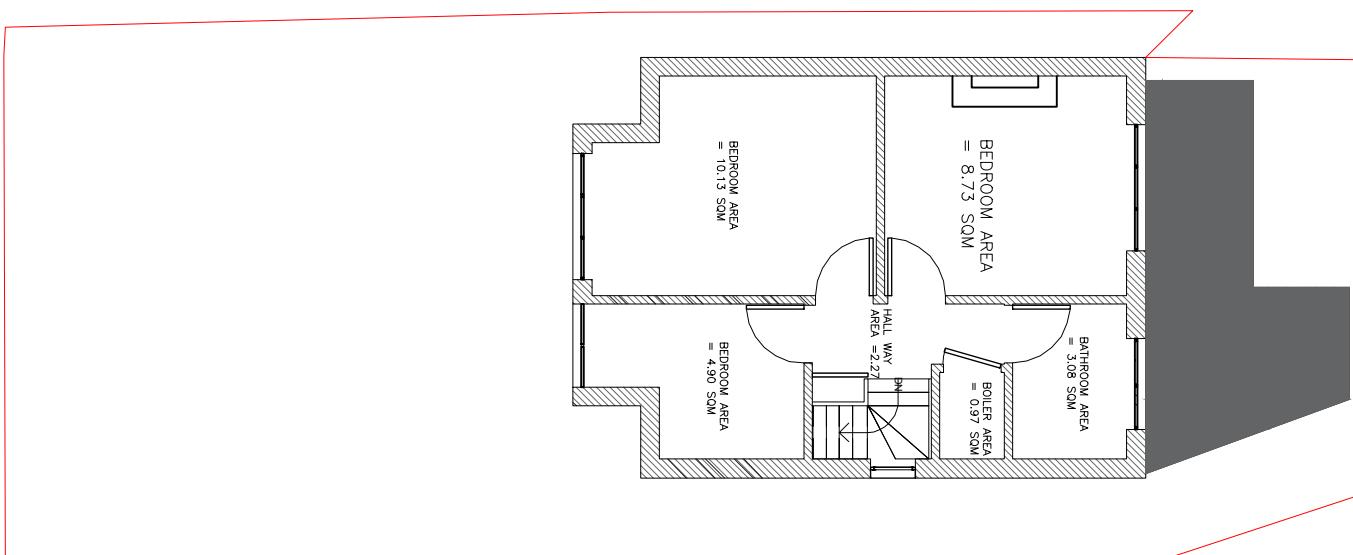

Existing First Floor Area (measured externally) = 40.51 sqm

13 PROPOSED FIRST FLOOR PLAN


SCALE 1:100 @ A3



- The materials used in any exterior work will be of a similar appearance to those used in the construction of the exterior of the existing dwelling house.
- The windows inserted on the wall or roof slope forming a side elevation of the dwelling house will be obscure-glazed, and non-opening unless the parts of the window which can be opened are more than 1.7 metres above the floor of the room in which the window is installed.
- The rooflights will not protrude more than 150mm beyond the plane of the slope of the original roof.

Client:	Alan Rock
Project Title:	Loft conversion
Project Address:	44 Mount Pleasant, Ruislip HA4 9HG, UK
Client ID:	564452143

Drawing Title	Date: 14.07.2022
Proposed Ground Floor Plan	
Scale	1:100
Drawn By: ZA	Checked By: DP
Approved By: AR	Revisions 01
Drawing No. SB22/AR/007	

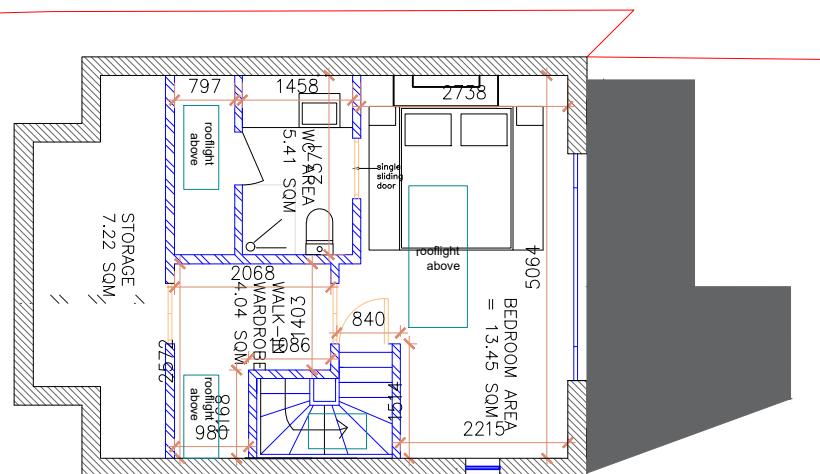

Existing Loft Floor Area (measured externally)= 40.51 sqm


14 PROPOSED LOFT PLAN

SCALE 1:100 @ A3

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London, W5 3HJ

Contact: 0207 459 4194
Email: support@statimbuild.com

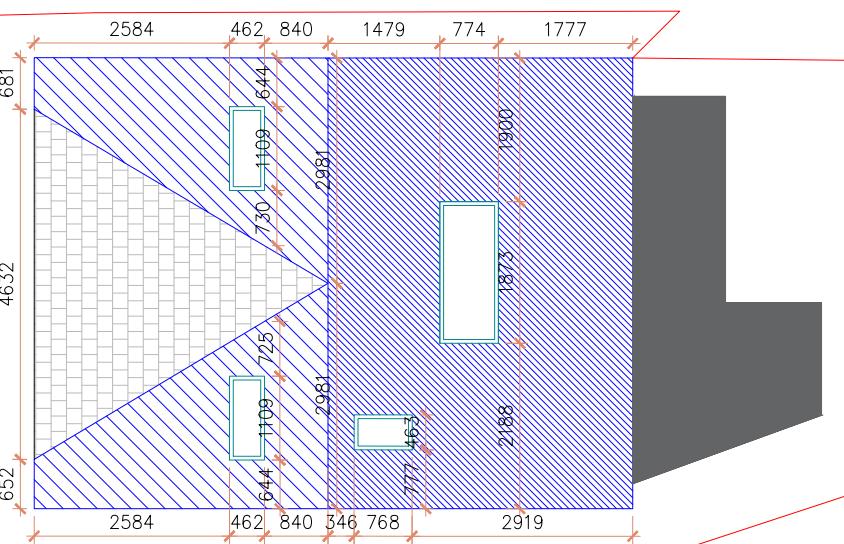

Proposed Loft Volume Area = 45.25 m³

15 PROPOSED ROOF PLAN

SCALE 1:100 @ A3



- The materials used in any exterior work will be of a similar appearance to those used in the construction of the exterior of the existing dwelling house.
- The windows inserted on the wall or roof slope forming a side elevation of the dwelling house will be obscure-glazed, and non-opening unless the parts of the window which can be opened are more than 1.7 metres above the floor of the room in which the window is installed.
- The rooflights will not protrude more than 150mm beyond the plane of the slope of the original roof.

General Notes:

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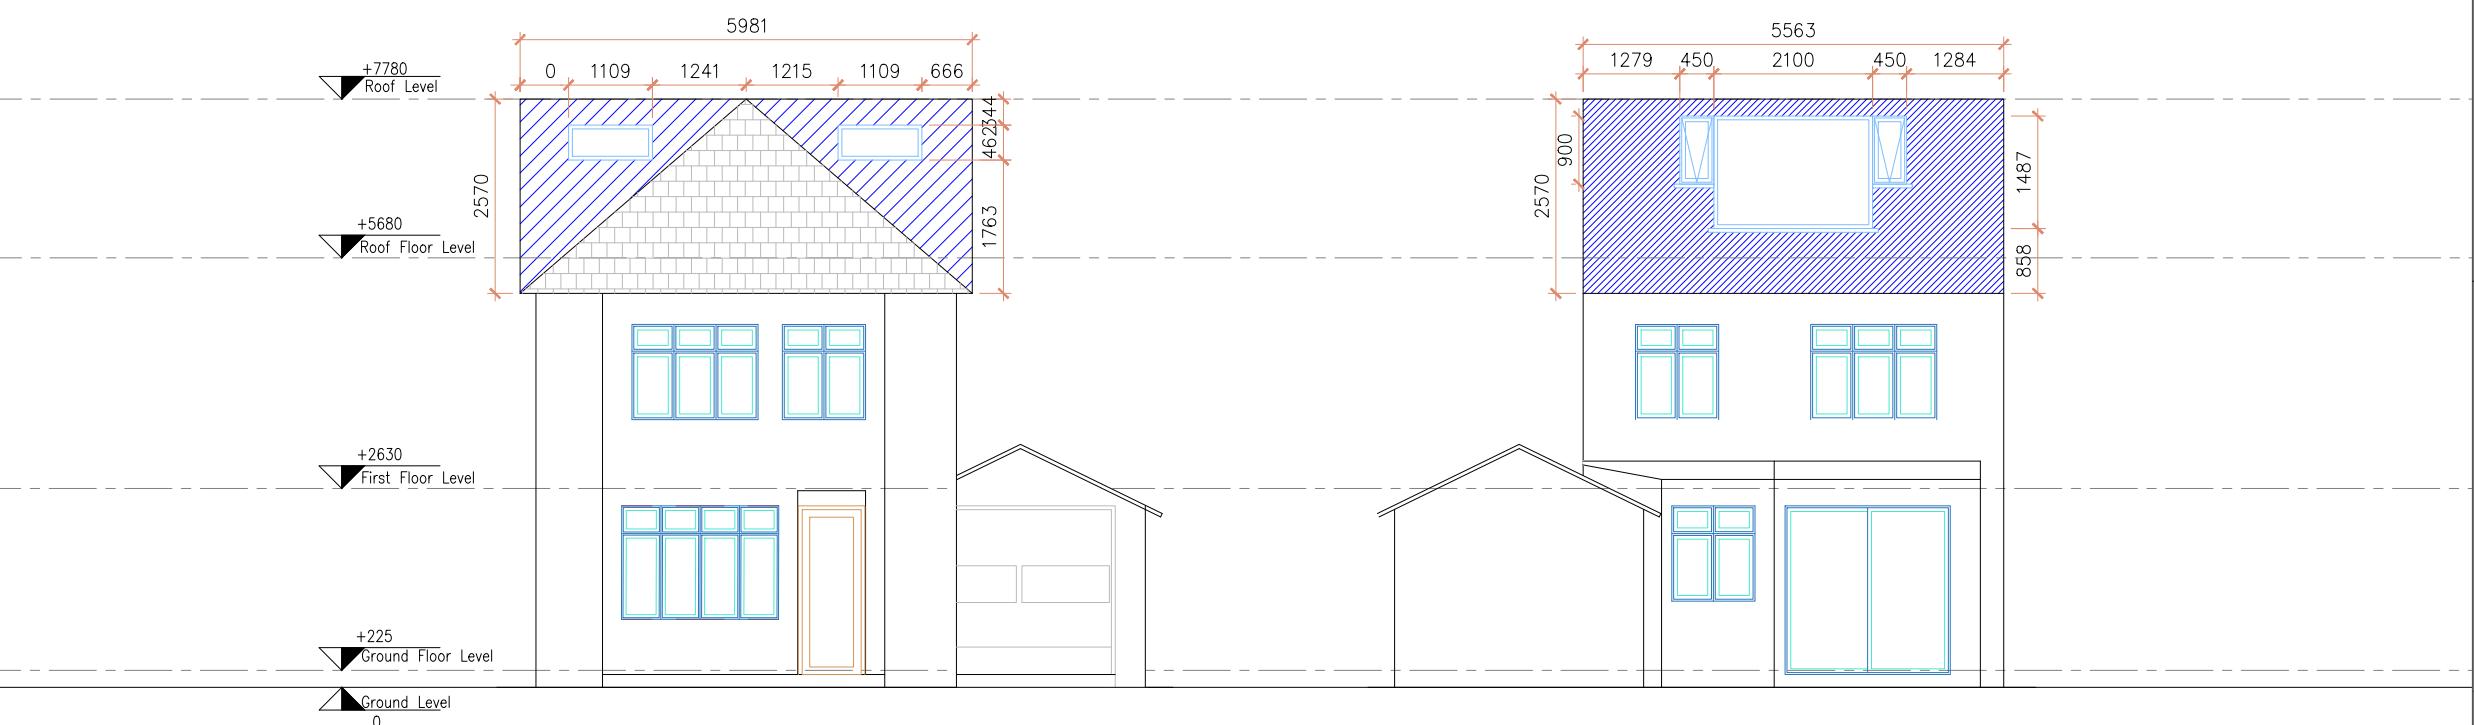
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Client: Alan Rock
Project Title: Loft conversion
Project Address: 44 Mount Pleasant, Ruislip HA4 9HG, UK
Client ID: 564452143

Drawing Title	Date: 14.07.2022	
Proposed Ground Floor Plan		
Scale	1:100	
Drawn By: ZA	Checked By: DP	Approved By: AR
Drawing No.	Revisions	
SB22/AR/008	01	

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16 PROPOSED FRONT ELEVATION

SCALE 1:100 @ A3

17 PROPOSED REAR ELEVATION

SCALE 1:100 @ A3



- The windows inserted on the wall or roof slope forming a side elevation of the dwelling house will be obscure-glazed, and non-opening unless the parts of the window which can be opened are more than 1.7 metres above the floor of the room in which the window is installed.
- The rooflights will not protrude more than 150mm beyond the plane of the slope of the original house
- The materials used in any exterior work will be of a similar appearance to those used in the construction of the exterior of the existing dwelling house.




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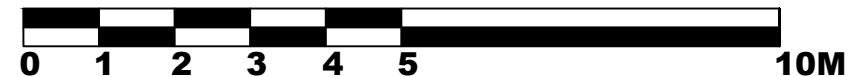
Contact: 0207 459 4194
 Email: support@statimbuild.com

Client:	Alan Rock
Project Title:	Loft conversion
Project Address:	44 Mount Pleasant, Ruislip HA4 9HG, UK
Client ID:	564452143

Drawing Title	Date: 19.08.2022
Proposed Front and Rear Elevations	
Scale	1:100
Drawn By: ZA	Checked By: HM
Approved By: AR	
Drawing No. SB22/AR/009	Revisions 01

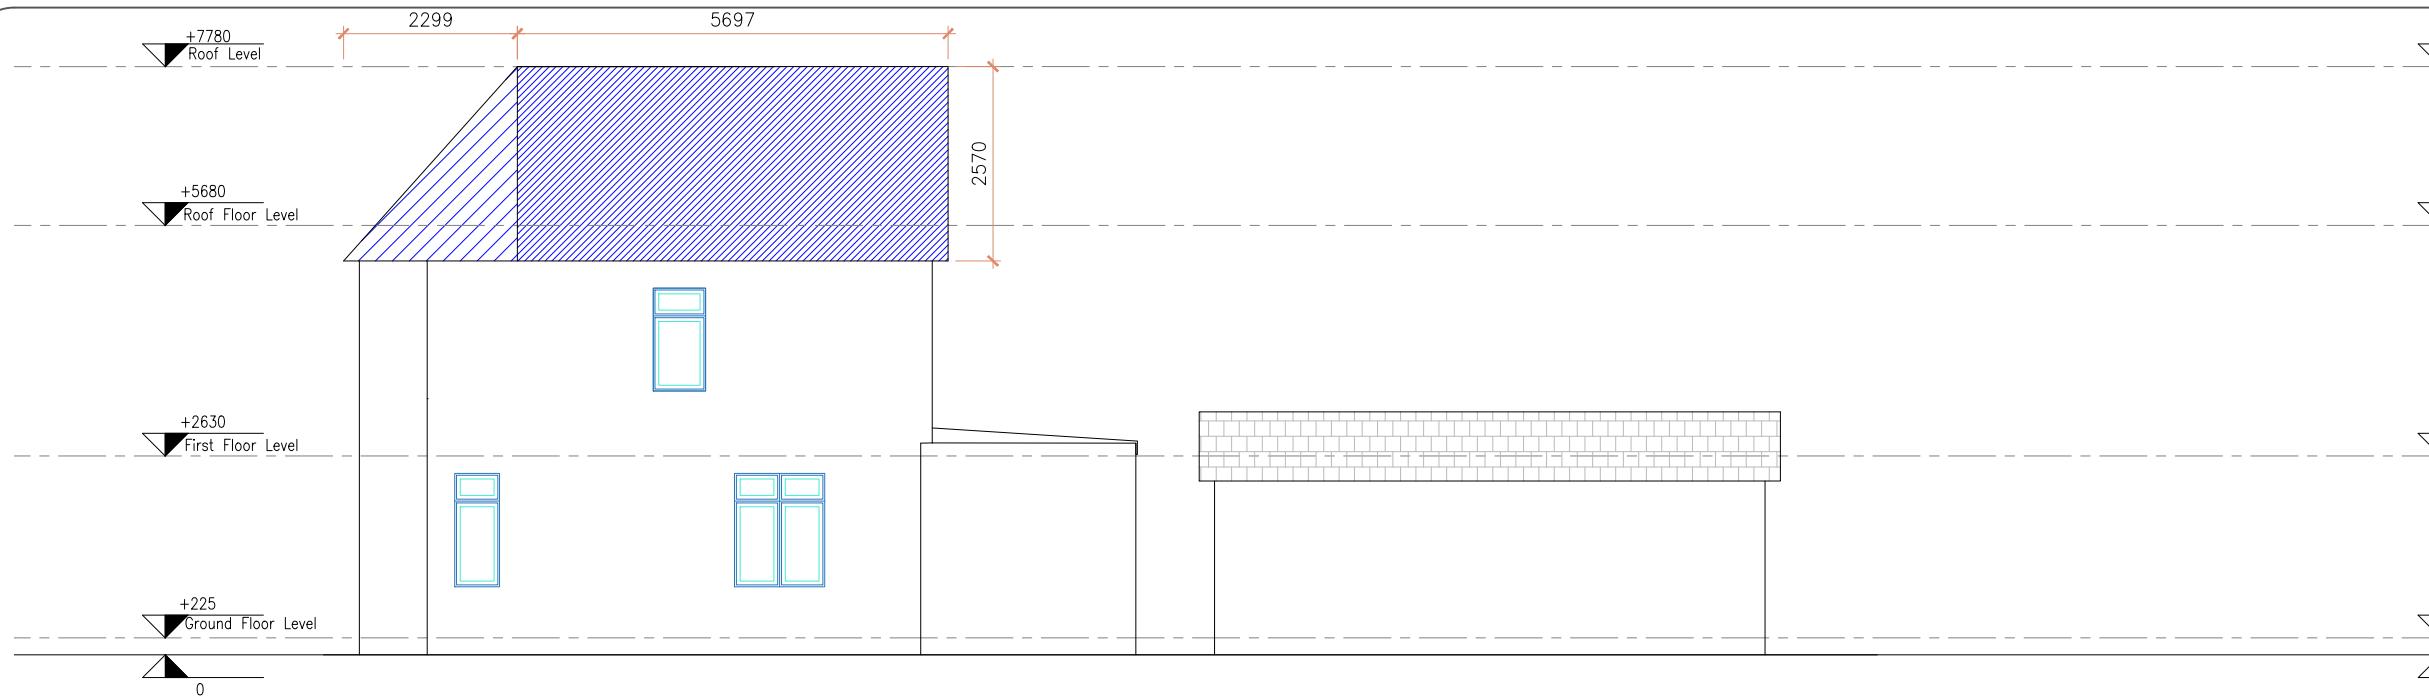


18 PROPOSED SIDE ELEVATION
SCALE 1:100 @ A3



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London, W5 3HJ

Contact: 0207 459 4194
Email: support@statimbuild.com

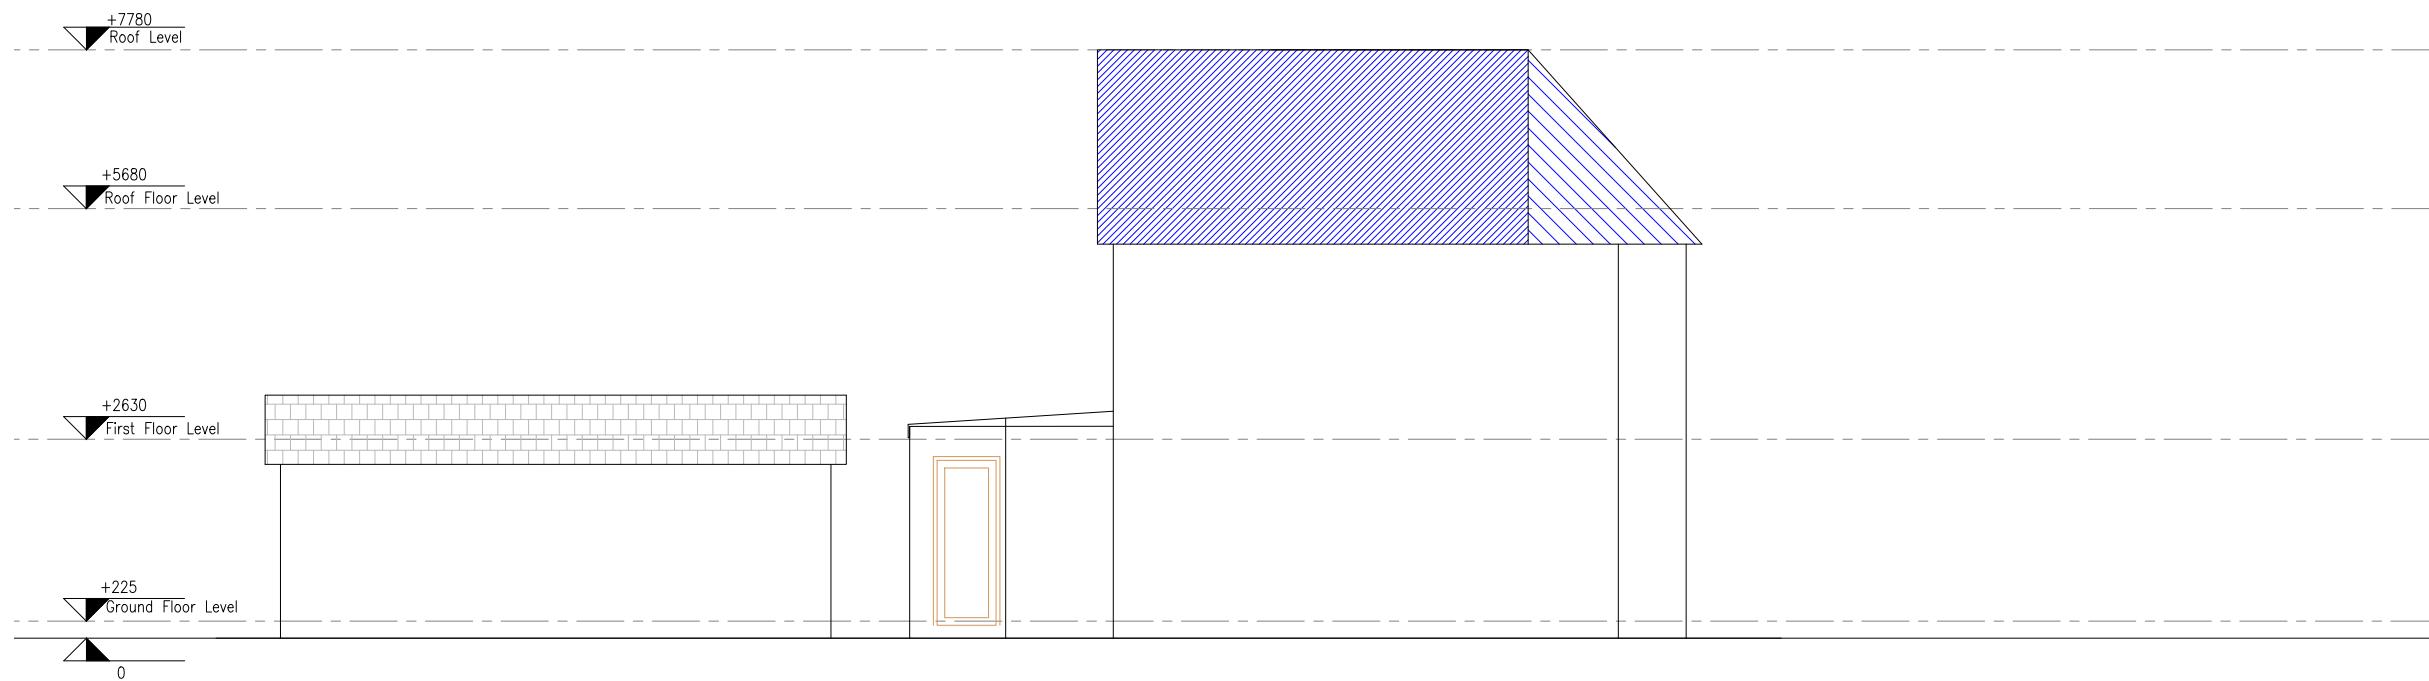

19 PROPOSED SIDE ELEVATION
SCALE 1:100 @ A3

The windows inserted on the wall or roof slope forming a side elevation of the dwelling house will be obscure-glazed, and non-opening unless the parts of the window which can be opened are more than 1.7 metres above the floor of the room in which the window is installed.

- The rooflights will not protrude more than 150mm beyond the plane of the slope of the original house.
- The materials used in any exterior work will be of a similar appearance to those used in the construction of the exterior of the existing dwelling house.

Client:		
Alan Rock		
Project Title:		
Loft conversion		
Project Address:		
44 Mount Pleasant, Ruislip HA4 9HG, UK		
Client ID:		
564452143		

Drawing Title	Date: 19.08.2022
Proposed Side Elevations	
Scale	1:100
Drawn By: DP	Checked By: ZA
Approved By: AR	
Drawing No. SB22/AR/011	Revisions 01