

Design Workshop

Dimensions to be verified on site
DO NOT SCALE FROM THIS DRAWING.
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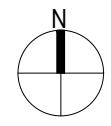
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Site Address:

58, Lynmouth Drive,
Ruislip
HA4 9BZ

Title:

Block & Location Plans



Scale: 1:500, 1:1250

Paper Size: A3

Rev Date Comments




Drawn By: VP

Job Ref: 20085D

Date: Sep 2020

Drawing No. LW - 04

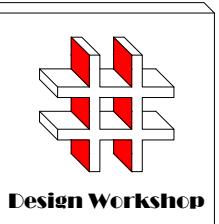

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Site Address:
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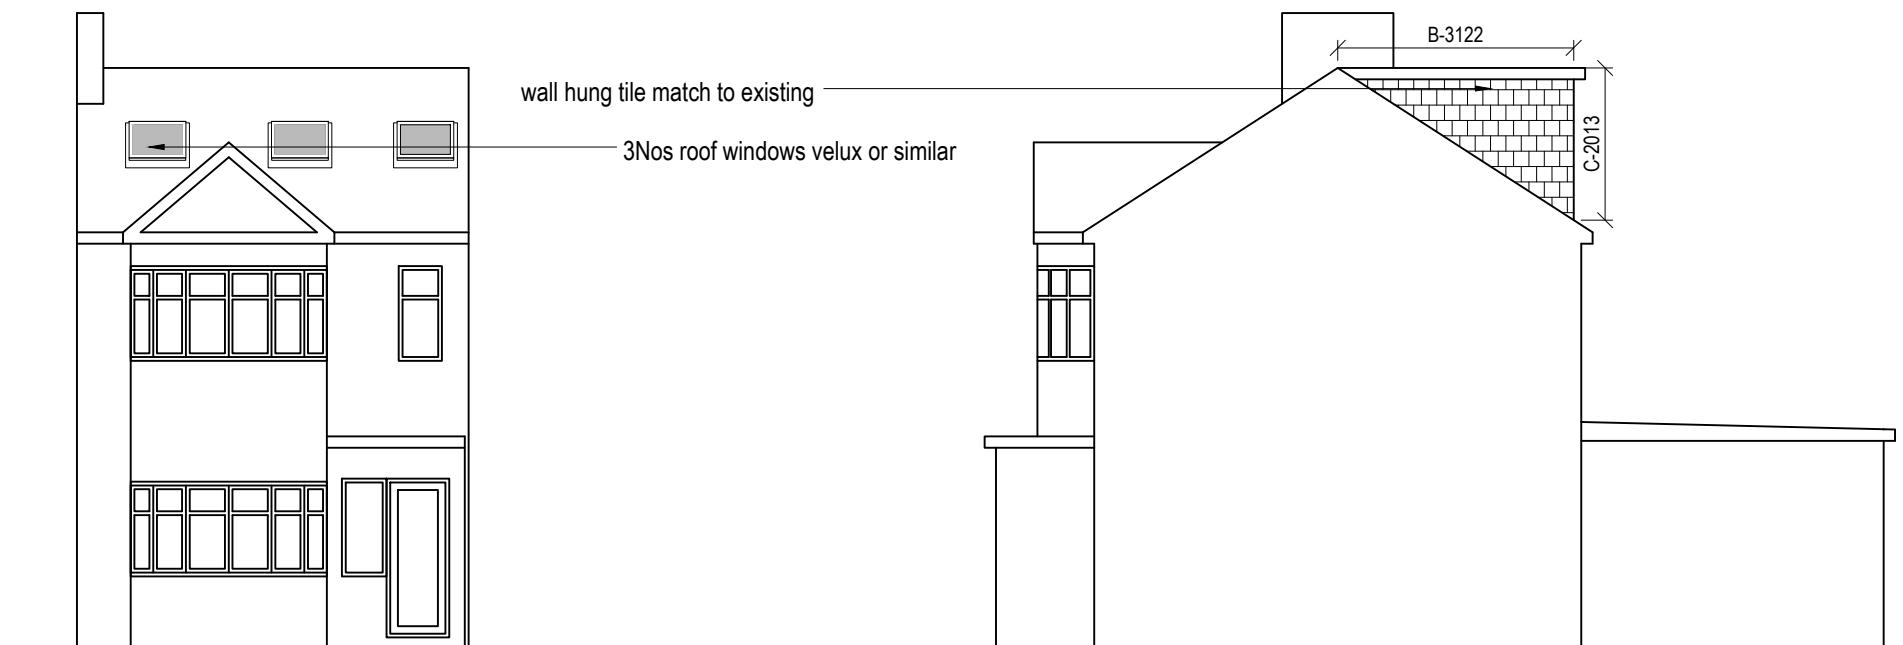
Title:
Proposed Elevations

Scale: 1:100
Paper Size: A3
Rev Date Comments

VOLUME CALCULATION :-

DORMER :-

$$A-4.70 \times B-3.12 \times C-2.01 \times \frac{1}{2} = 14.73 \text{ M3}$$




Proposed Front Elevation

0 1 2 3 4 5
metres 1:100 scale

Proposed Side Elevation

0 1 2 3 4 5
metres 1:100 scale

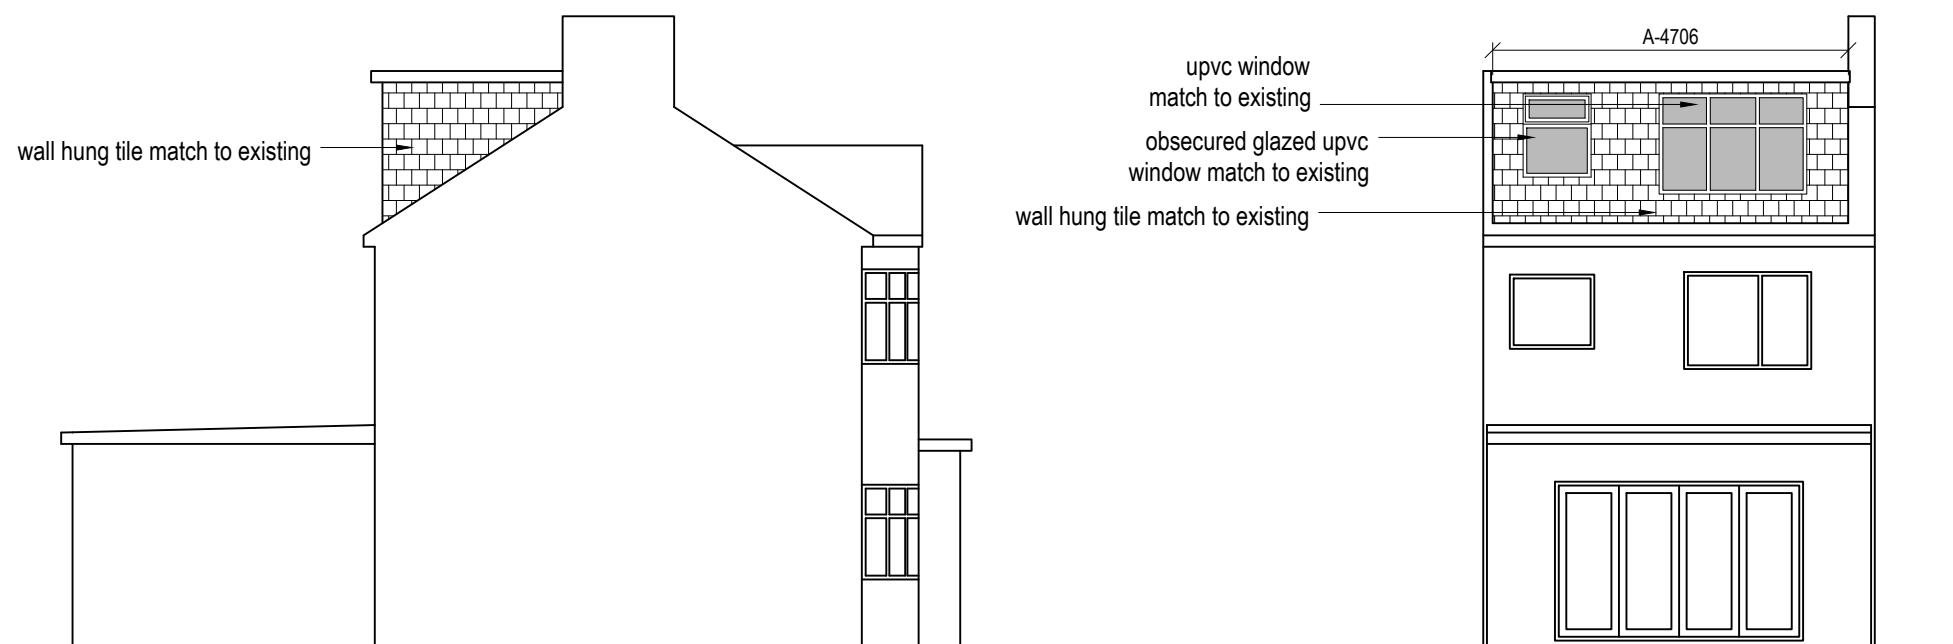

Proposed Side Elevation

0 1 2 3 4 5
metres 1:100 scale

Proposed Rear Elevation


0 1 2 3 4 5
metres 1:100 scale

NOTE:

ANY WINDOW INSERTED ON WALL OR ROOF SLOPE FORMING A SIDE ELEVATION OF THE DWELLING SHALL BE:

1. OBSECURE P GLAZED
2. NON- OPENING UNLESS THE PARTS OF THE WINDOW WHICH CAN BE OPENED ARE MORE THAN 1.7 METERS ABOVE THE FLOOR OF THE ROOM IN WHICH THE WINDOW IS INSTALLED.
3. ROOF WINDOWS WILL NOT PROTRUDE MORE THAN 150MM

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Drawing No. LW - 03

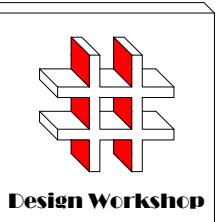

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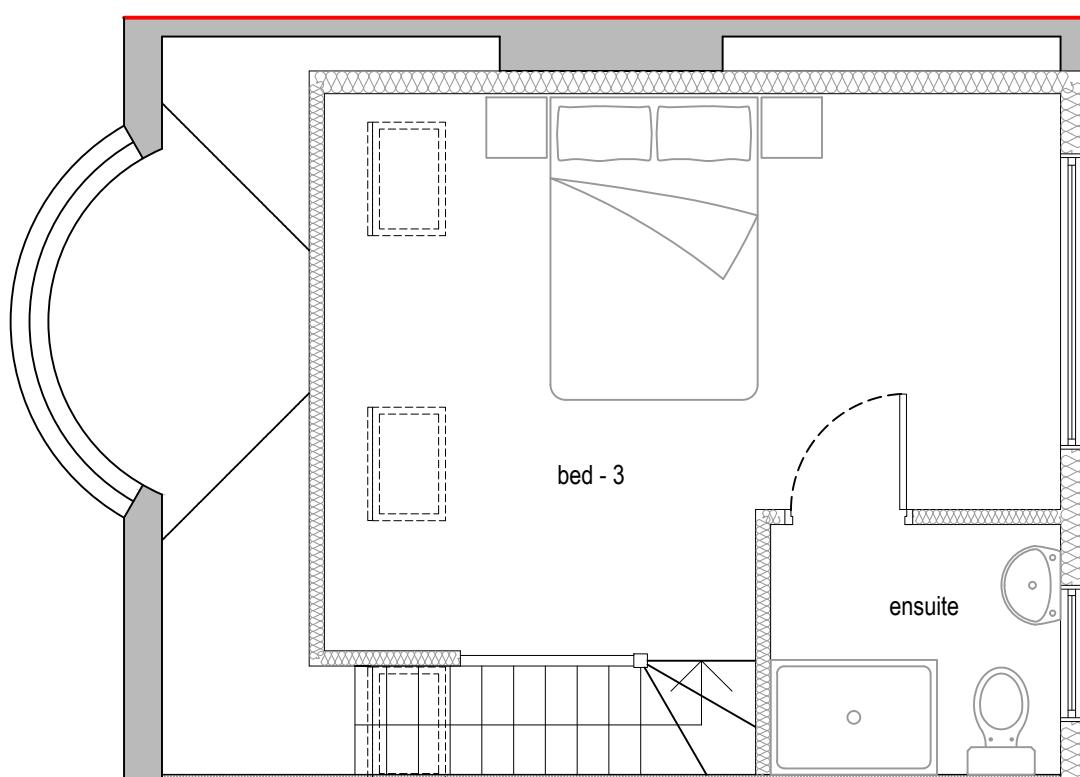
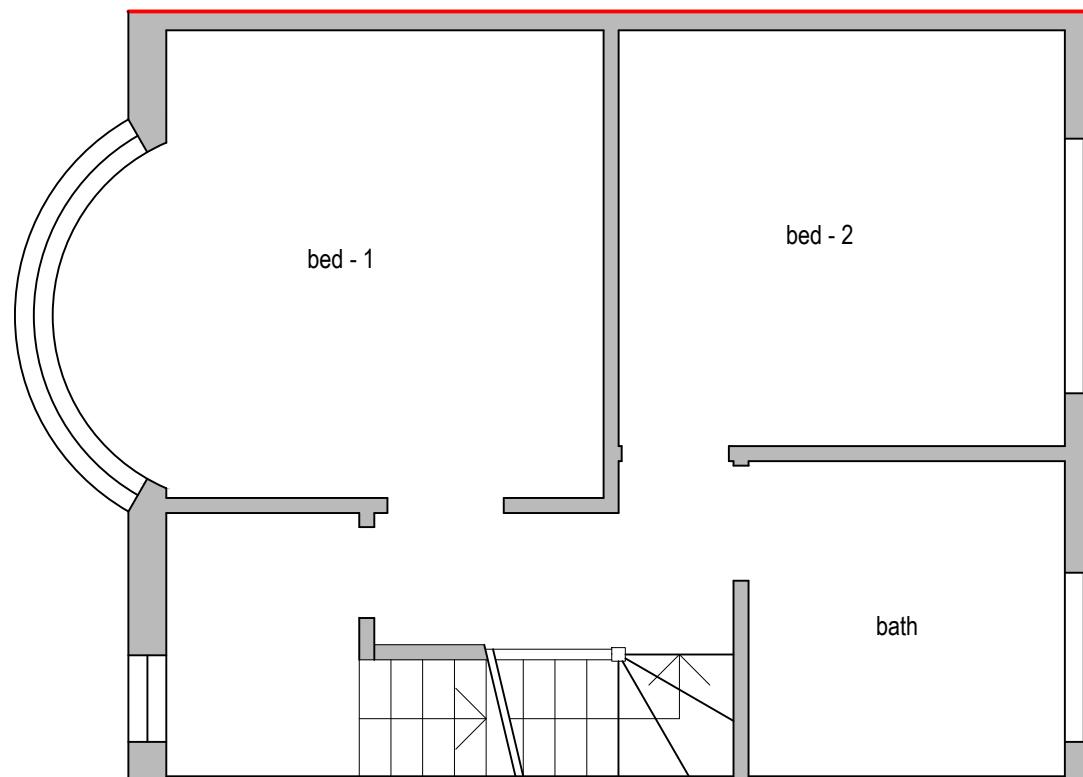
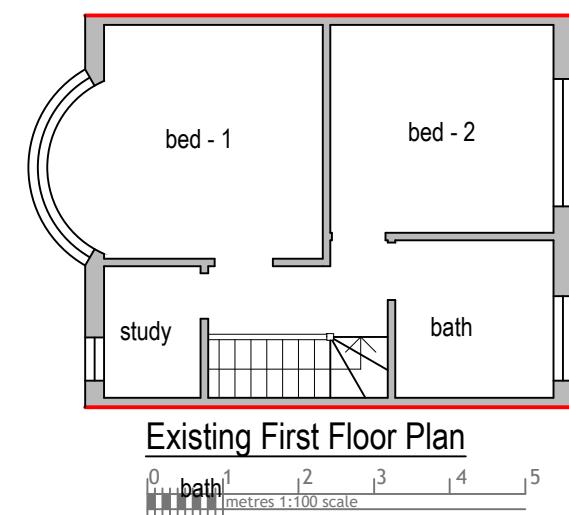
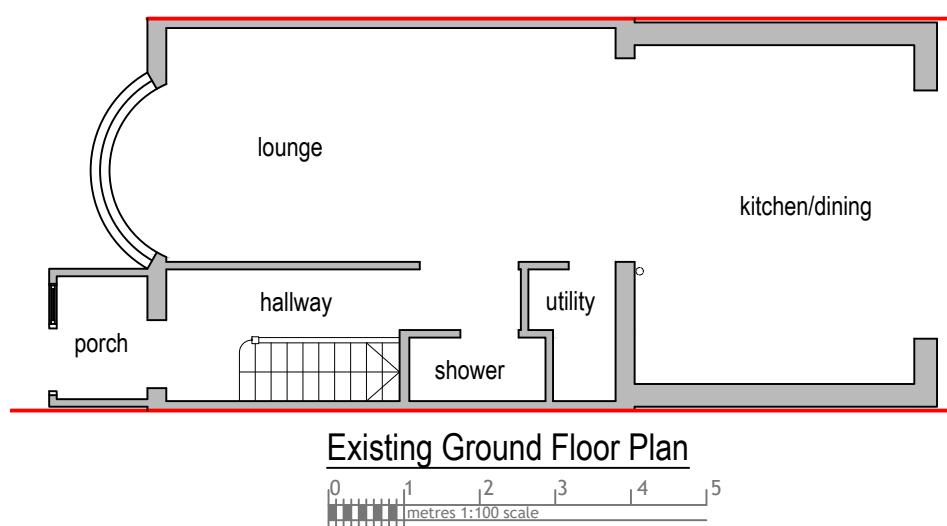
Title:

Existing & Proposed First Floor
Proposed Loft Plans


Scale: 1:50, 1:100

Paper Size: A3

Rev Date Comments



Drawn By: VP
Job Ref: 20085D
Date: Sep 2020
Drawing No. LW - 02

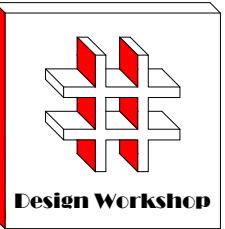

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Title:

Existing Elevations

Scale: 1:100


Paper Size: A3

Rev Date Comments




Existing Front Elevation

0 1 2 3 4 5
metres 1:100 scale

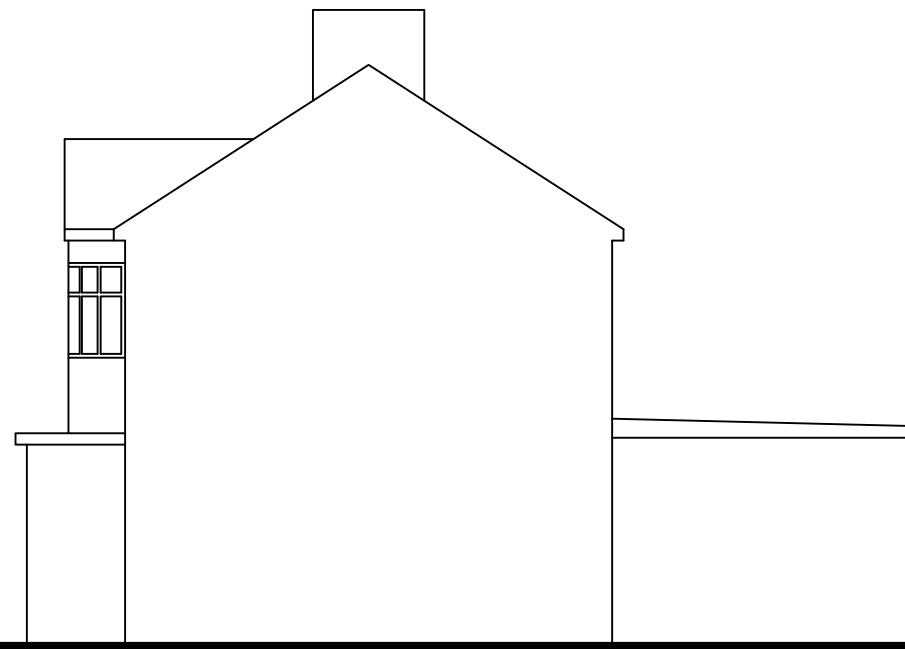


Existing Side Elevation

0 1 2 3 4 5
metres 1:100 scale

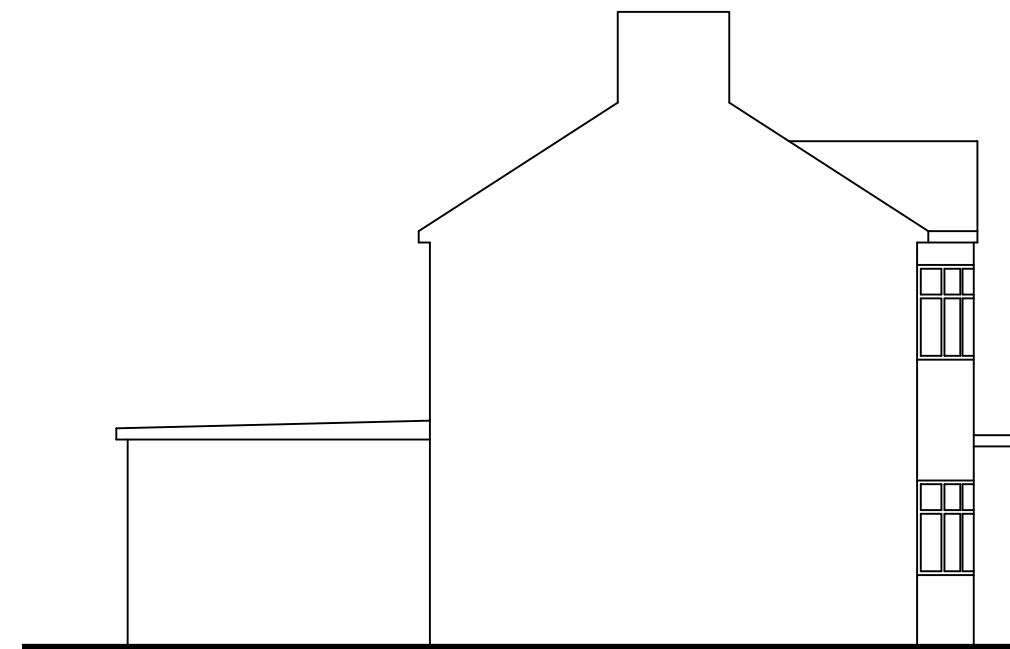

Existing Side Elevation

0 1 2 3 4 5
metres 1:100 scale

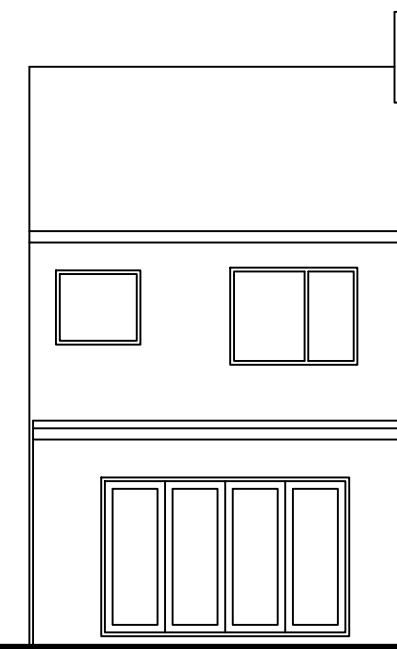

Existing Rear Elevation

0 1 2 3 4 5
metres 1:100 scale

Drawn By: VP
Job Ref: 20085D
Date: Sep 2020
Drawing No. LW - 01