


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Site Address:

58, Lynmonth Drive,  
Ruislip  
HA4 9BZ

Title:

## Block & Location Plans

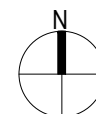

Scale: 1:500, 1:1250


Paper Size: A3

Rev	Date	Comments
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Drawn By:	VP
Job Ref:	20085D
Date:	Sep 2020
Drawing No.	LW - 04




## Block Plan

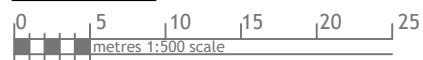

## Site Location



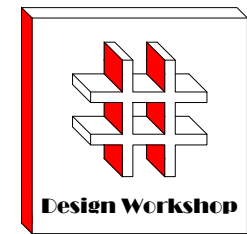

Dimensions to be verified on site  
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Site Address:

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HA4 9BZ

Title:

Proposed Elevations

Scale: 1:100

Paper Size: A3

Rev	Date	Comments
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Drawn By:	VP
Job Ref:	20085D
Date:	Sep 2020
Drawing No.	LW - 03

VOLUME CALCUATION :-


DORMER :-

$A-4.70 \times B-3.12 \times C-2.01 \times \frac{1}{2} = 14.73 \text{ M3}$


NOTE:

ANY WINDOW INSERTED ON WALL OR ROOF SLOPE FORMING A SIDE ELEVATION OF THE DWELLING SHALL BE:


- OBSECURE P GLAZED
- NON- OPENING UNLESS THE PARTS OF THE WINDOW WHICH CAN BE OPENED ARE MORE THAN 1.7 METERS ABOVE THE FLOOR OF THE ROOM IN WHICH THE WINDOW IS INSTALLED.
- ROOF WINDOWS WILL NOT PROTRUDE MORE THAN 150MM

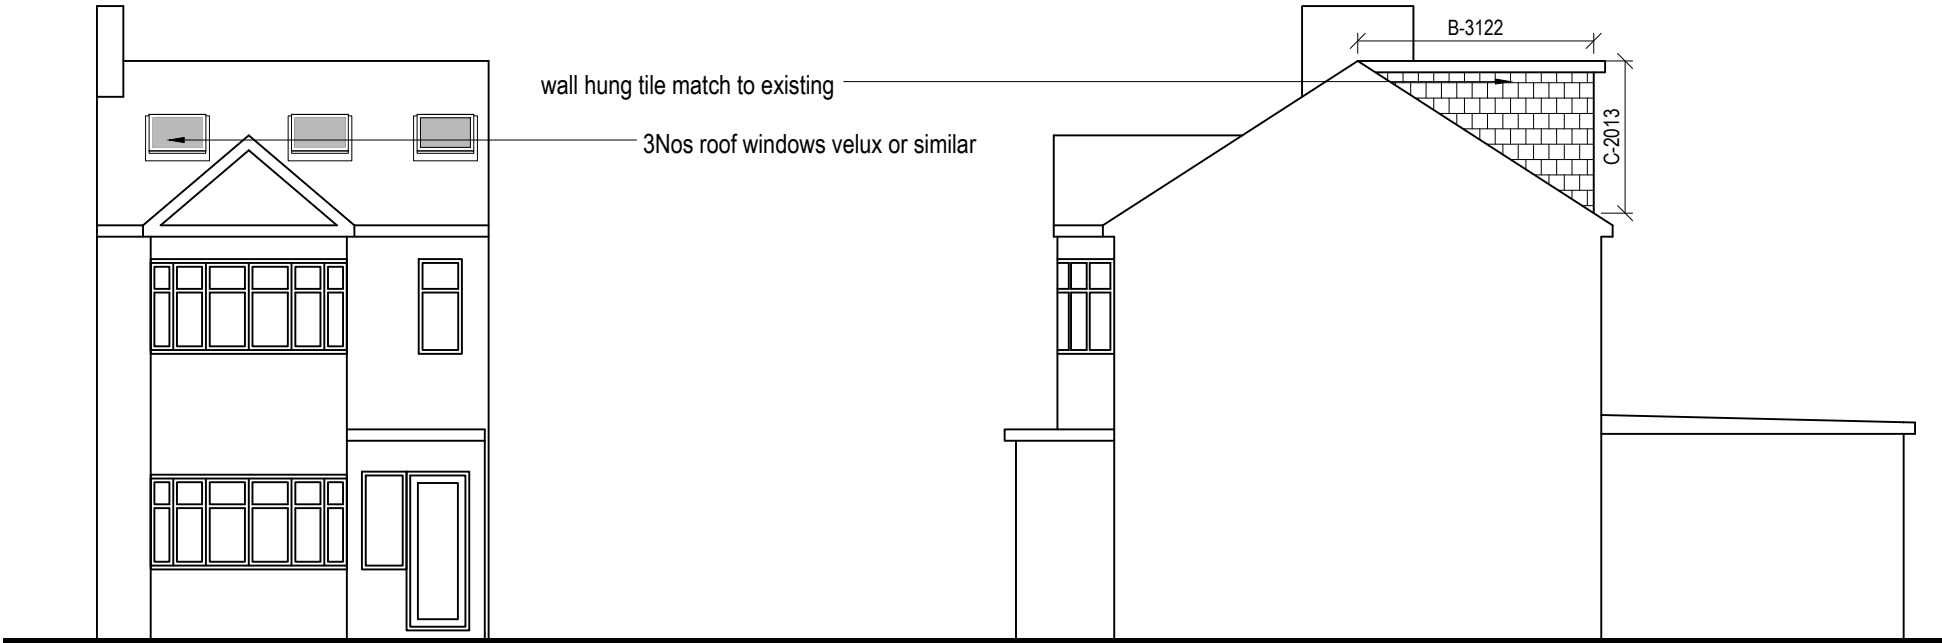


Proposed Front Elevation

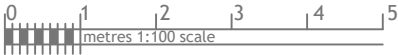

Proposed Side Elevation

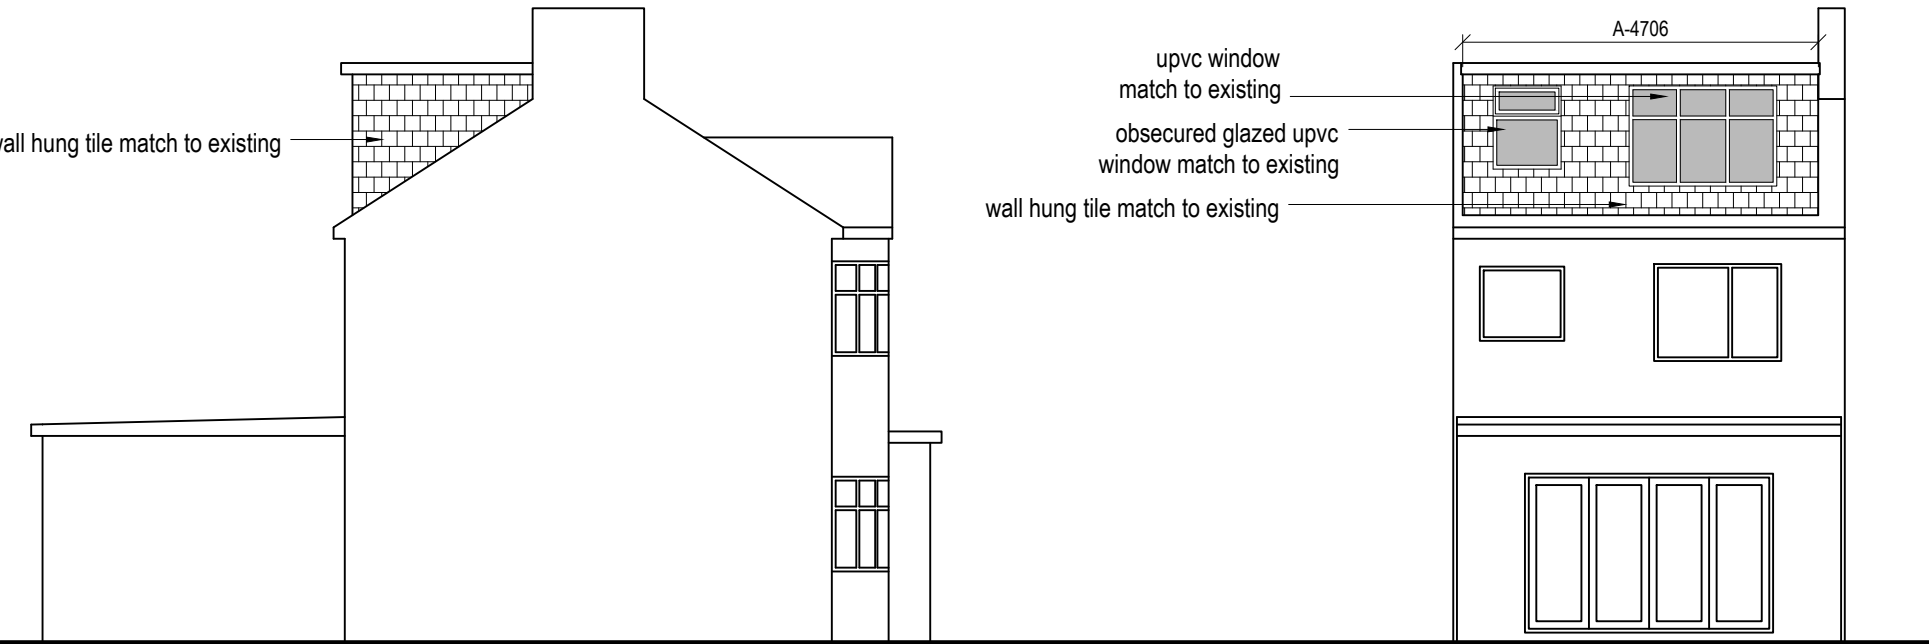


Proposed Side Elevation


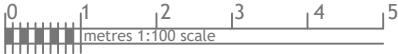


Proposed Rear Elevation




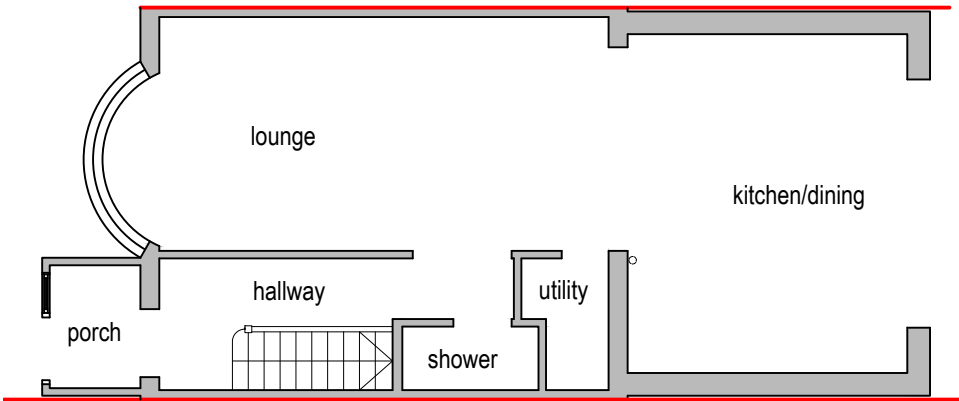


Existing Ground Floor Plan

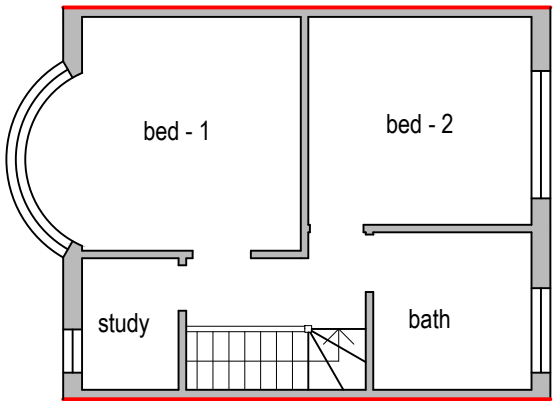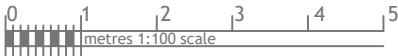


Existing First Floor Plan

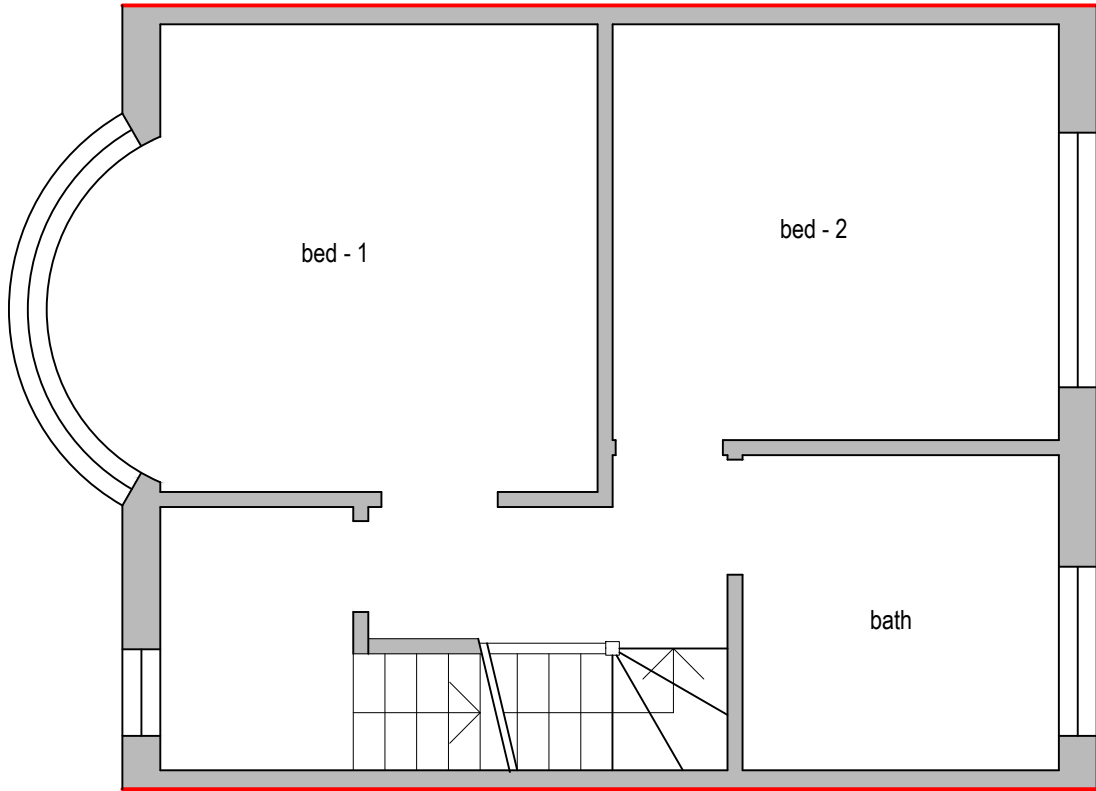

Proposed First Floor Plan

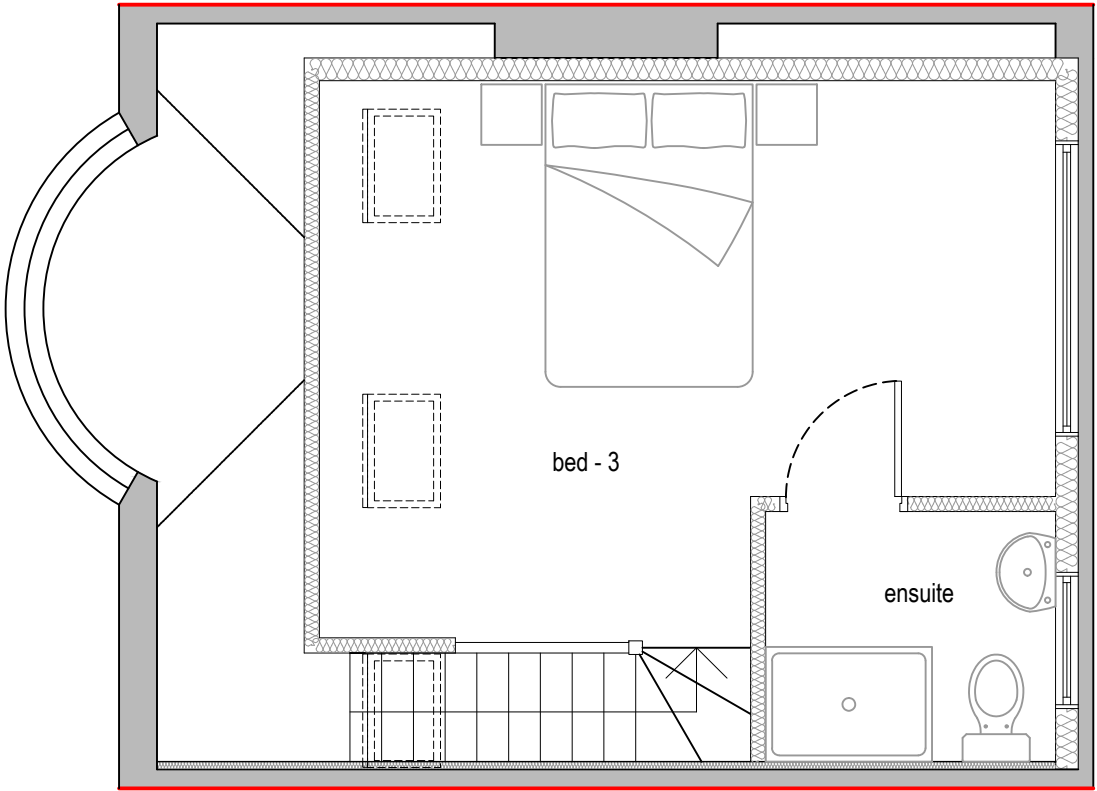

Proposed Loft Plan

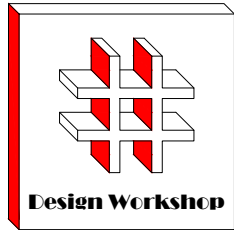

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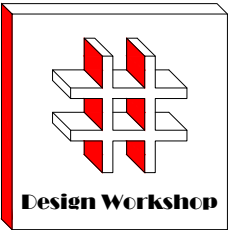
Existing & Proposed First Floor  
Proposed Loft Plans

Scale: 1:50, 1:100

Paper Size: A3

Rev Date Comments

Drawn By: VP  
Job Ref: 20085D  
Date: Sep 2020  
Drawing No. LW - 02



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Title:


Existing Elevations

Scale: 1:100


Paper Size: A3

Rev	Date	Comments
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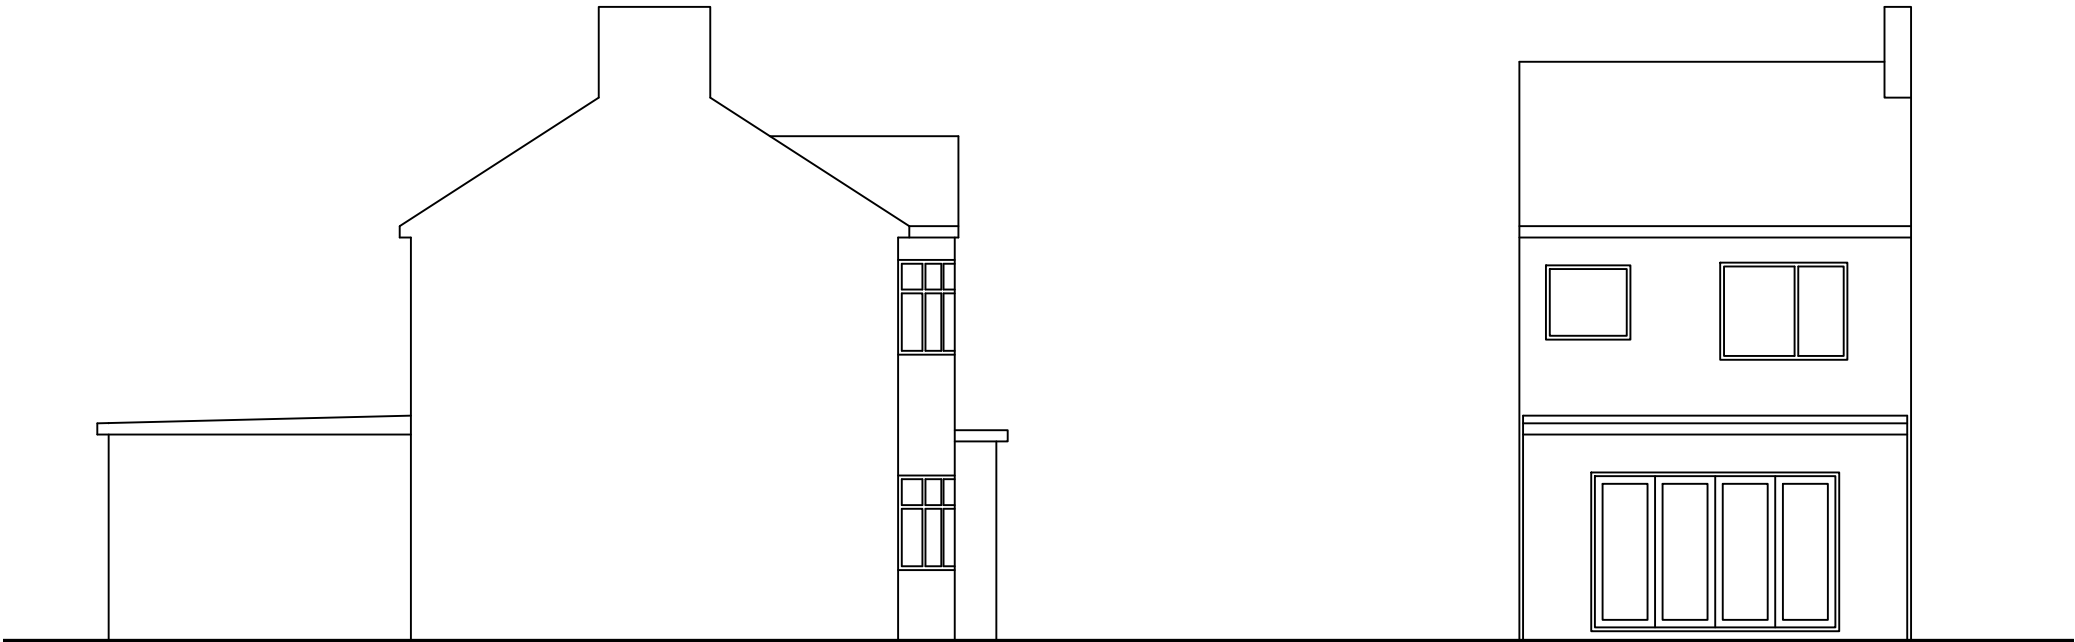
Drawn By:	VP
Job Ref:	20085D
Date:	Sep 2020
Drawing No.	LW - 01

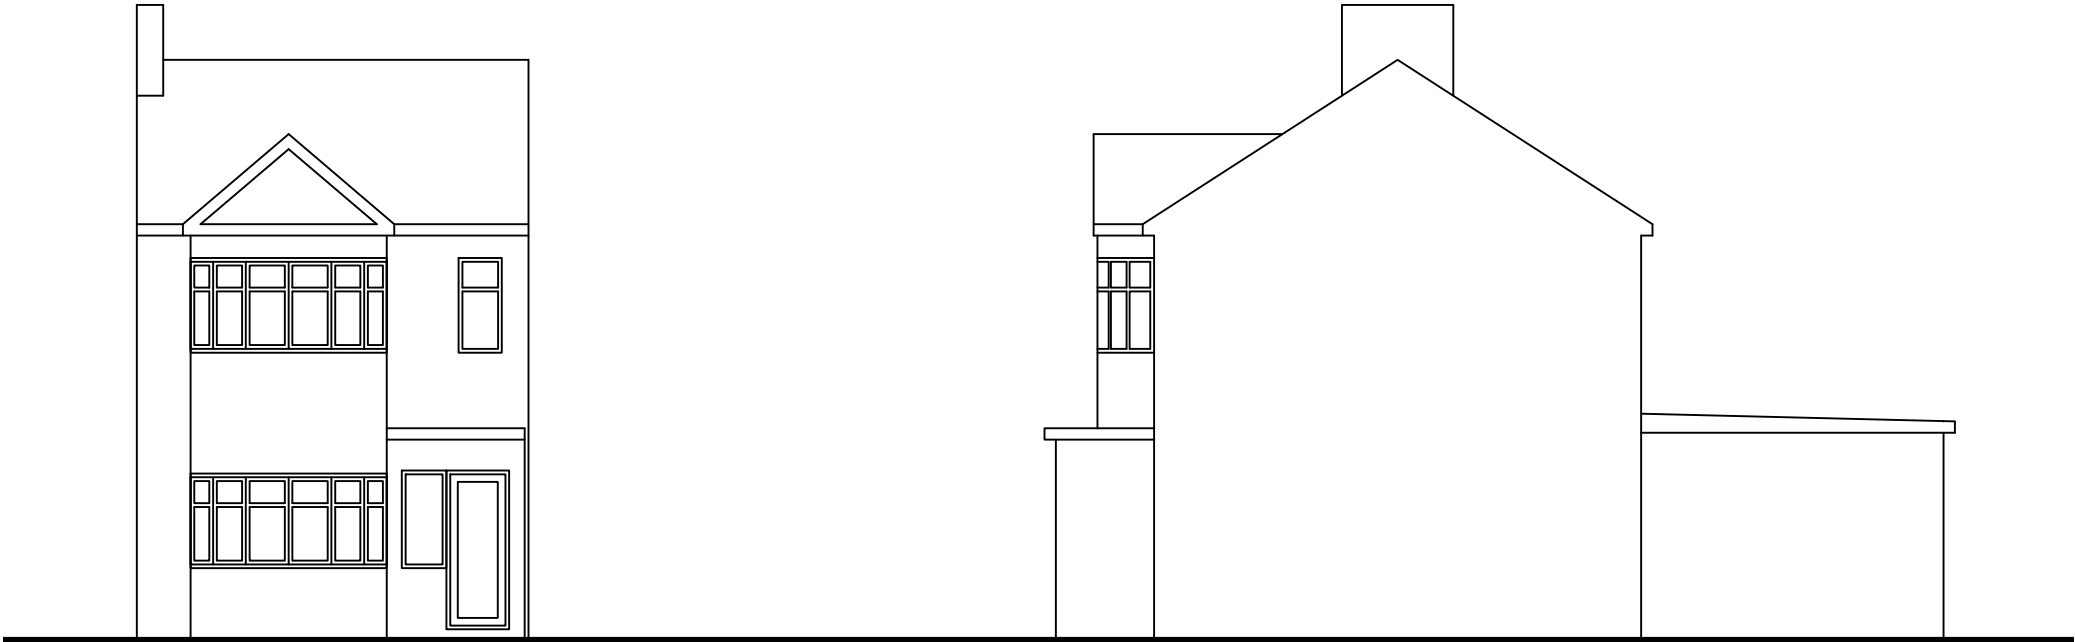

Existing Front Elevation

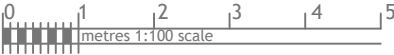

Existing Side Elevation



Existing Side Elevation



Existing Rear Elevation

