

- NOTES:**
1. THIS DRAWING IS NOT APPROVED FOR CONSTRUCTION.
 2. PRIOR TO COMMENCEMENT OF WORK, DRAWINGS TO BE SIGNED OFF BY BUILDING CONTROL INSPECTOR.
 2. PARTY WALL (ETC) ACT 1997 TO BE AGREED WITH ADJOINING NEIGHBORS PRIOR TO CONSTRUCTION.
 3. ALL MEASUREMENTS TO BE CHECKED ON SITE & NOT BE SCALED FROM THIS DRAWING.
 4. ALL WORKS TO MEET LOCAL AUTHORITY'S SET STANDARDS.

Comments
The General contractor is responsible for the verification of all dimensions on site and shall inform the contract administrator of any discrepancies.

Do not scale from this drawing. Use figure dimension only.

All furniture shown in drawings is for illustration purposes only.

Existing foundations, lintels and wall to be exposed if required by Building Control for assessment and upgrading if found inadequate.

Fire Precautions:
All doors marked with FD30 to be to current British Standards.
All new fire doors to be fitted with 3x4" steel butt hinges or 3x30min fire rated hinges, with appropriate CE and BS EN stamps on each hinge if using brass or chrome.

Self contained mains operated interlinked smoke alarms (BS 5446) and fitted with battery backup to be provided to all landings and hall ceiling shown as (SD).

Staircases:
Actual size of riser & tread for the proposed staircase, to be confirmed on site prior to installation by staircase specialist to avoid any issues with headroom/pitch.

PRELIMINARY DESIGN
PLEASE PRINT, SIGN AND DATE TO APPROVE DRAWINGS FOR CLIENT/S.

SIGNATURE.....
PRINT NAME
DATE


REVISIONS:	
DATE	DESCRIPTION

PROJECT DESCRIPTION:
PROPOSAL FOR CHANGES TO ROOF FOR CONVERSION OF LOFT INTO HABITABLE SPACE WITH ADDITION OF REAR DORMER AND VELUX. INTERNAL ALTERATIONS TO ALREADY APPROVED EXTENSIONS


PROJECT DETAILS:
P SINGH

48 HUGHES ROAD
HAYES
UB3 3AP


DRAWING NO.:	48HR/19122024/REV-D-3/3
DATE:	19 DECEMBER 2024
SCALE:	1:200 & 1:1250 @A1
DRAWN BY:	sc
CHECKED BY:	

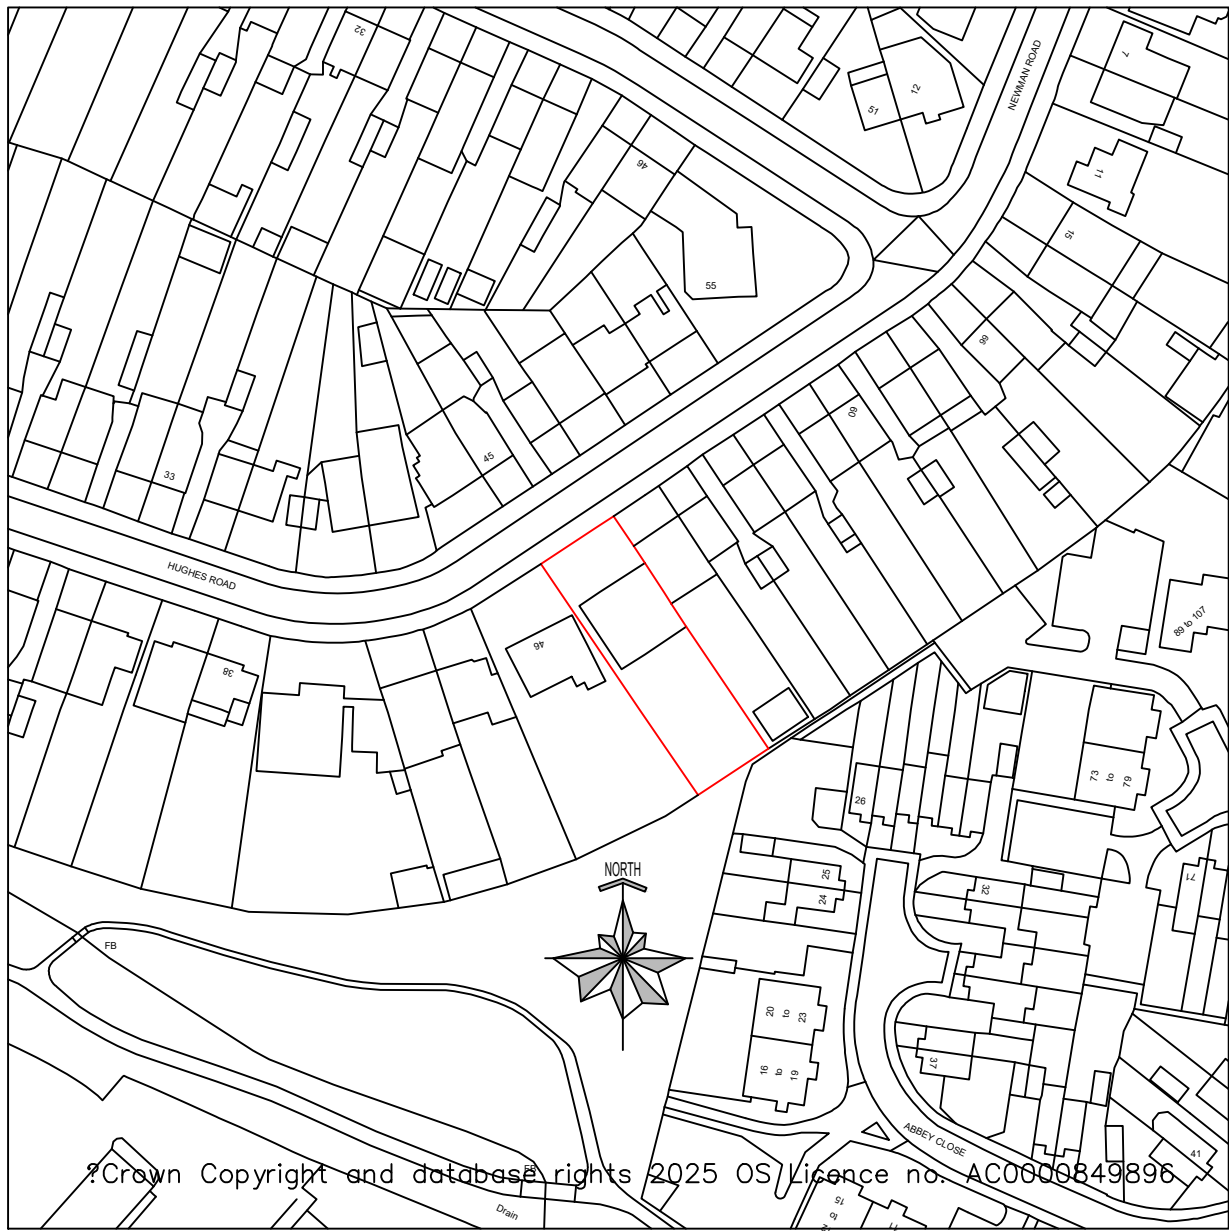

LOCATION PLAN
SCALE 1:1250@A1

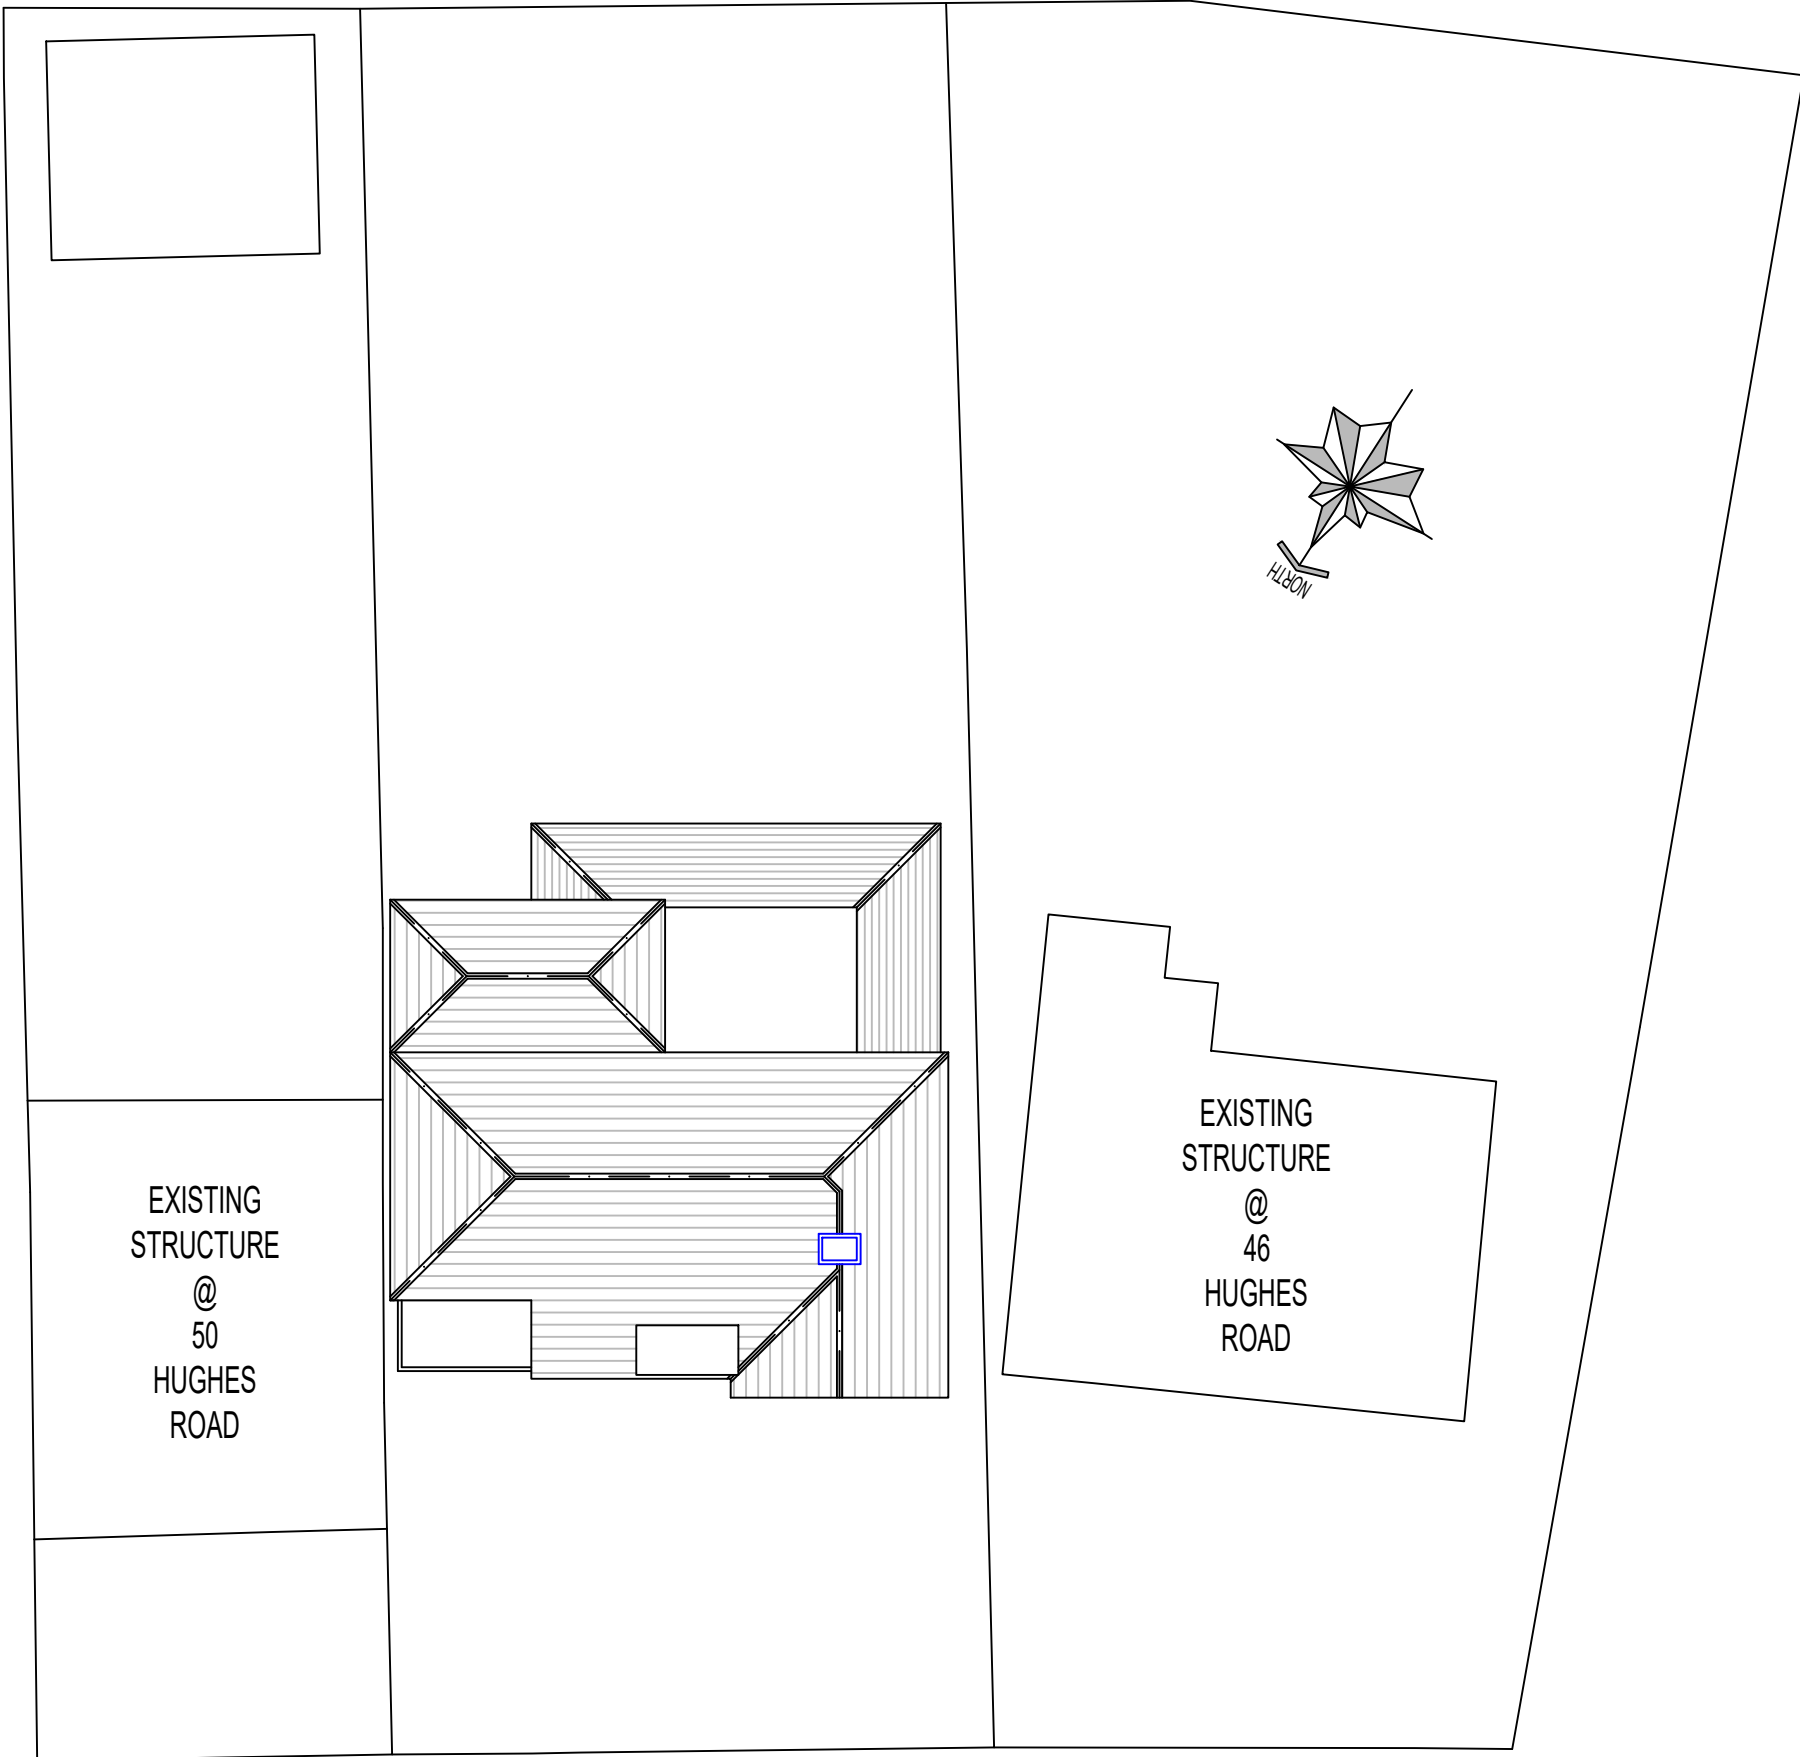

HUGHES ROAD
APPROVED SITE PLAN
SCALE 1:200@A1

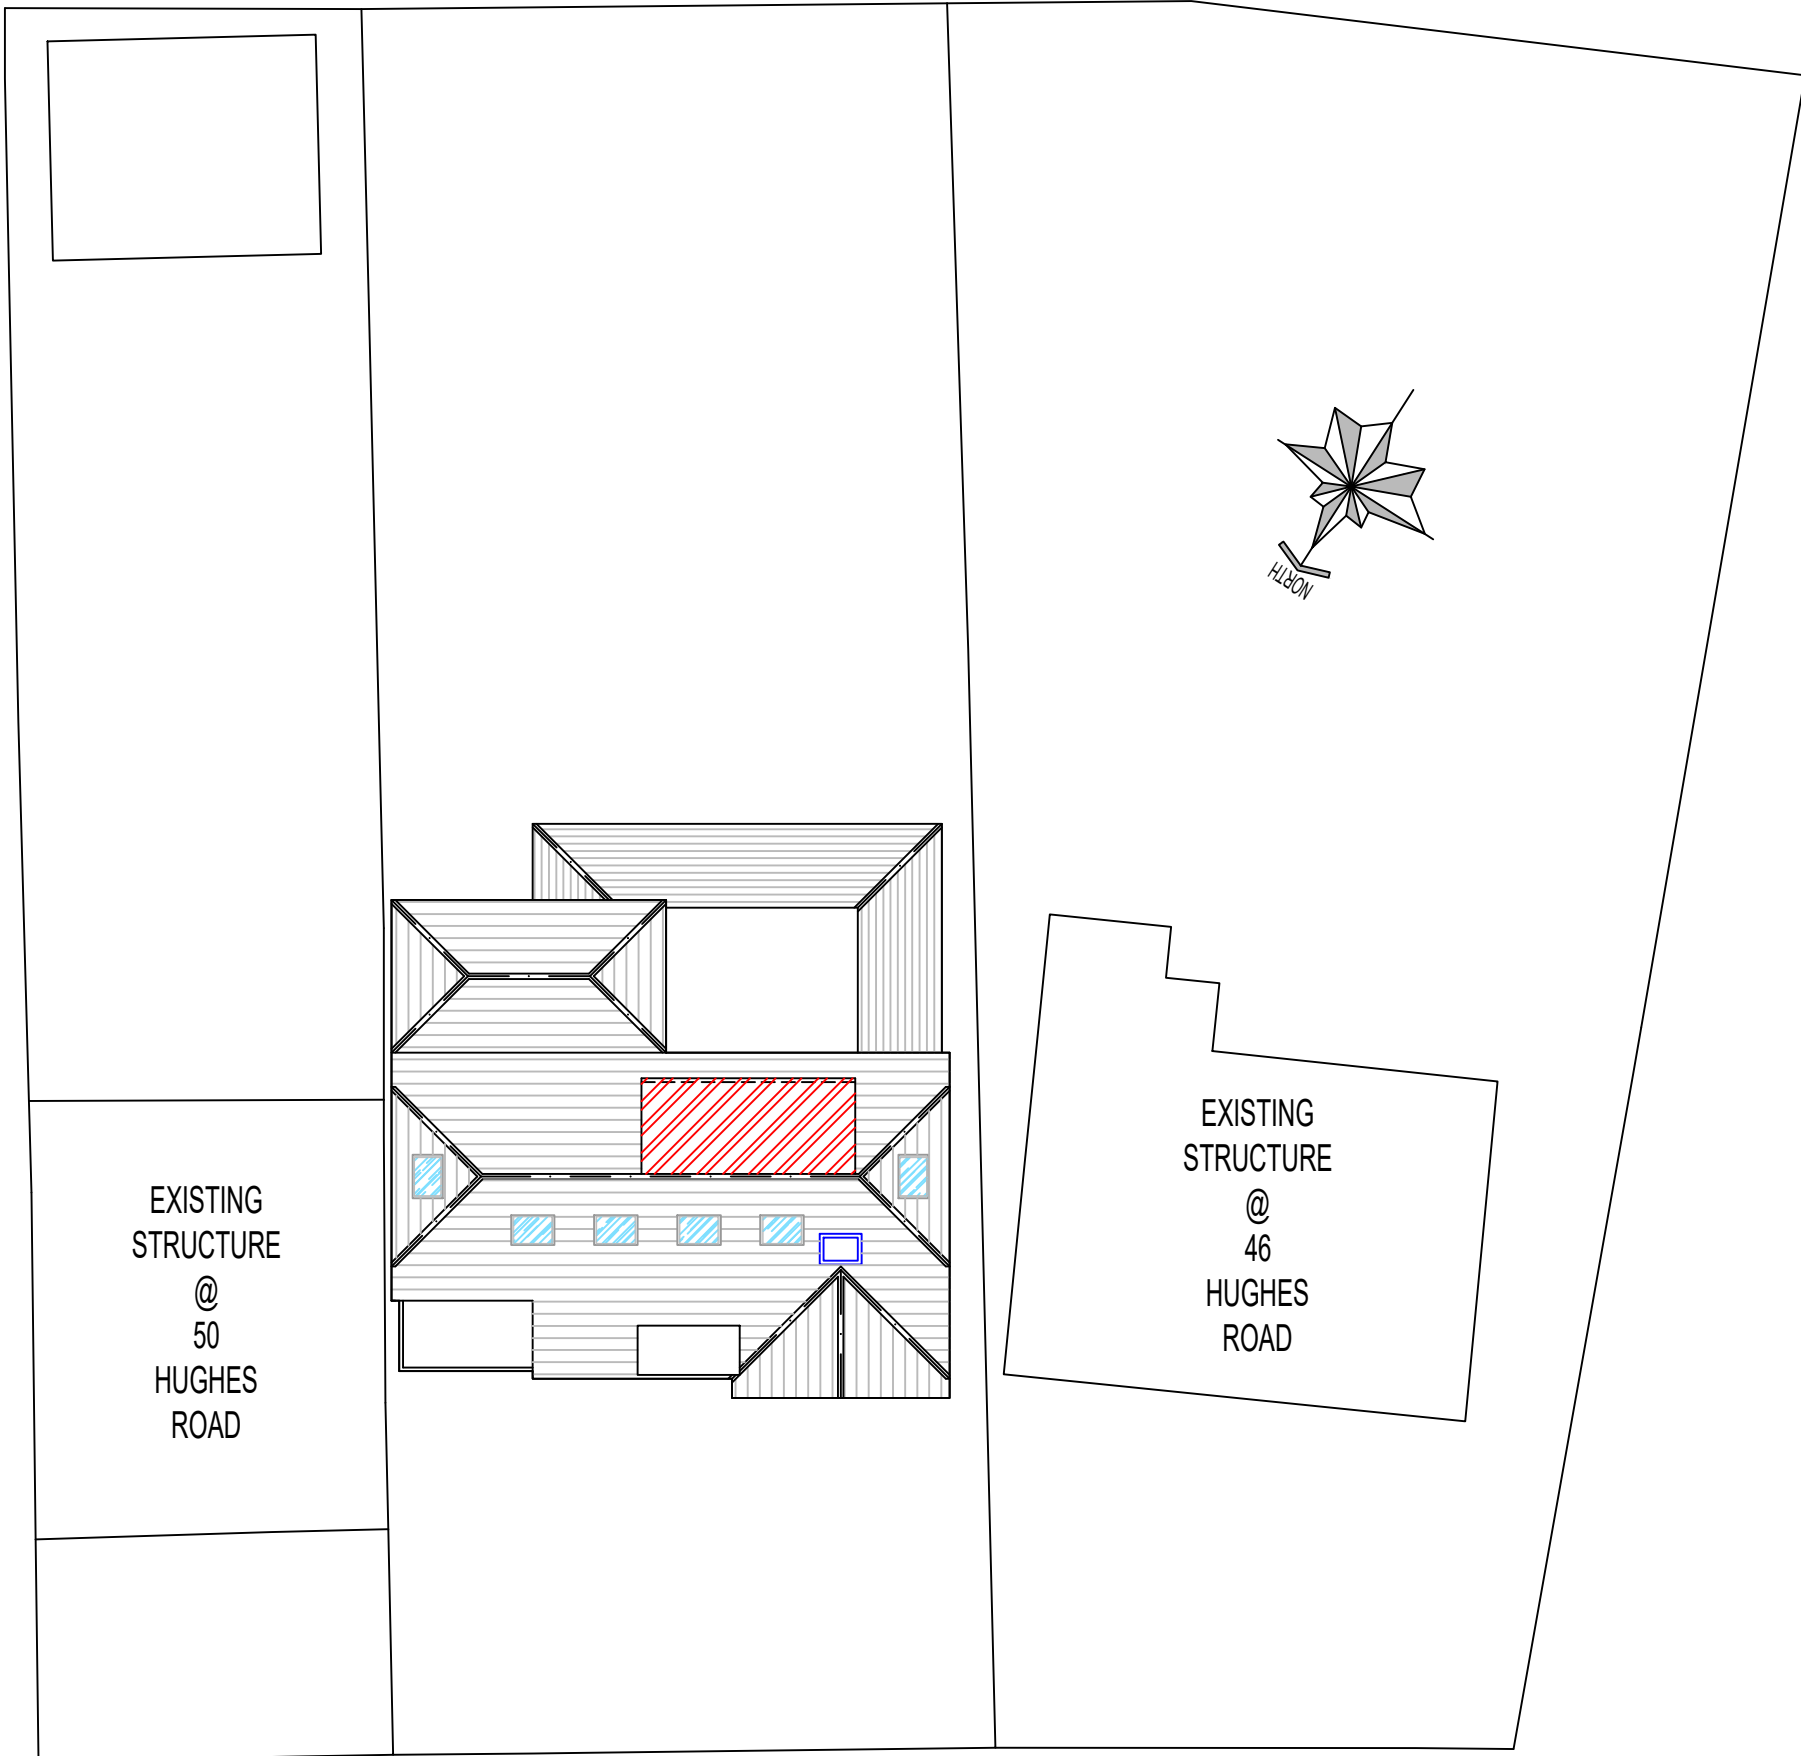

HUGHES ROAD
PROPOSED SITE PLAN
SCALE 1:200@A1