





FRONT ELEVATION




REAR ELEVATION

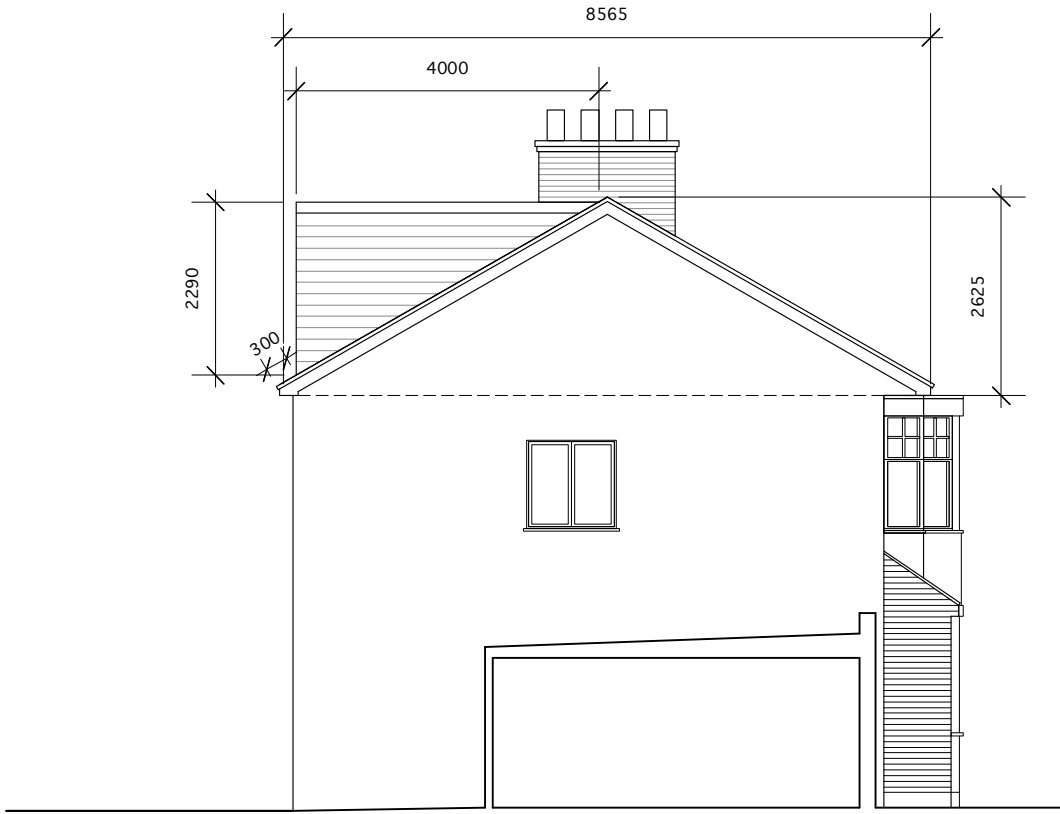


SIDE ELEVATION 1

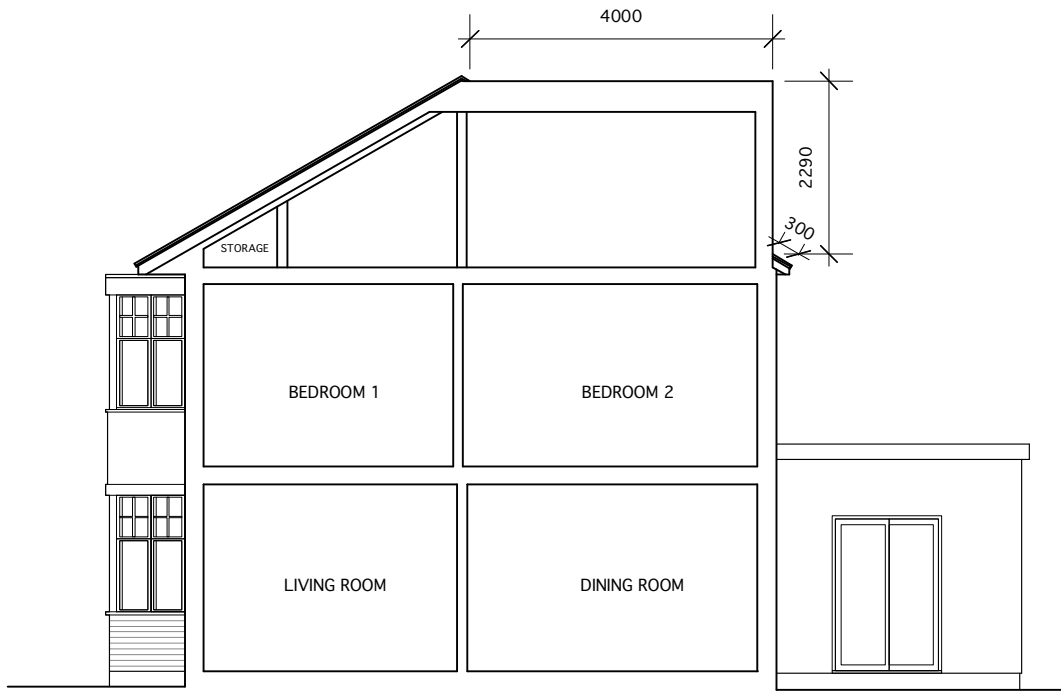


TYPICAL SECTION

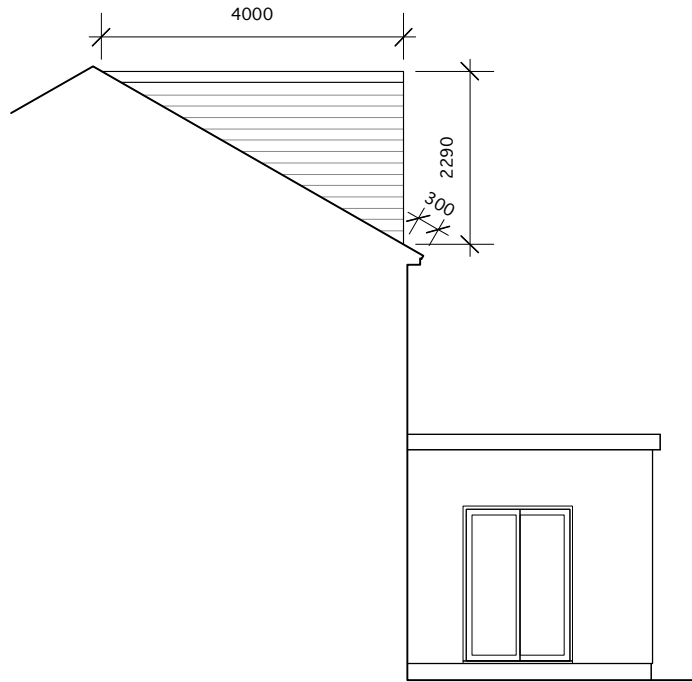


SIDE ELEVATION 2

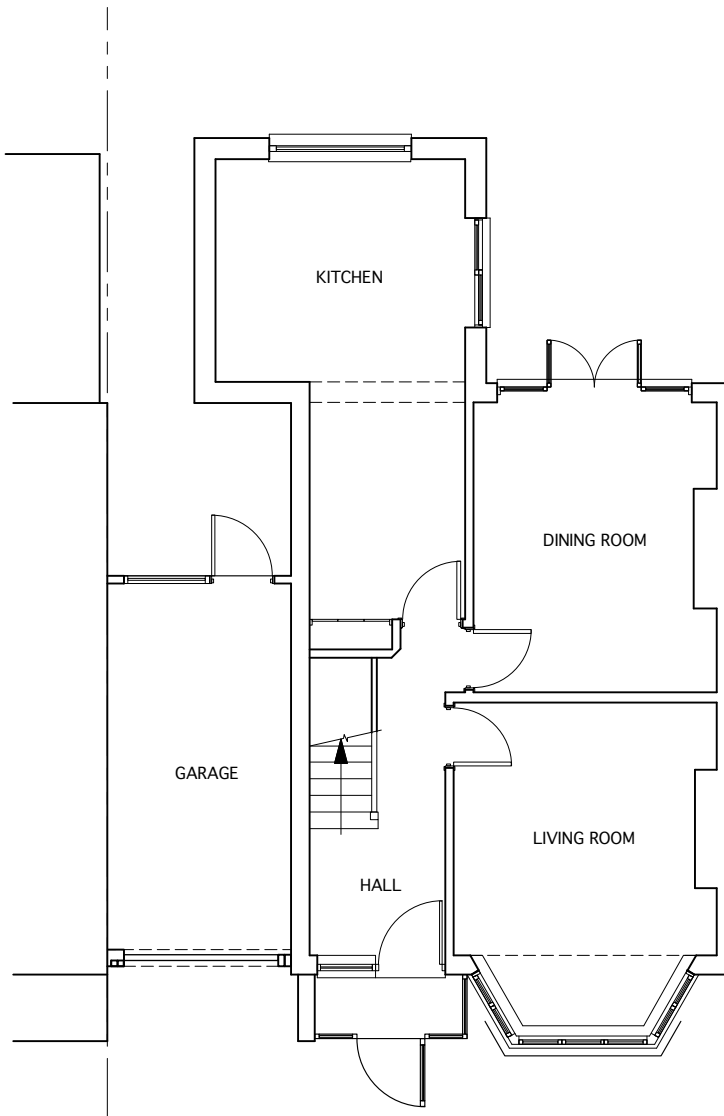


GROUND FLOOR PLAN

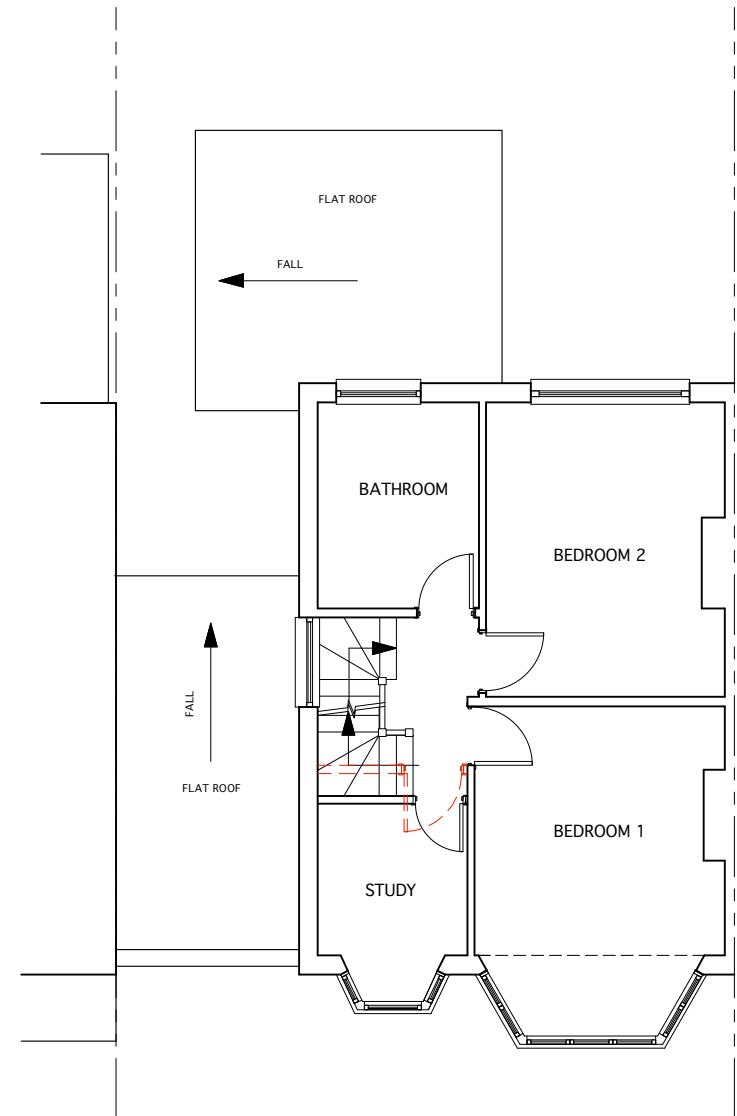

FIRST FLOOR PLAN

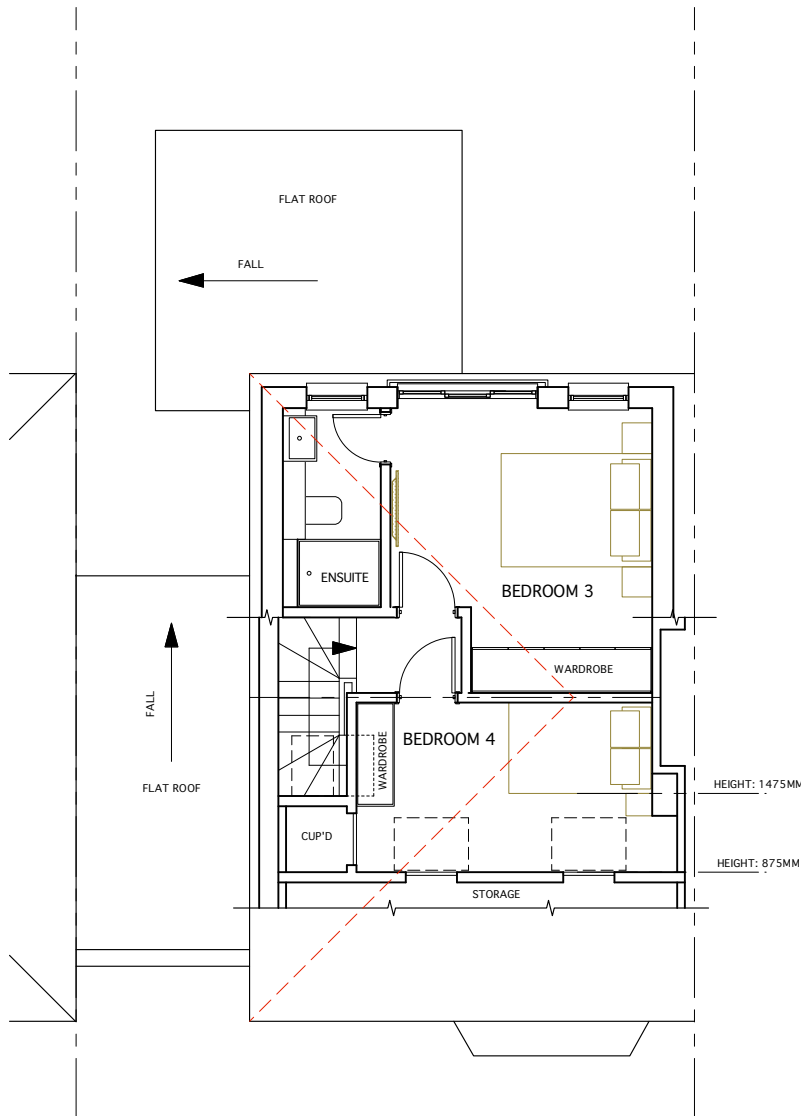

ROOF PLAN

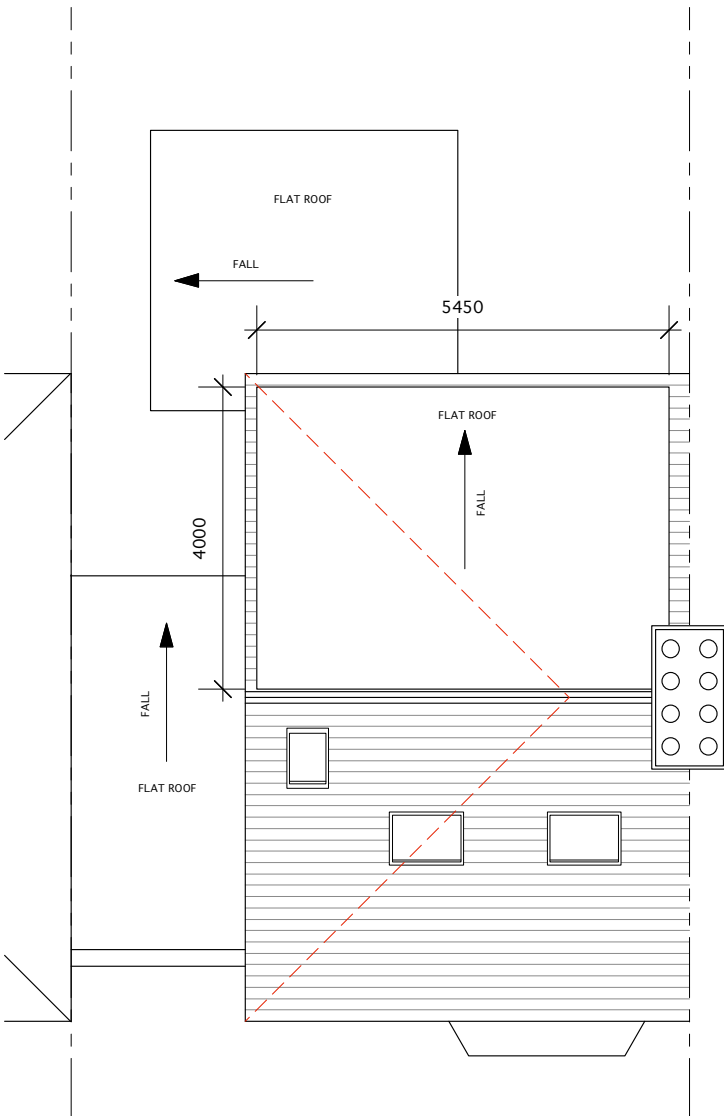

ROOF PLAN

VOLUME CALCULATION

VOLUME OF PROPOSED GABLE.

$$\left(\frac{2 \times 6.25 \text{M} \times 8.565 \text{M}}{2} \right) \times 4.355 \text{M} = 16.319 \text{M}^3$$

VOLUME OF PROPOSED DORMER

$$\left(\frac{4 \text{M} \times 2.29 \text{M} \times 5.45 \text{M}}{2} \right) = 24.961 \text{M}^3$$

TOTAL VOLUME = 41.25M³
(TOTAL VOLUME ALLOWED: 50M³)

THESE DRAWING ARE FOR PLANNING APPLICATIONS AND NOT FOR CONSTRUCTION

0 1m 2m 3m 4m 5m
SCALE 1:100

Client
**MR KEVIN McGREAL AND
MS CIARA O'SULLIVAN
18 GROSVENOR VALE
RUISLIP HA4 6JQ**

Job Title
**LOFT CONVERSION
(CERTIFICATE OF LAWFUL PROPOSE USE)**

Drawing
**PROPOSED
PLANS, ELEVATIONS
AND TYPICAL SECTION**

Date
16.04.25

Scale
1:100 @ A2

Job No
18GV

Drawing No
A-101

Revision No

ANDREAS GEORGIU t/a GIAD

Office F3, Kingsbury House
468 Church Lane, London NW9 8UA
Tel: 020 8200 2331
TEL: 07956 587037
email: andreas@giad.co.uk

ANDREAS GEORGIU t/a GIAD
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