

Existing Ground Floor Plan
Scale 1:100



Existing First Floor Plan
Scale 1:100

GENERAL NOTES:
 1. ALL DIMENSIONS ARE IN MILLIMETER.
 2. VERIFY ALL DIMENSIONS AND CONDITIONS BEFORE BUILDING OR
 STARTING CONSTRUCTION. NOTIFY THE DESIGNER IMMEDIATELY OF ANY
 DISCREPANCY OR VARIATION.
 3. ALL WORK TO COMPLY WITH CURRENT BUILDING REGULATIONS
 AND CODES OF PRACTICE

Title:

Existing Floor Plans

Site Address	Scale: 1:100 @A3	Revision Date:
29 Cranborne Way, Hayes. UB4 0HW	Date: 17/02/2023	
	Drawing No.: 2023/021-01	
	Drawn By: RO	
	e:mail - faluckpatel@yahoo.com (M) +44 (0) 7871 466 254	


10 Meter
5
2
1
0
1:100

Faluck Patel



Existing Front Elevation

Scale 1:100

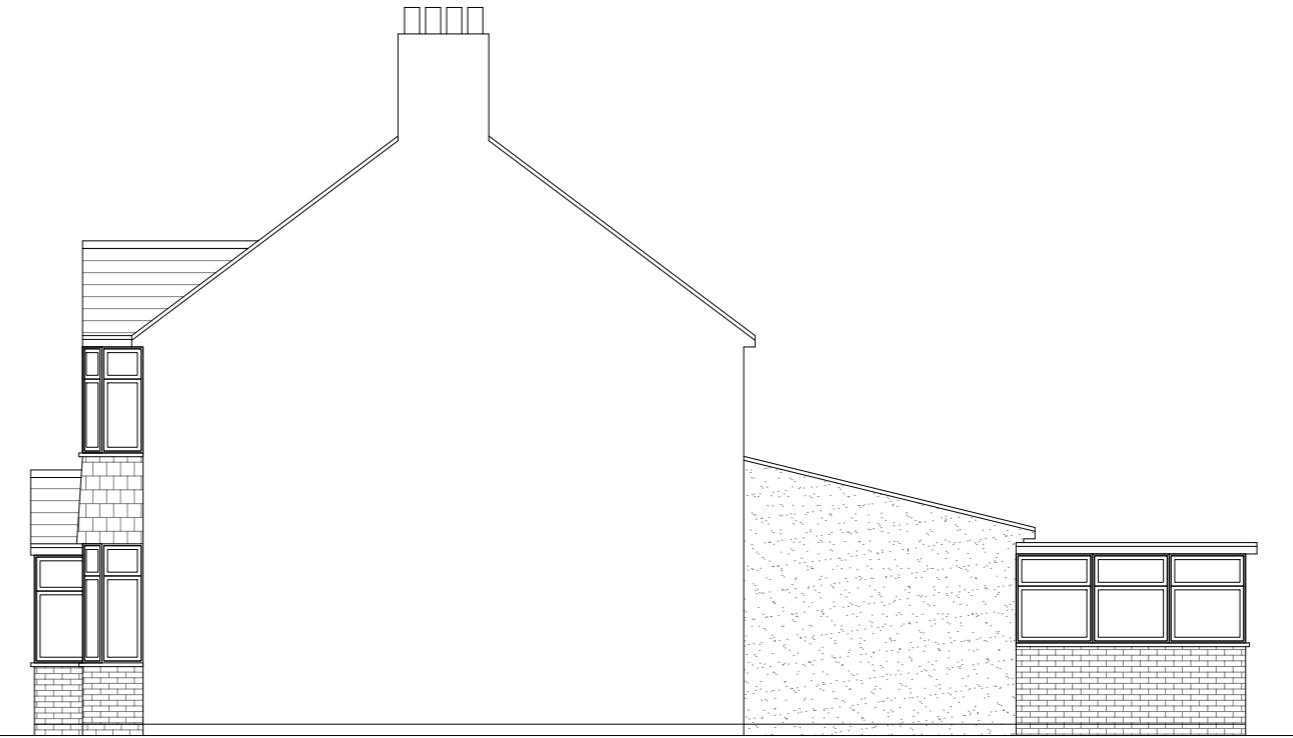


Existing Side Elevation

Scale 1:100



Existing Rear Elevation

Scale 1:100

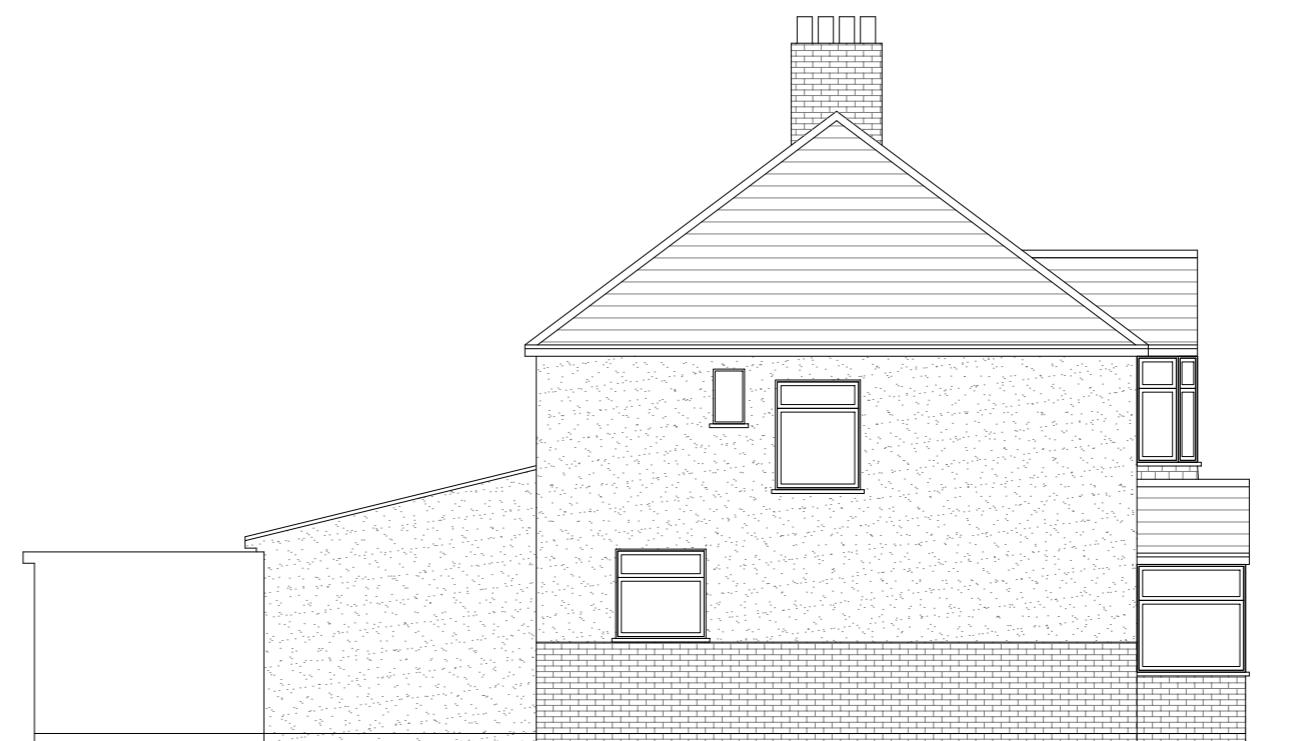

Existing Side Elevation

Scale 1:100

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Title:


Existing Elevations

Site Address
29 Cranborne Way,
Hayes.
UB4 0HW


Scale: 1:100 @A3
Date: 17/02/2023
Drawing No.: 2023/021 - 02
Drawn By: RO

Revision Date:
e:mail - faluckpatel@yahoo.com
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10 Meter
5
2
1
0
1:100

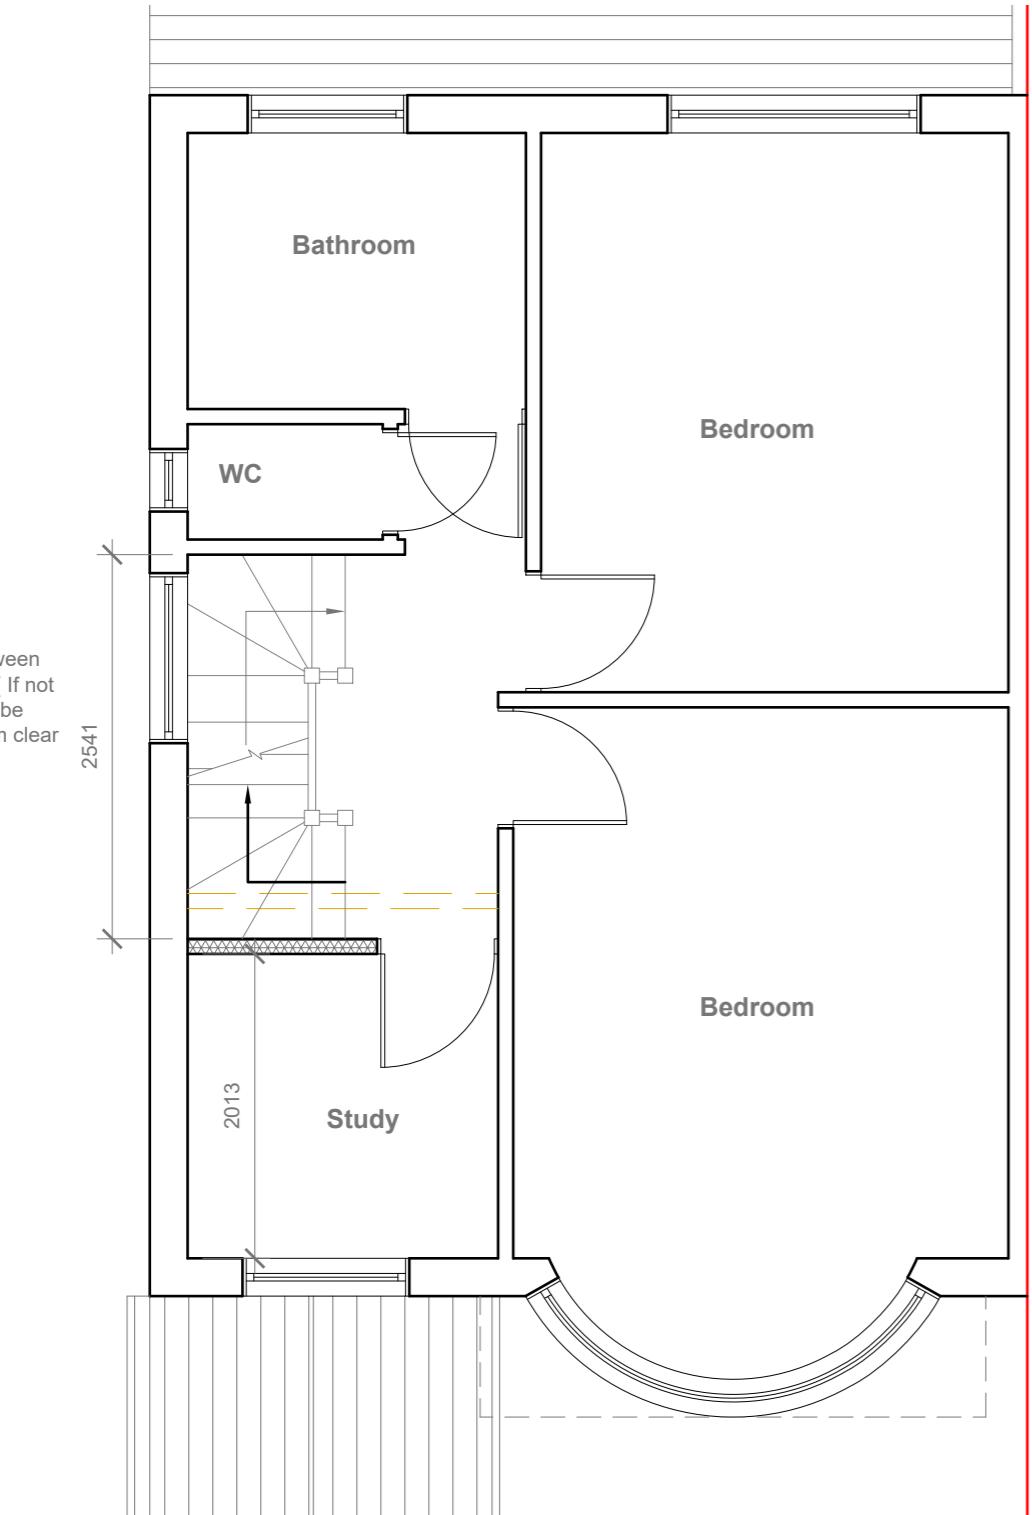

Proposed Flank Wall Window to be Obscure Glazed and Non Opening below 1.7m from FFL

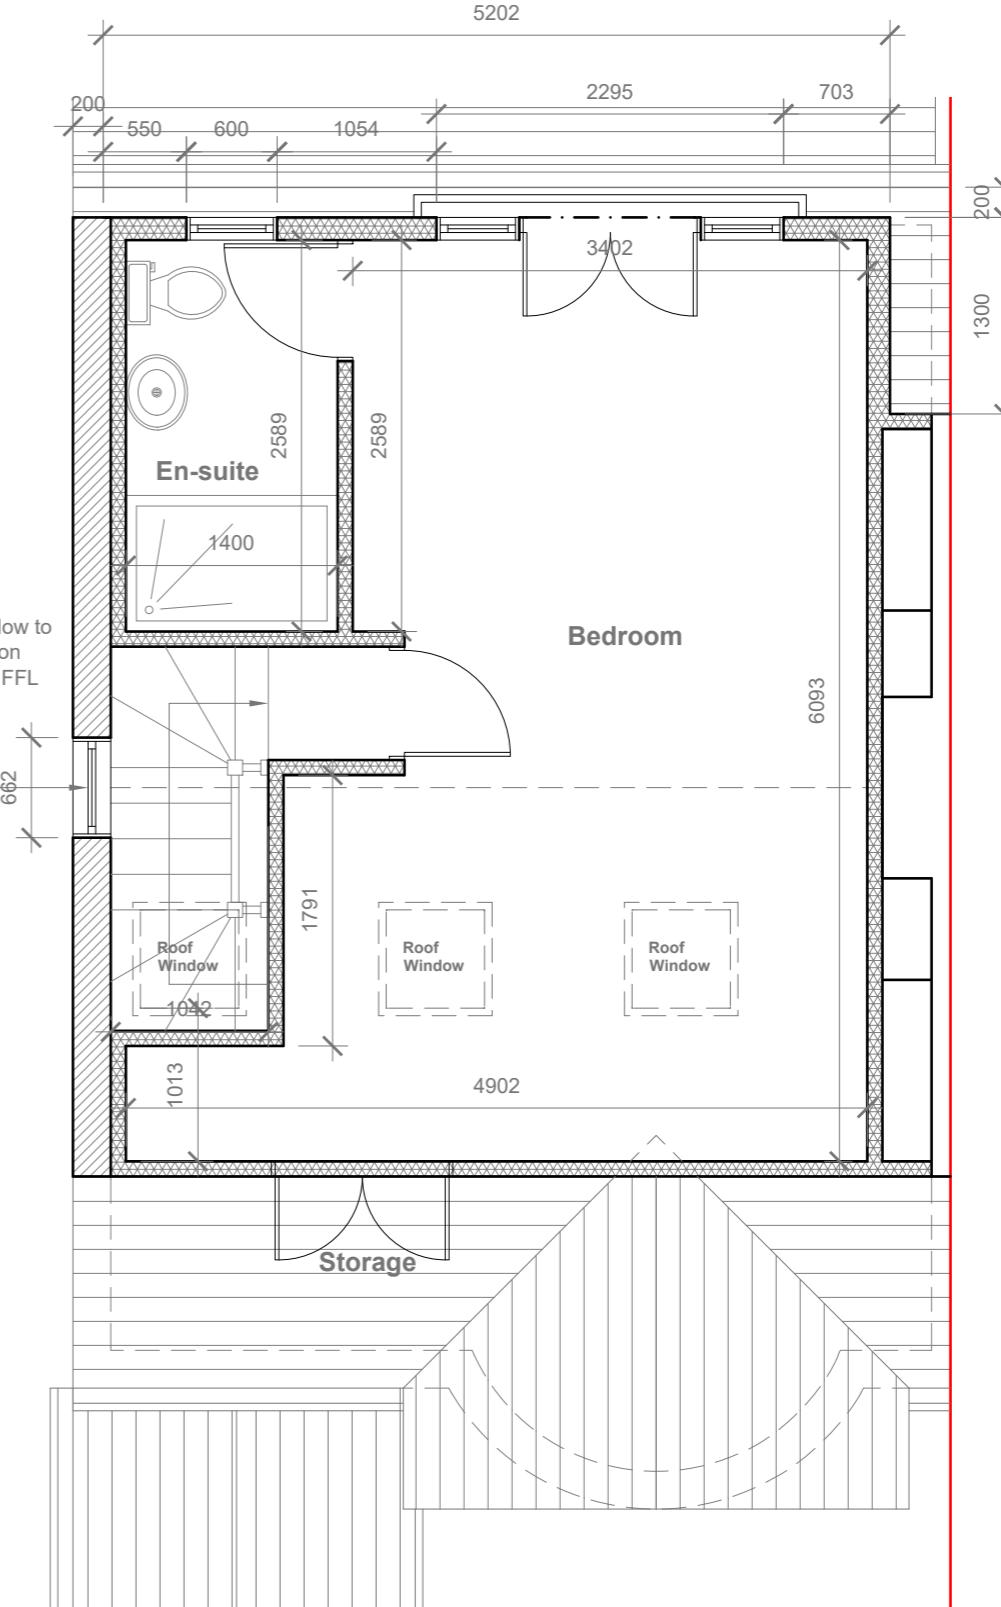

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Title:

Proposed First Floor & Loft Plans


Site Address	Scale: 1:50 @A3	Revision Date:
29 Cranborne Way, Hayes. UB4 0HW	Date: 17/02/2023	
	Drawing No.: 2023/021 - 03	
	Drawn By: RO	
	e:mail - faluckpatel@yahoo.com (M) +44 (0) 7871 466 254	

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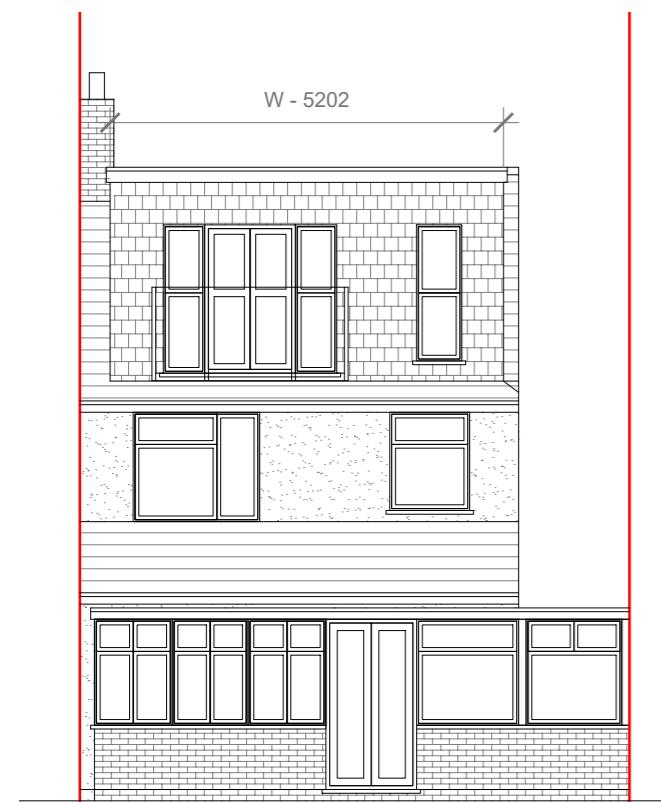
Proposed Front Elevation

Scale 1:100




Proposed Side Elevation

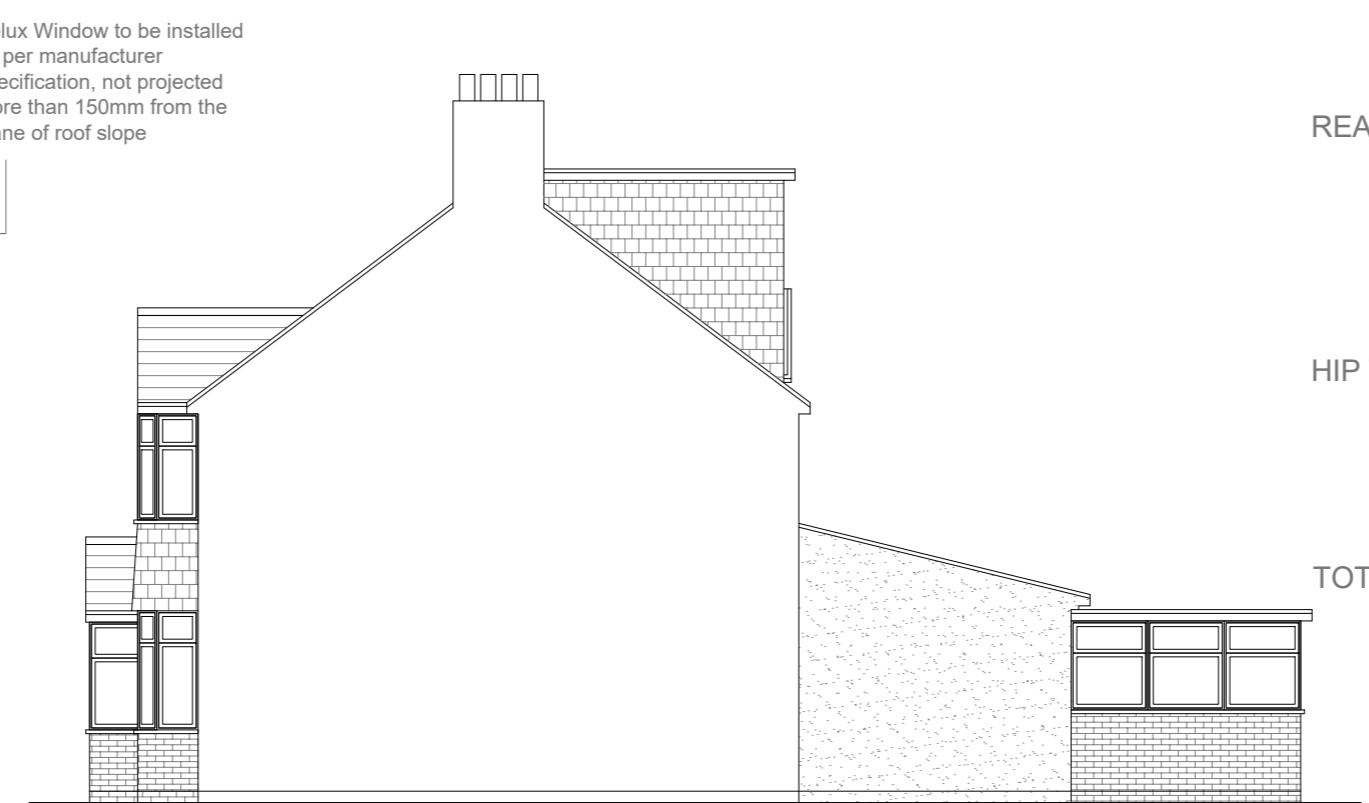Scale 1:100



Proposed Rear Elevation

Scale 1:100

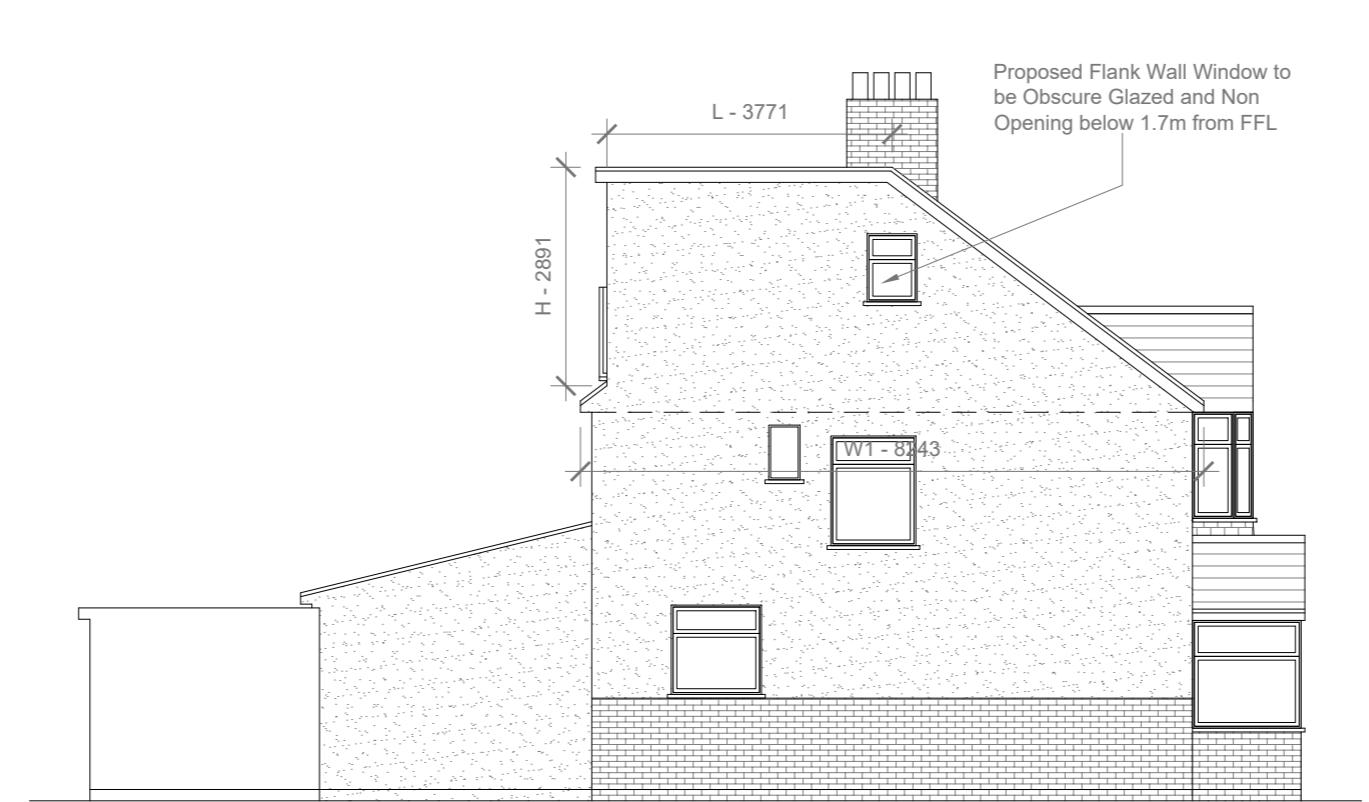

Proposed Side Elevation

Scale 1:100

Proposed External Finish
Materials to Match Existing
External Finish Materials

$W \times H \times L / 2$
5.202 X 2.829 X 3.771 / 2
55.49 / 2
27.74 CU.MT.

REAR DORMER VOLUME =
V1 =

HIP TO GABLE ROOF VOLUME =
V2 =

TOTAL ROOF VOLUME =
V1 + V2
27.74 + 17.68
45.42 CU.MT. < 50.00 CU.MT

$W1 \times H1 \times L1 / 6$
8.243 X 3.241 X 3.972 / 6
106.11 / 6
17.68 CU.MT.

$V1 + V2$
27.74 + 17.68
45.42 CU.MT. < 50.00 CU.MT

10 Meter
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2
1
0
1:100

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Title:

Proposed Elevations

Site Address
29 Cranborne Way,
Hayes.
UB4 0HW

Scale: 1:100 @A3
Date: 17/02/2023
Drawing No.:
2023/021 - 04
Drawn By:
RO

Revision Date:

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