




Existing Ground Floor Plan
Scale 1:100

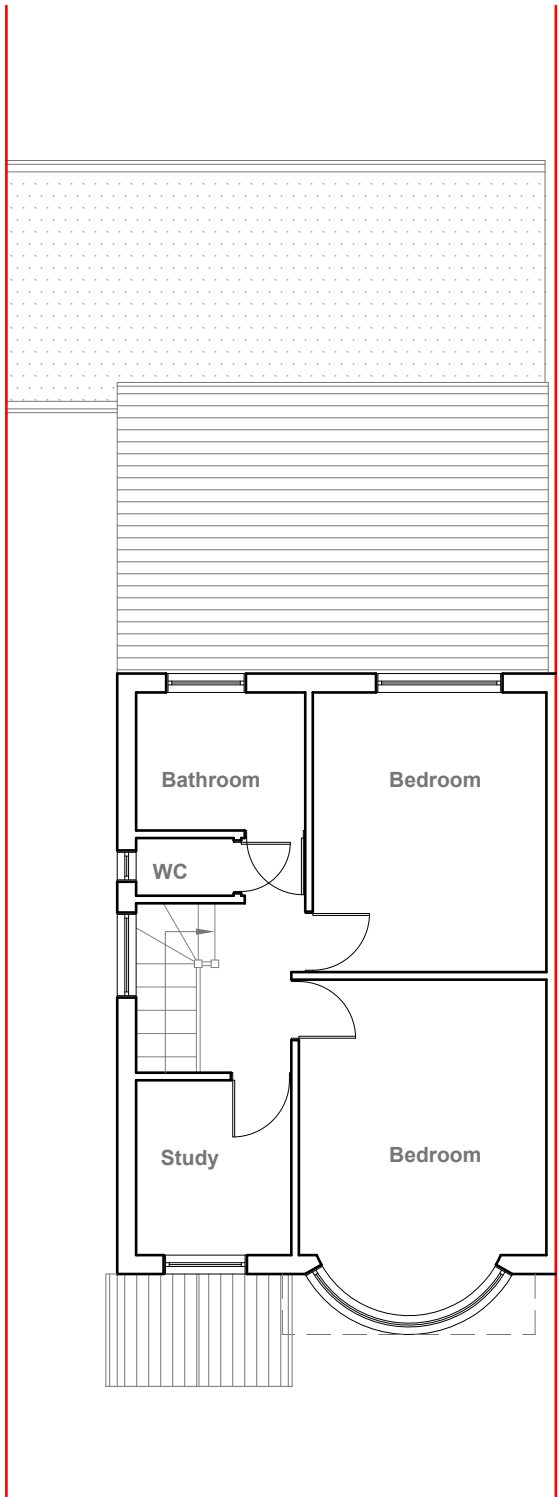

Existing First Floor Plan
Scale 1:100



GENERAL NOTES:
1. ALL DIMENSIONS ARE IN MILLIMETER.
2. VERIFY ALL DIMENSIONS AND CONDITIONS BEFORE BUILDING OR STARTING CONSTRUCTION. NOTIFY THE DESIGNER IMMEDIATELY OF ANY DISCREPANCY OR VARIATION.
3. ALL WORK TO COMPLY WITH CURRENT BUILDING REGULATIONS AND CODES OF PRACTICE

Title:

Existing Floor Plans

Site Address
29 Cranborne Way,
Hayes.
UB4 0HW


Scale: 1:100 @A3
Date: 17/02/2023
Drawing No.:
2023/021 -01
Drawn By:
RO

Revision Date:
e:mail -
faluckpatel@yahoo.com
(M) +44 (0) 7871 466 254

**Faluck
Patel**




Existing Front Elevation
Scale 1:100

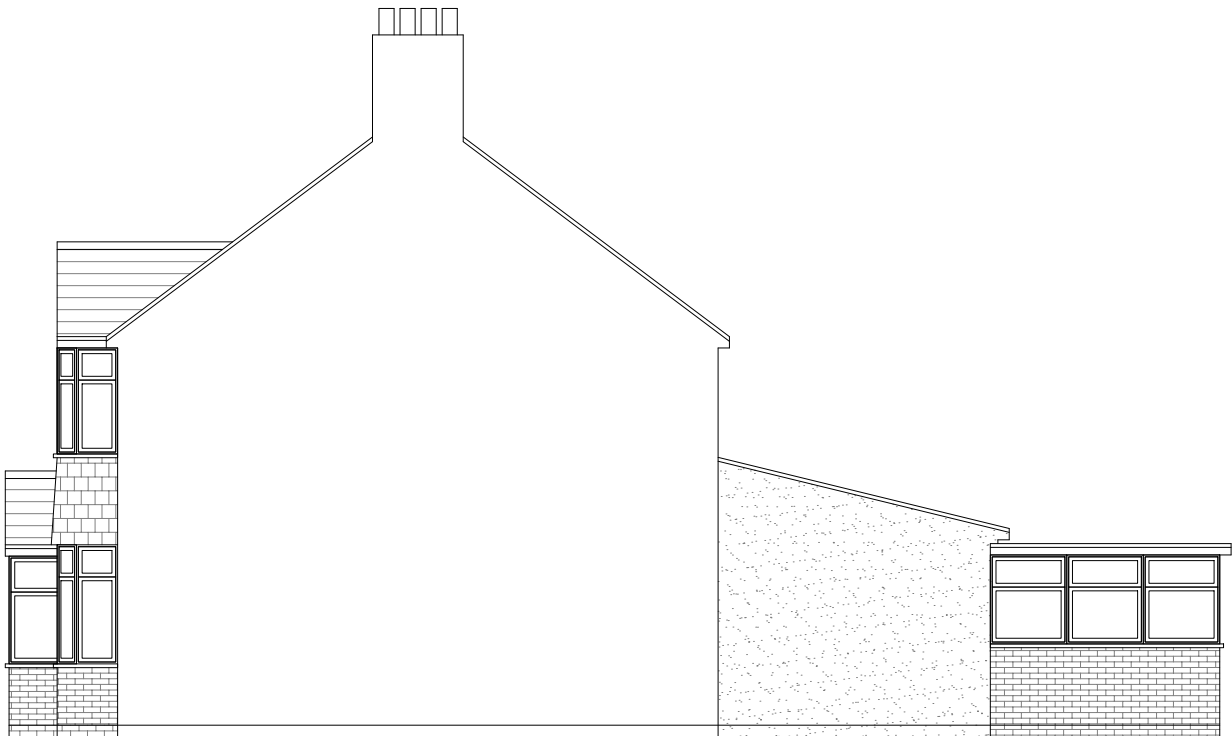

Existing Side Elevation
Scale 1:100



Existing Rear Elevation
Scale 1:100

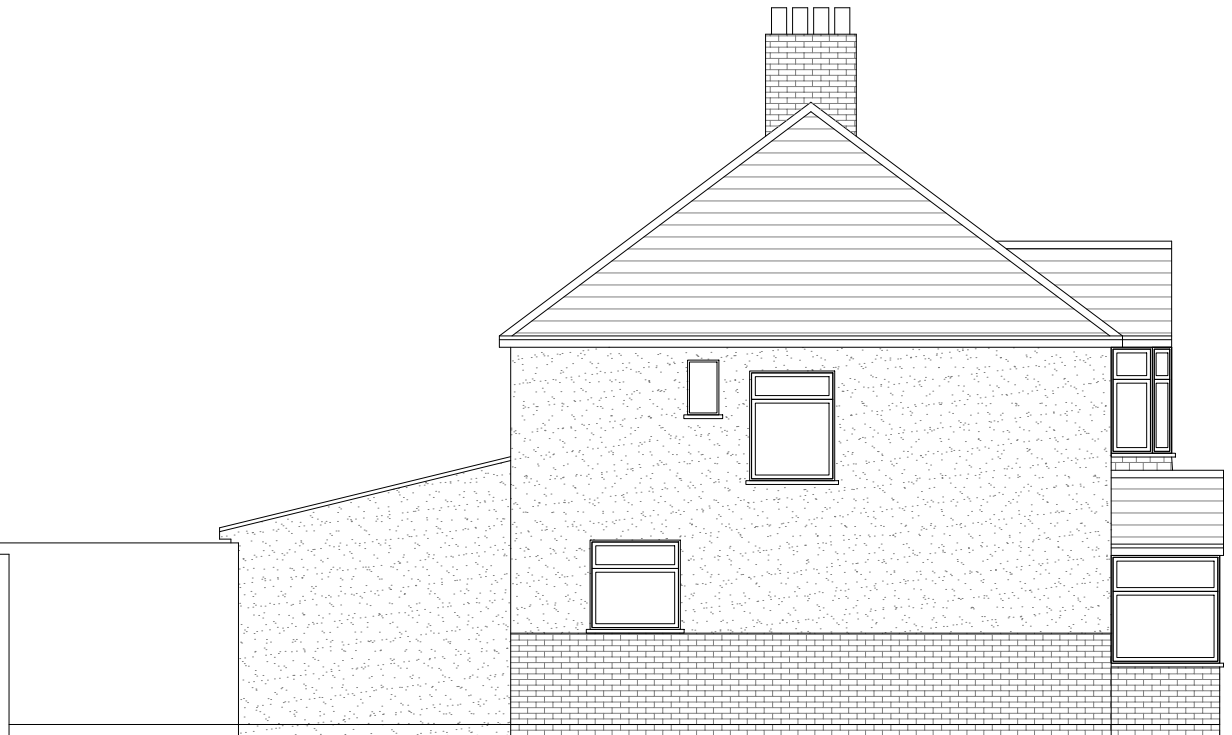

Existing Side Elevation
Scale 1:100



GENERAL NOTES:
1. ALL DIMENSIONS ARE IN MILLIMETER.
2. VERIFY ALL DIMENSIONS AND CONDITIONS BEFORE BUILDING OR STARTING CONSTRUCTION. NOTIFY THE DESIGNER IMMEDIATELY OF ANY DISCREPANCY OR VARIATION.
3. ALL WORK TO COMPLY WITH CURRENT BUILDING REGULATIONS AND CODES OF PRACTICE

Title:

Existing Elevations


Site Address
29 Cranborne Way,
Hayes.
UB4 0HW

Scale: 1:100 @A3
Date: 17/02/2023
Drawing No.:
2023/021 - 02
Drawn By:
RO

Revision Date:


e:mail -
faluckpatel@yahoo.com
(M) +44 (0) 7871 466 254



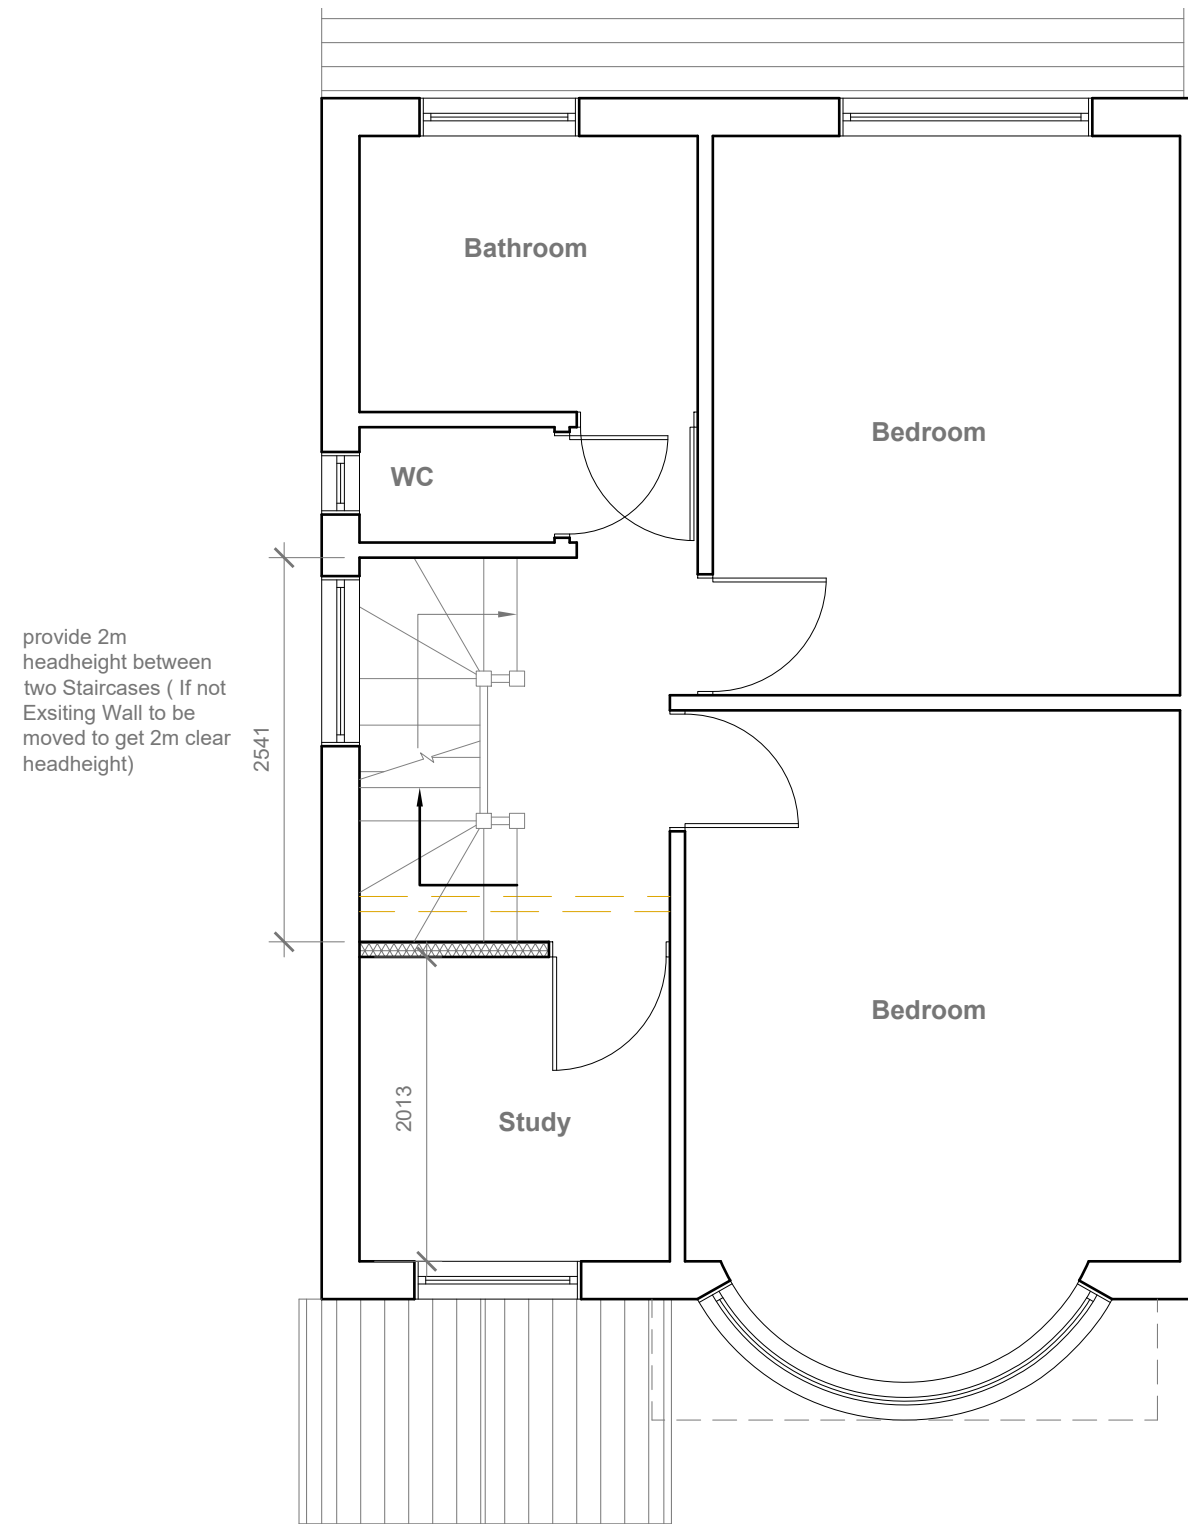

Proposed First Floor Plan

Scale 1:50

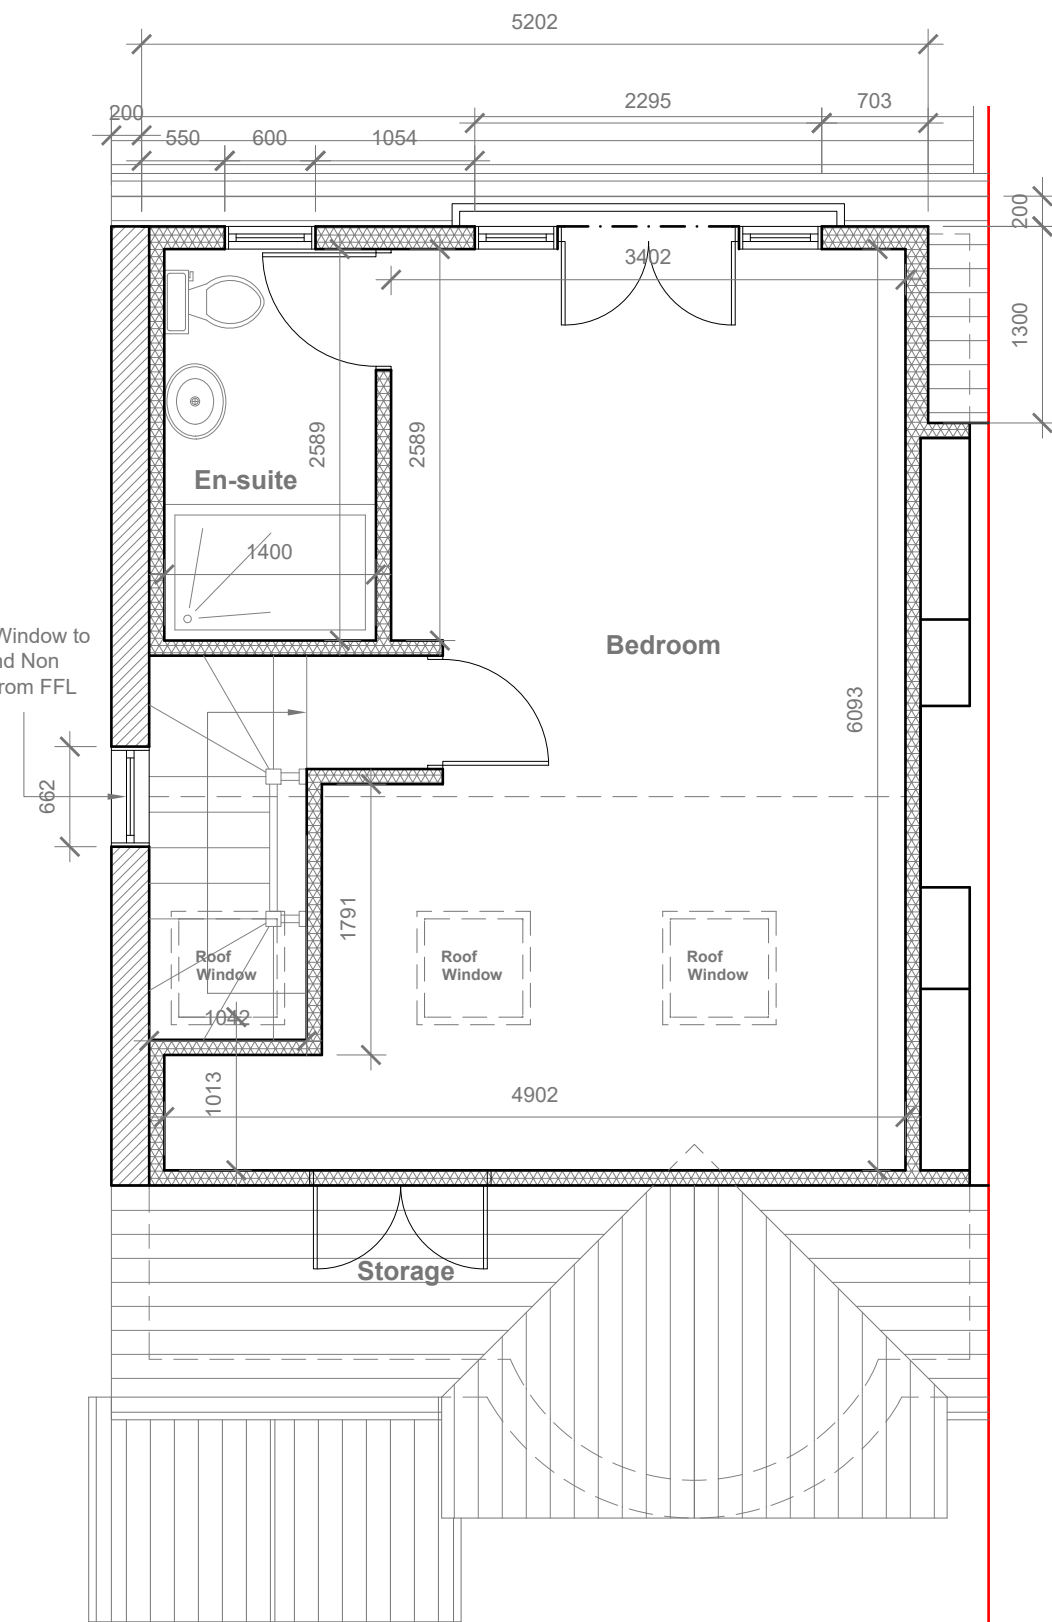

Proposed Loft Floor Plan

Scale 1:50

Velux Window to be installed as per manufacturer specification, not projected more than 150mm from the plane of roof slope



- | |
|---|
| <p>GENERAL NOTES:</p> <ol style="list-style-type: none">1. ALL DIMENSIONS ARE IN MILLIMETER.2. VERIFY ALL DIMENSIONS AND CONDITIONS BEFORE BUILDING OR STARTING CONSTRUCTION. NOTIFY THE DESIGNER IMMEDIATELY OF ANY DISCREPANCY OR VARIATION.3. ALL WORK TO COMPLY WITH CURRENT BUILDING REGULATIONS AND CODES OF PRACTICE |
|---|

Title:	
--------	--

Proposed First Floor & Loft Plans

Site Address

29 Cranborne Way,
Hayes.
UB4 0HW

Scale: 1:50 @A3

Date: 17/02/2023

Drawing No.:
2023/021 - 03

Drawn By:
RO


Revision Date:

e:mail -
faluckpatel@yahoo.com
(M) +44 (0) 7871 466 254

Faluck Patel




Proposed Front Elevation
Scale 1:100

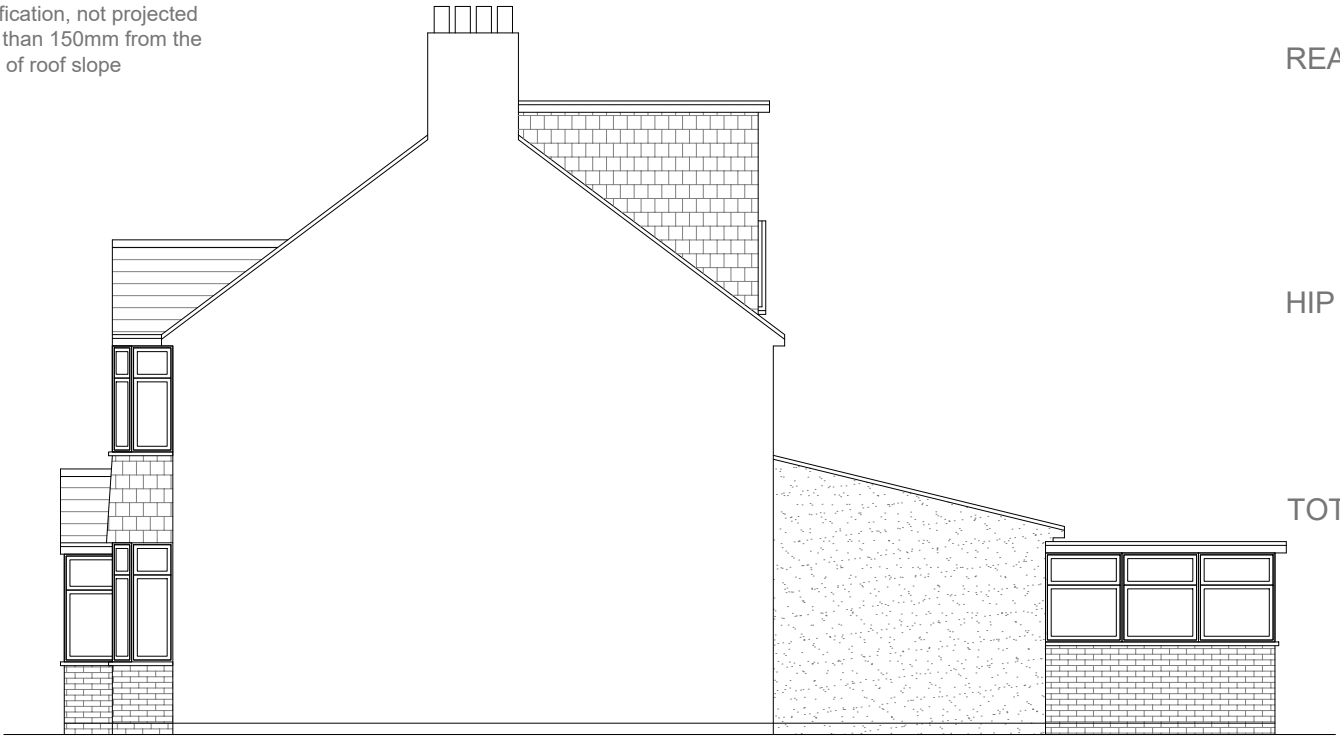

Proposed Side Elevation
Scale 1:100



Proposed Rear Elevation
Scale 1:100

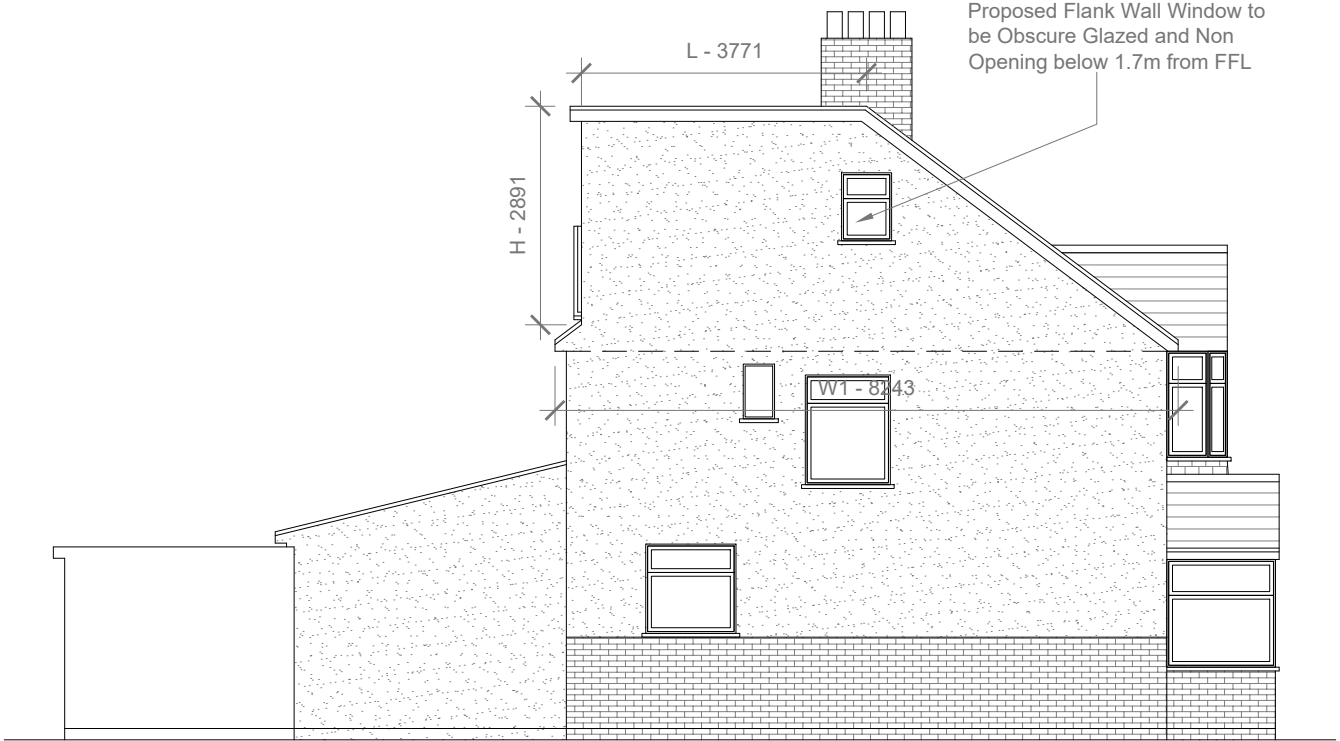

Proposed Side Elevation
Scale 1:100

REAR DORMER VOLUME = $W \times H \times L / 2$
 $5.202 \times 2.829 \times 3.771 / 2$
 $55.49 / 2$
 27.74 CU.MT.

HIP TO GABLE ROOF VOLUME = $W1 \times H1 \times L1 / 6$
 $8.243 \times 3.241 \times 3.972 / 6$
 $106.11 / 6$
 17.68 CU.MT.

TOTAL ROOF VOLUME = $V1 + V2$
 $27.74 + 17.68$
 $45.42 \text{ CU.MT.} < 50.00 \text{ CU.MT}$

Proposed External Finish
Materials to Match Existing
External Finish Materials



GENERAL NOTES:
1. ALL DIMENSIONS ARE IN MILLIMETER.
2. VERIFY ALL DIMENSIONS AND CONDITIONS BEFORE BUILDING OR STARTING CONSTRUCTION. NOTIFY THE DESIGNER IMMEDIATELY OF ANY DISCREPANCY OR VARIATION.
3. ALL WORK TO COMPLY WITH CURRENT BUILDING REGULATIONS AND CODES OF PRACTICE

Title:

Proposed Elevations

Site Address	Scale: 1:100 @A3	Revision Date:	Faluck Patel
29 Cranborne Way, Hayes. UB4 0HW	Date: 17/02/2023		
	Drawing No.: 2023/021 - 04		
	Drawn By: RO	e:mail - faluckpatel@yahoo.com (M) +44 (0) 7871 466 254	