


Existing Ground Floor Plan
Scale 1:100

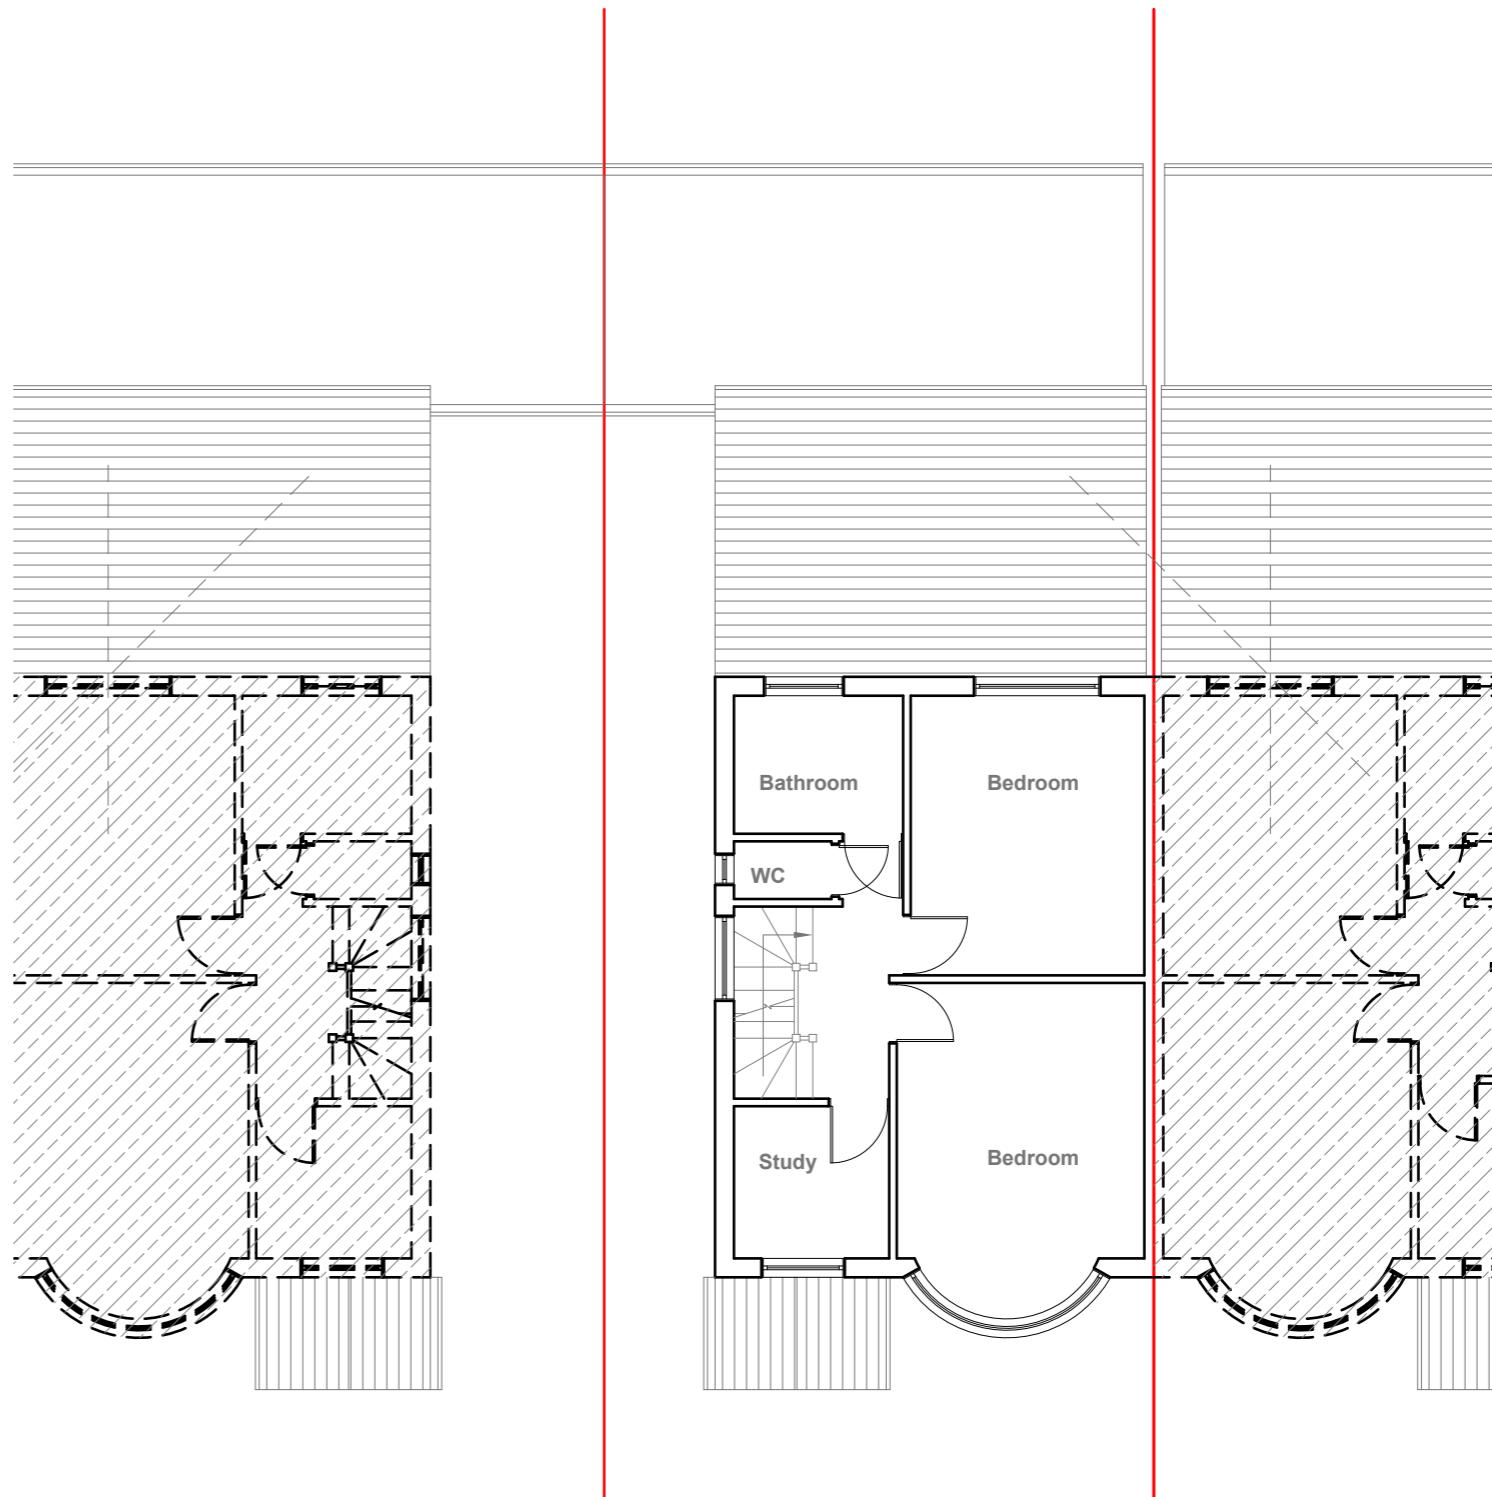

Existing First Floor Plan
Scale 1:100

GENERAL NOTES:

1. ALL DIMENSIONS ARE IN MILLIMETER.
2. VERIFY ALL DIMENSIONS AND CONDITIONS BEFORE BUILDING OR STARTING CONSTRUCTION. NOTIFY THE DESIGNER IMMEDIATELY OF ANY DISCREPANCY OR VARIATION.
3. ALL WORK TO COMPLY WITH CURRENT BUILDING REGULATIONS AND CODES OF PRACTICE

Title:

Existing Floor Plans

Site Address

29 Cranborne Way,
Hayes.
UB4 0HW

Scale: 1:100 @A3

Date: 29/08/2023
Drawing No.:
2023/021 -01HH

Revision Date:

Drawn By:
RO

e:mail -
faluckpatel@yahoo.com
(M) +44 (0) 7871 466 254


10 Meter
5
2
1
0
1:100

Faluck Patel



Existing Front Elevation

Scale 1:100

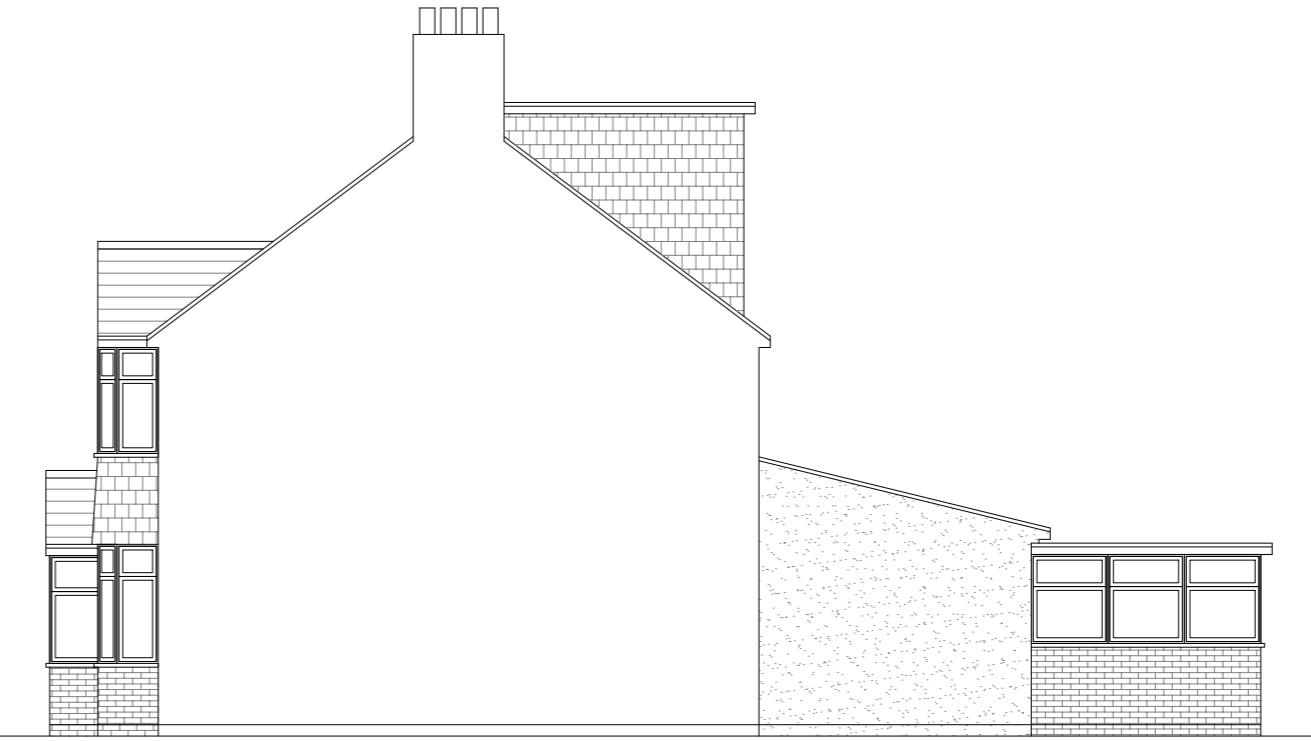


Existing Side Elevation

Scale 1:100



Existing Rear Elevation

Scale 1:100

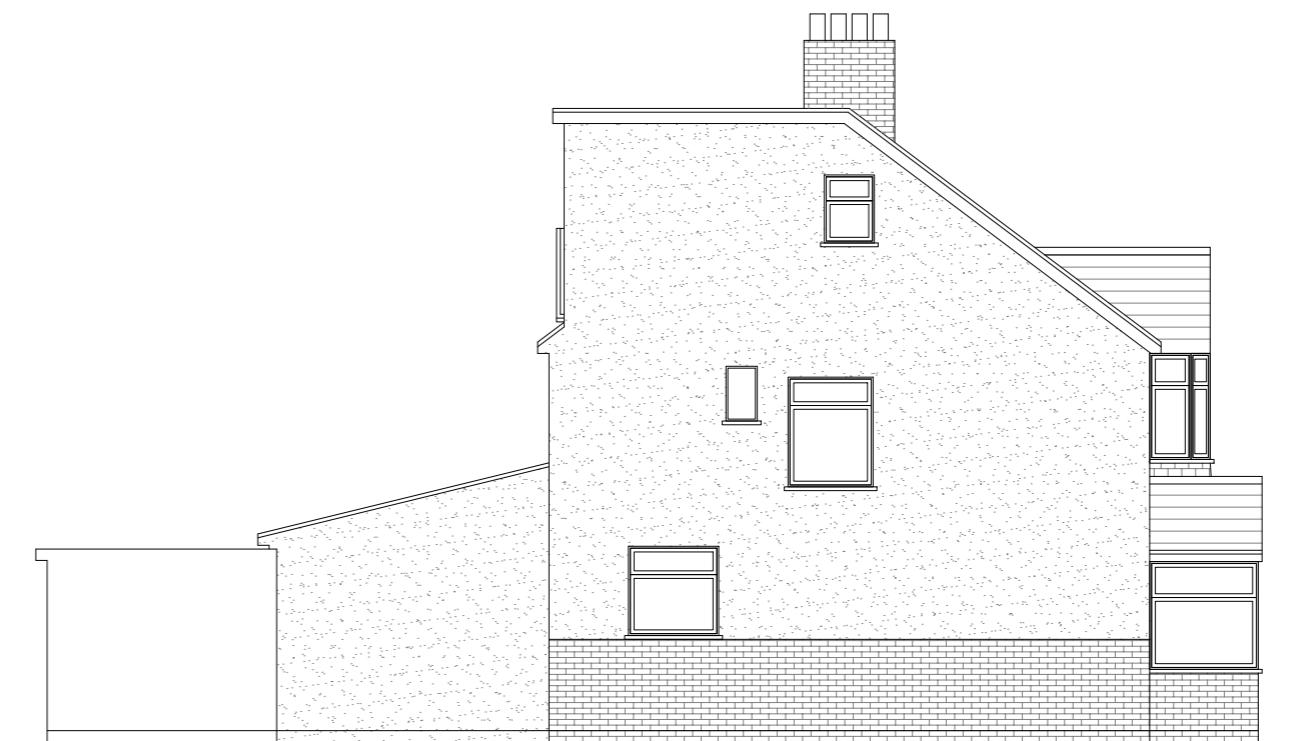

Existing Side Elevation

Scale 1:100

GENERAL NOTES:

1. ALL DIMENSIONS ARE IN MILLIMETER.
2. VERIFY ALL DIMENSIONS AND CONDITIONS BEFORE BUILDING OR STARTING CONSTRUCTION. NOTIFY THE DESIGNER IMMEDIATELY OF ANY DISCREPANCY OR VARIATION.
3. ALL WORK TO COMPLY WITH CURRENT BUILDING REGULATIONS AND CODES OF PRACTICE

Title:

Existing Elevations





Site Address
29 Cranborne Way,
Hayes.
UB4 0HW

Scale: 1:100 @A3
Date: 29/08/2023
Drawing No.: 2023/021 - 02HH
Drawn By:
RO

Revision Date:
e:mail - faluckpatel@yahoo.com
(M) +44 (0) 7871 466 254

10 Meter
5
2
1
0
1:100

Faluck Patel

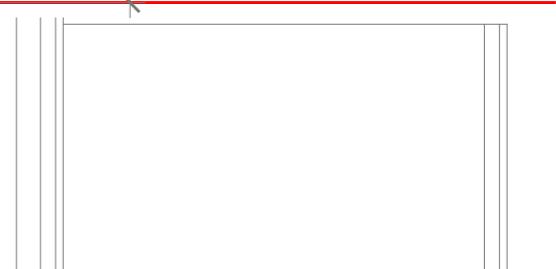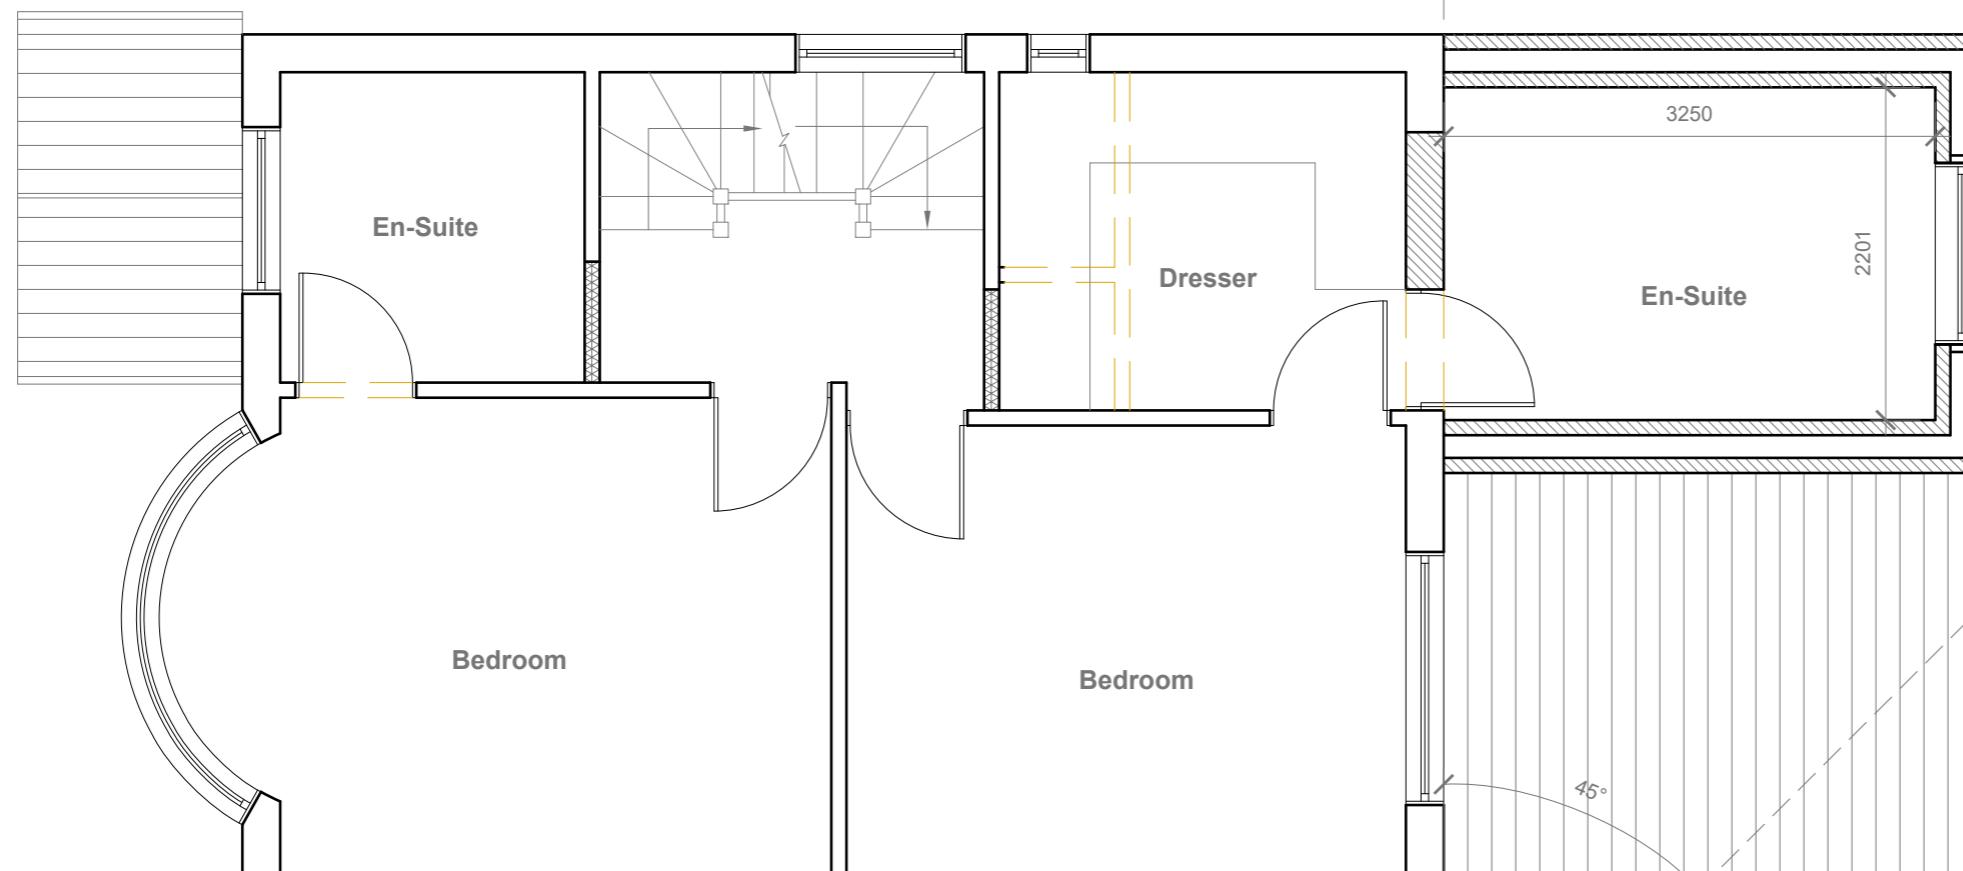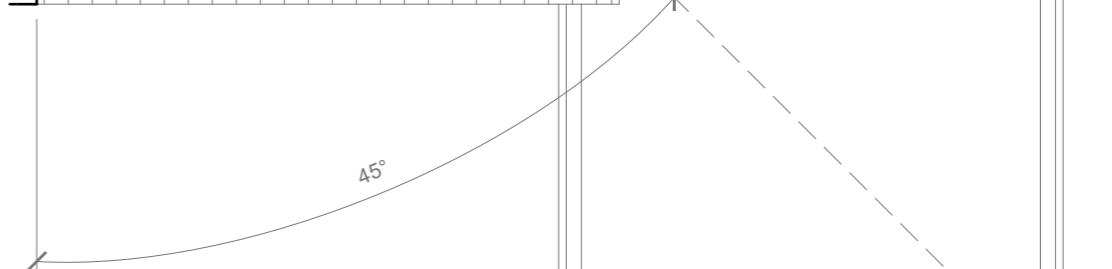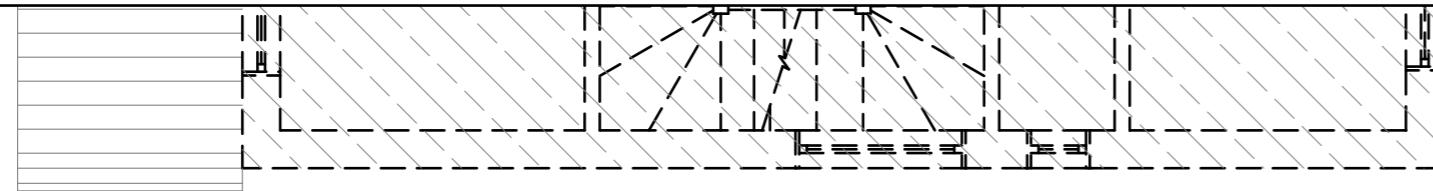

1:50
0 1 2 5 Meter

GENERAL NOTES:

1. ALL DIMENSIONS ARE IN MILLIMETER.
2. VERIFY ALL DIMENSIONS AND CONDITIONS BEFORE BUILDING OR STARTING CONSTRUCTION. NOTIFY THE DESIGNER IMMEDIATELY OF ANY DISCREPANCY OR VARIATION.
3. ALL WORK TO COMPLY WITH CURRENT BUILDING REGULATIONS AND CODES OF PRACTICE

Title:

Proposed First Floor

Site Address
29 Cranborne Way,
Hayes.
UB4 0HW

Scale: 1:50 @A3
Date: 29/08/2023
Drawing No.:
2023/021 - 03HH
Drawn By:
RO

Revision Date:

e:mail -
faluckpatel@yahoo.com
(M) +44 (0) 7871 466 254


**Faluck
Patel**

Proposed External Finish
Materials to Match Existing
External Finish Materials



Proposed Front Elevation

Scale 1:100

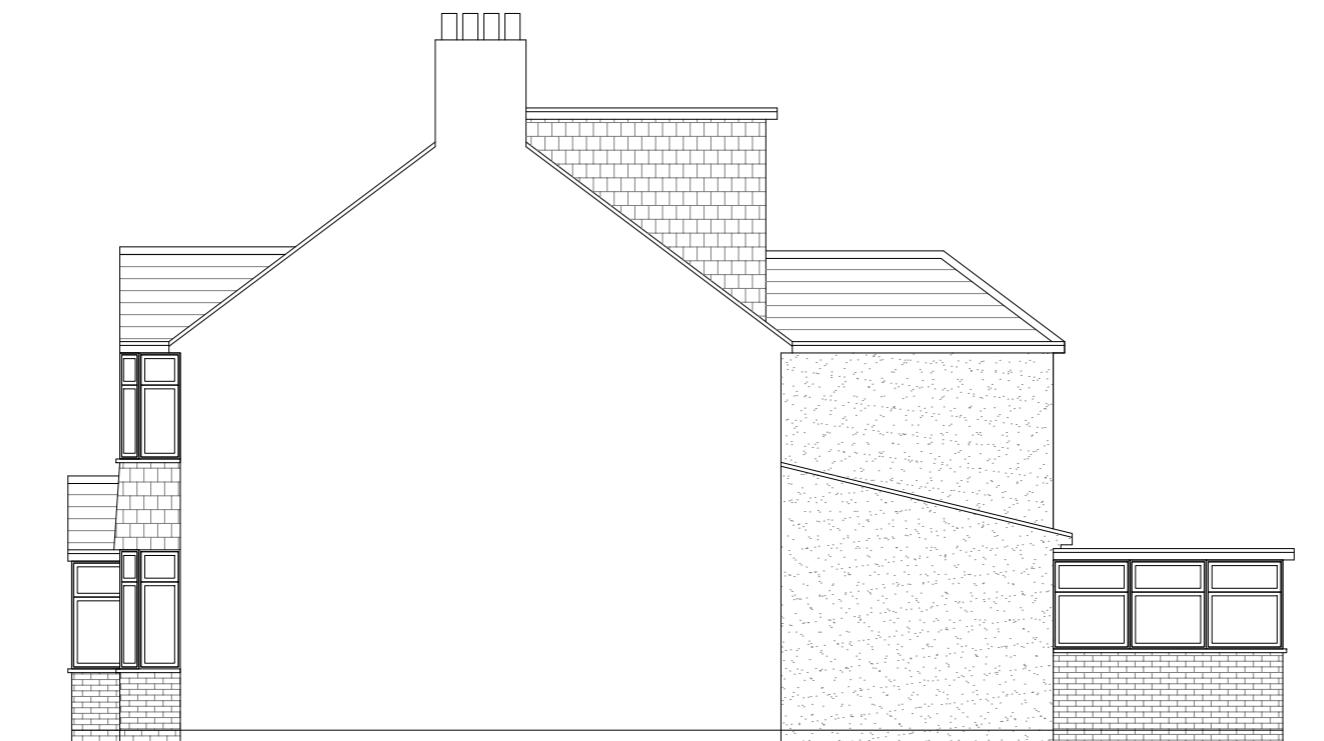


Proposed Side Elevation

Scale 1:100



Proposed Rear Elevation

Scale 1:100

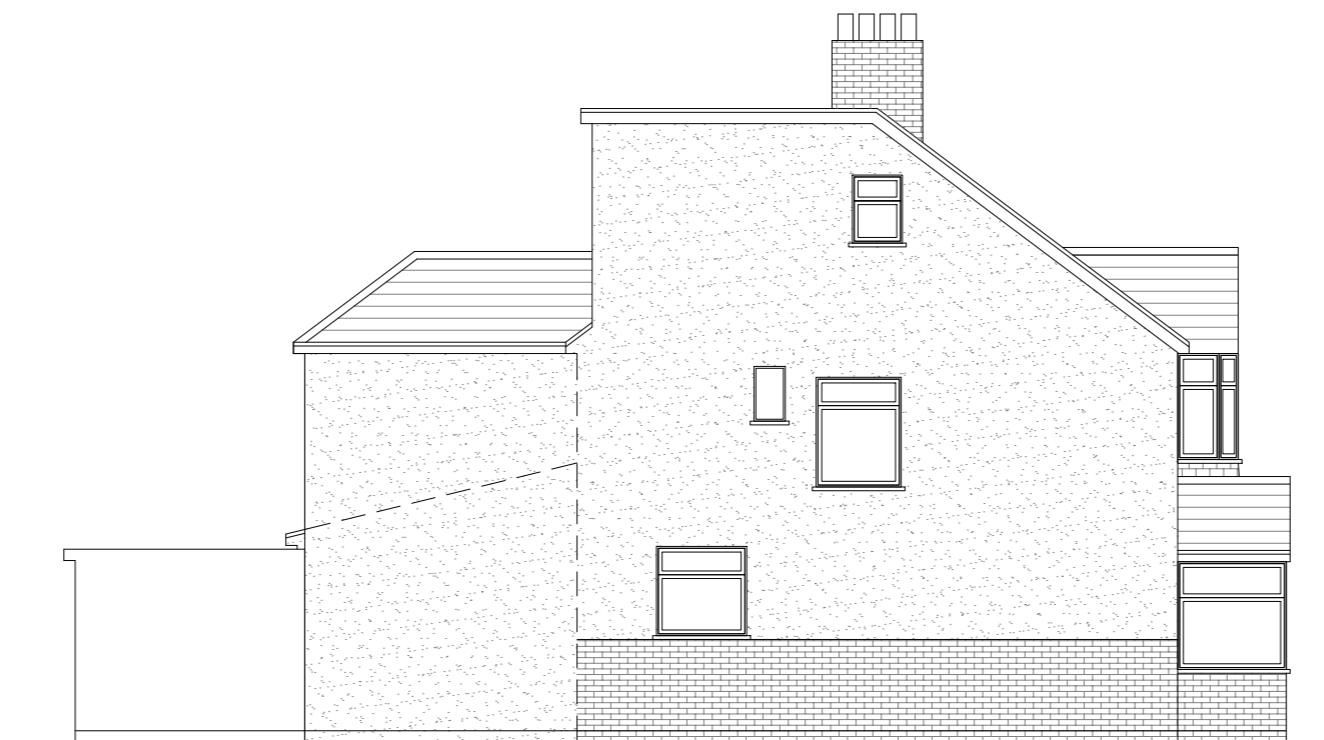

Proposed Side Elevation

Scale 1:100

GENERAL NOTES:

1. ALL DIMENSIONS ARE IN MILLIMETER.
2. VERIFY ALL DIMENSIONS AND CONDITIONS BEFORE BUILDING OR STARTING CONSTRUCTION. NOTIFY THE DESIGNER IMMEDIATELY OF ANY DISCREPANCY OR VARIATION.
3. ALL WORK TO COMPLY WITH CURRENT BUILDING REGULATIONS AND CODES OF PRACTICE

Title:

Proposed Elevations

Site Address
29 Cranborne Way,
Hayes.
UB4 0HW

Scale: 1:100 @A3
Date: 29/08/2023
Drawing No.:
2023/021 - 04HH
Drawn By:
RO

Revision Date:

e:mail -
faluckpatel@yahoo.com
(M) +44 (0) 7871 466 254

10 Meter
5
2
1
0
1:100

**Faluck
Patel**