



Notes

All new work shown shaded or hatched

Demolition generally shown dotted

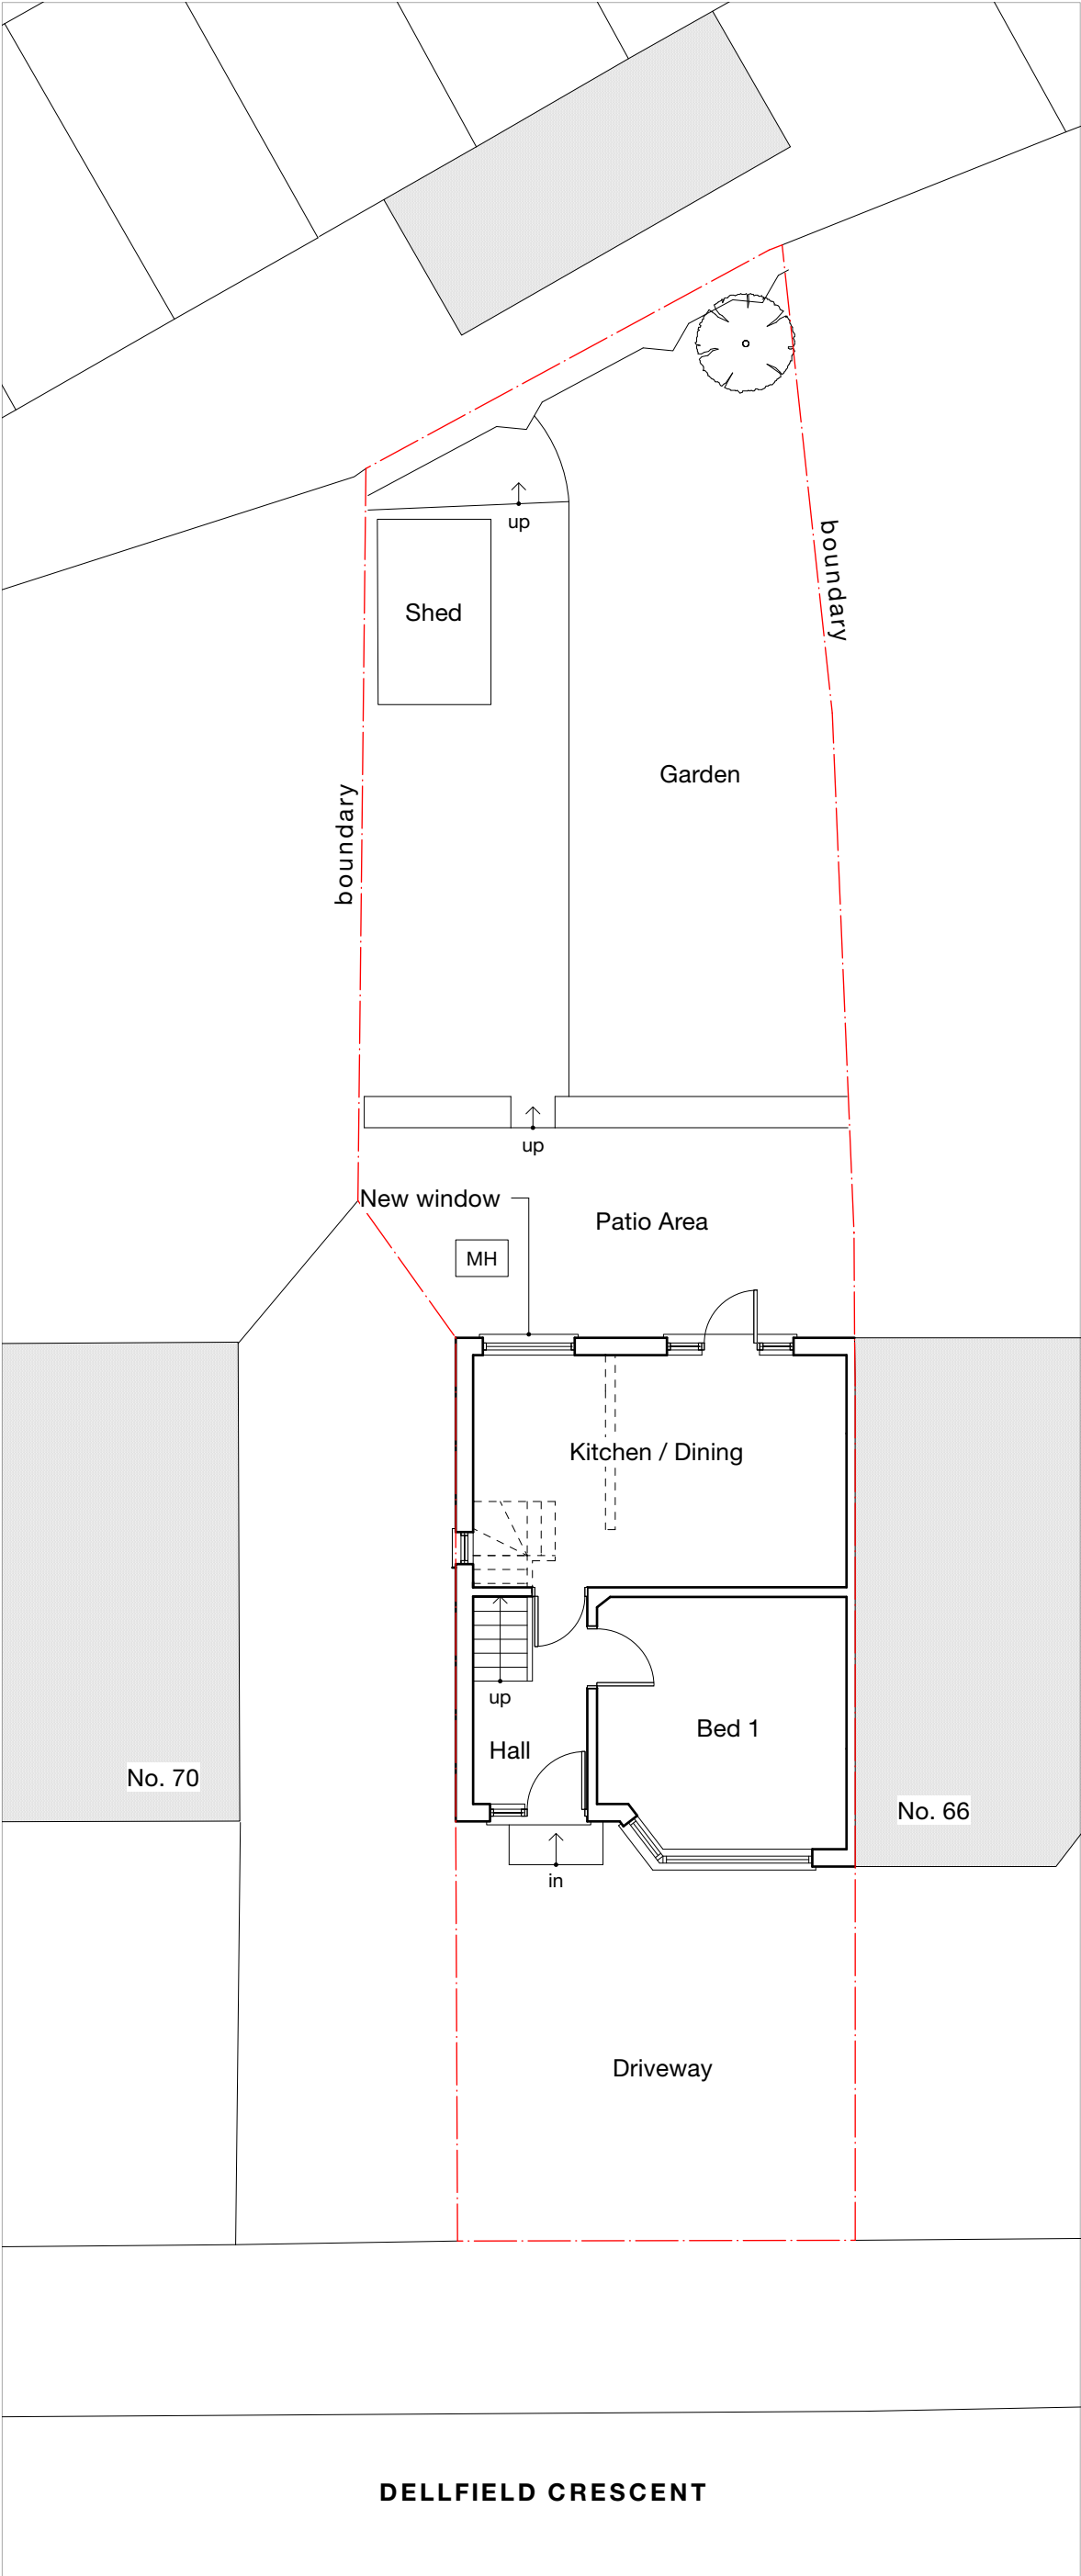

-	-	-	-
Revision notes			



client  
Navin Mahabeer

project  
68 Dellfield Crescent, Uxbridge UB8 2EU

drawing  
PROPOSED GROUND FLOOR

date  
June. 2023

work stage  
3

scale  
1:100 at A3

drawing no  
D01

project no  
2023.021


revision  
-

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PERMITTED DEVELOPMENT




Notes

All new work shown shaded or hatched

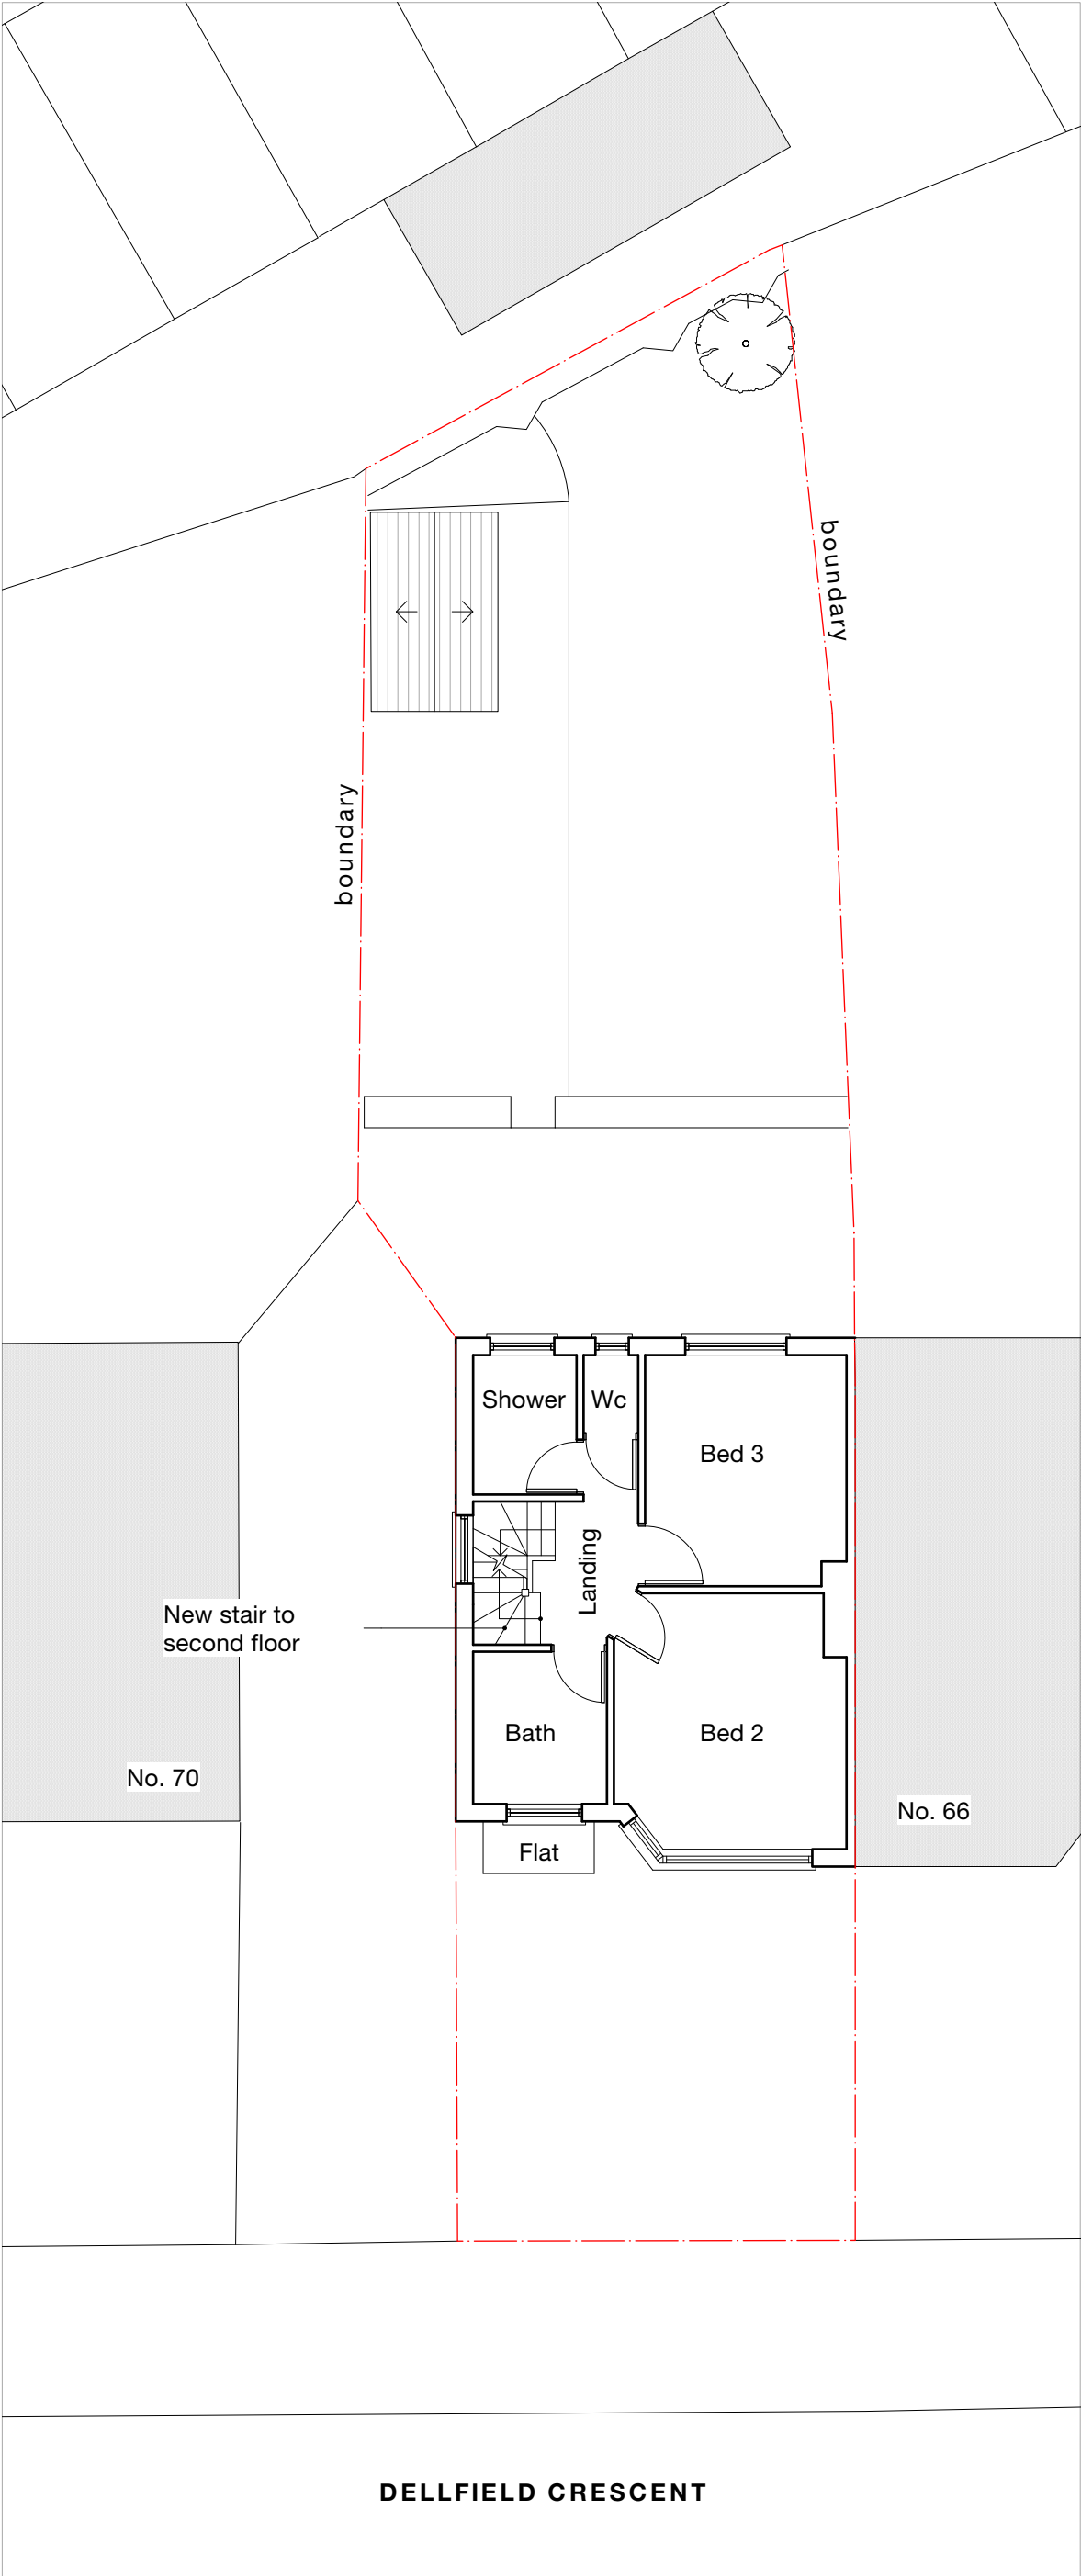Demolition generally shown dotted

-	-	-	-
Revision notes			



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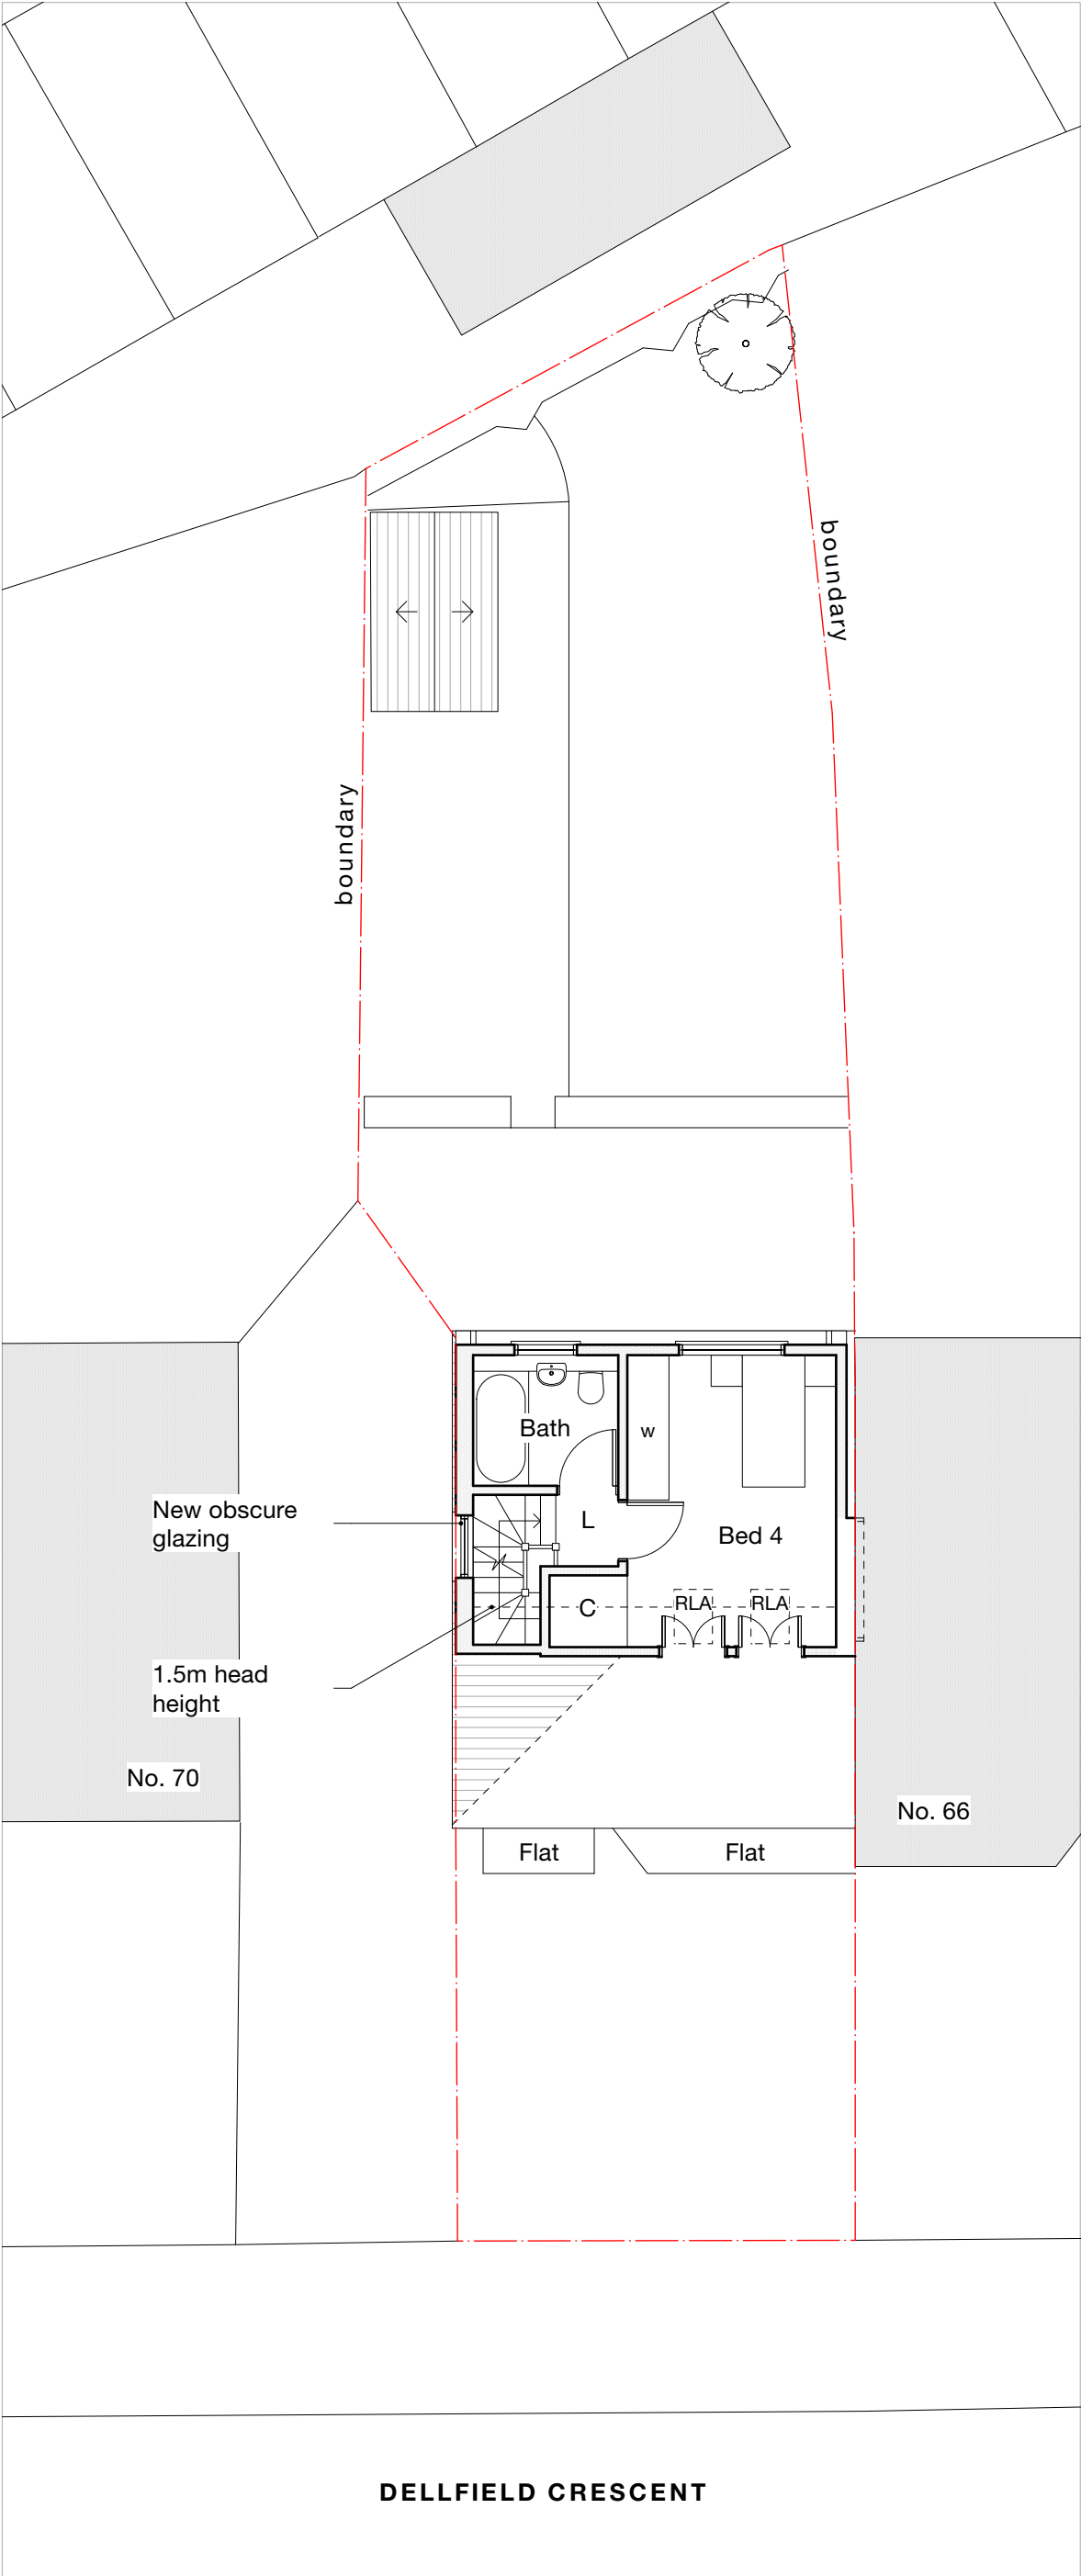
client  
Navin Mahabeer

project  
68 Dellfield Crescent, Uxbridge UB8 2EU

drawing  
PROPOSED FIRST FLOOR

date June. 2023	scale 1:100 at A3	project no 2023.021
work stage 3	drawing no D02	revision -

PERMITTED DEVELOPMENT



Notes

All new work shown shaded or hatched

Demolition generally shown dotted

- C Cupboard
- L Landing
- w wardrobe
- RLA Rooflight above
- RL Rooflight

New obscure glazing

1.5m head height


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
Flat

Flat

DELLFIELD CRESCENT



-	-	-	-
Revision notes			

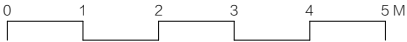

client  
Navin Mahabeer

project  
68 Dellfield Crescent, Uxbridge UB8 2EU

drawing  
PROPOSED SECOND FLOOR PLAN

date  
June. 2023

work stage  
3

scale  
1:100 at A3


drawing no  
D03

project no  
2023.021

revision  
-

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PERMITTED DEVELOPMENT

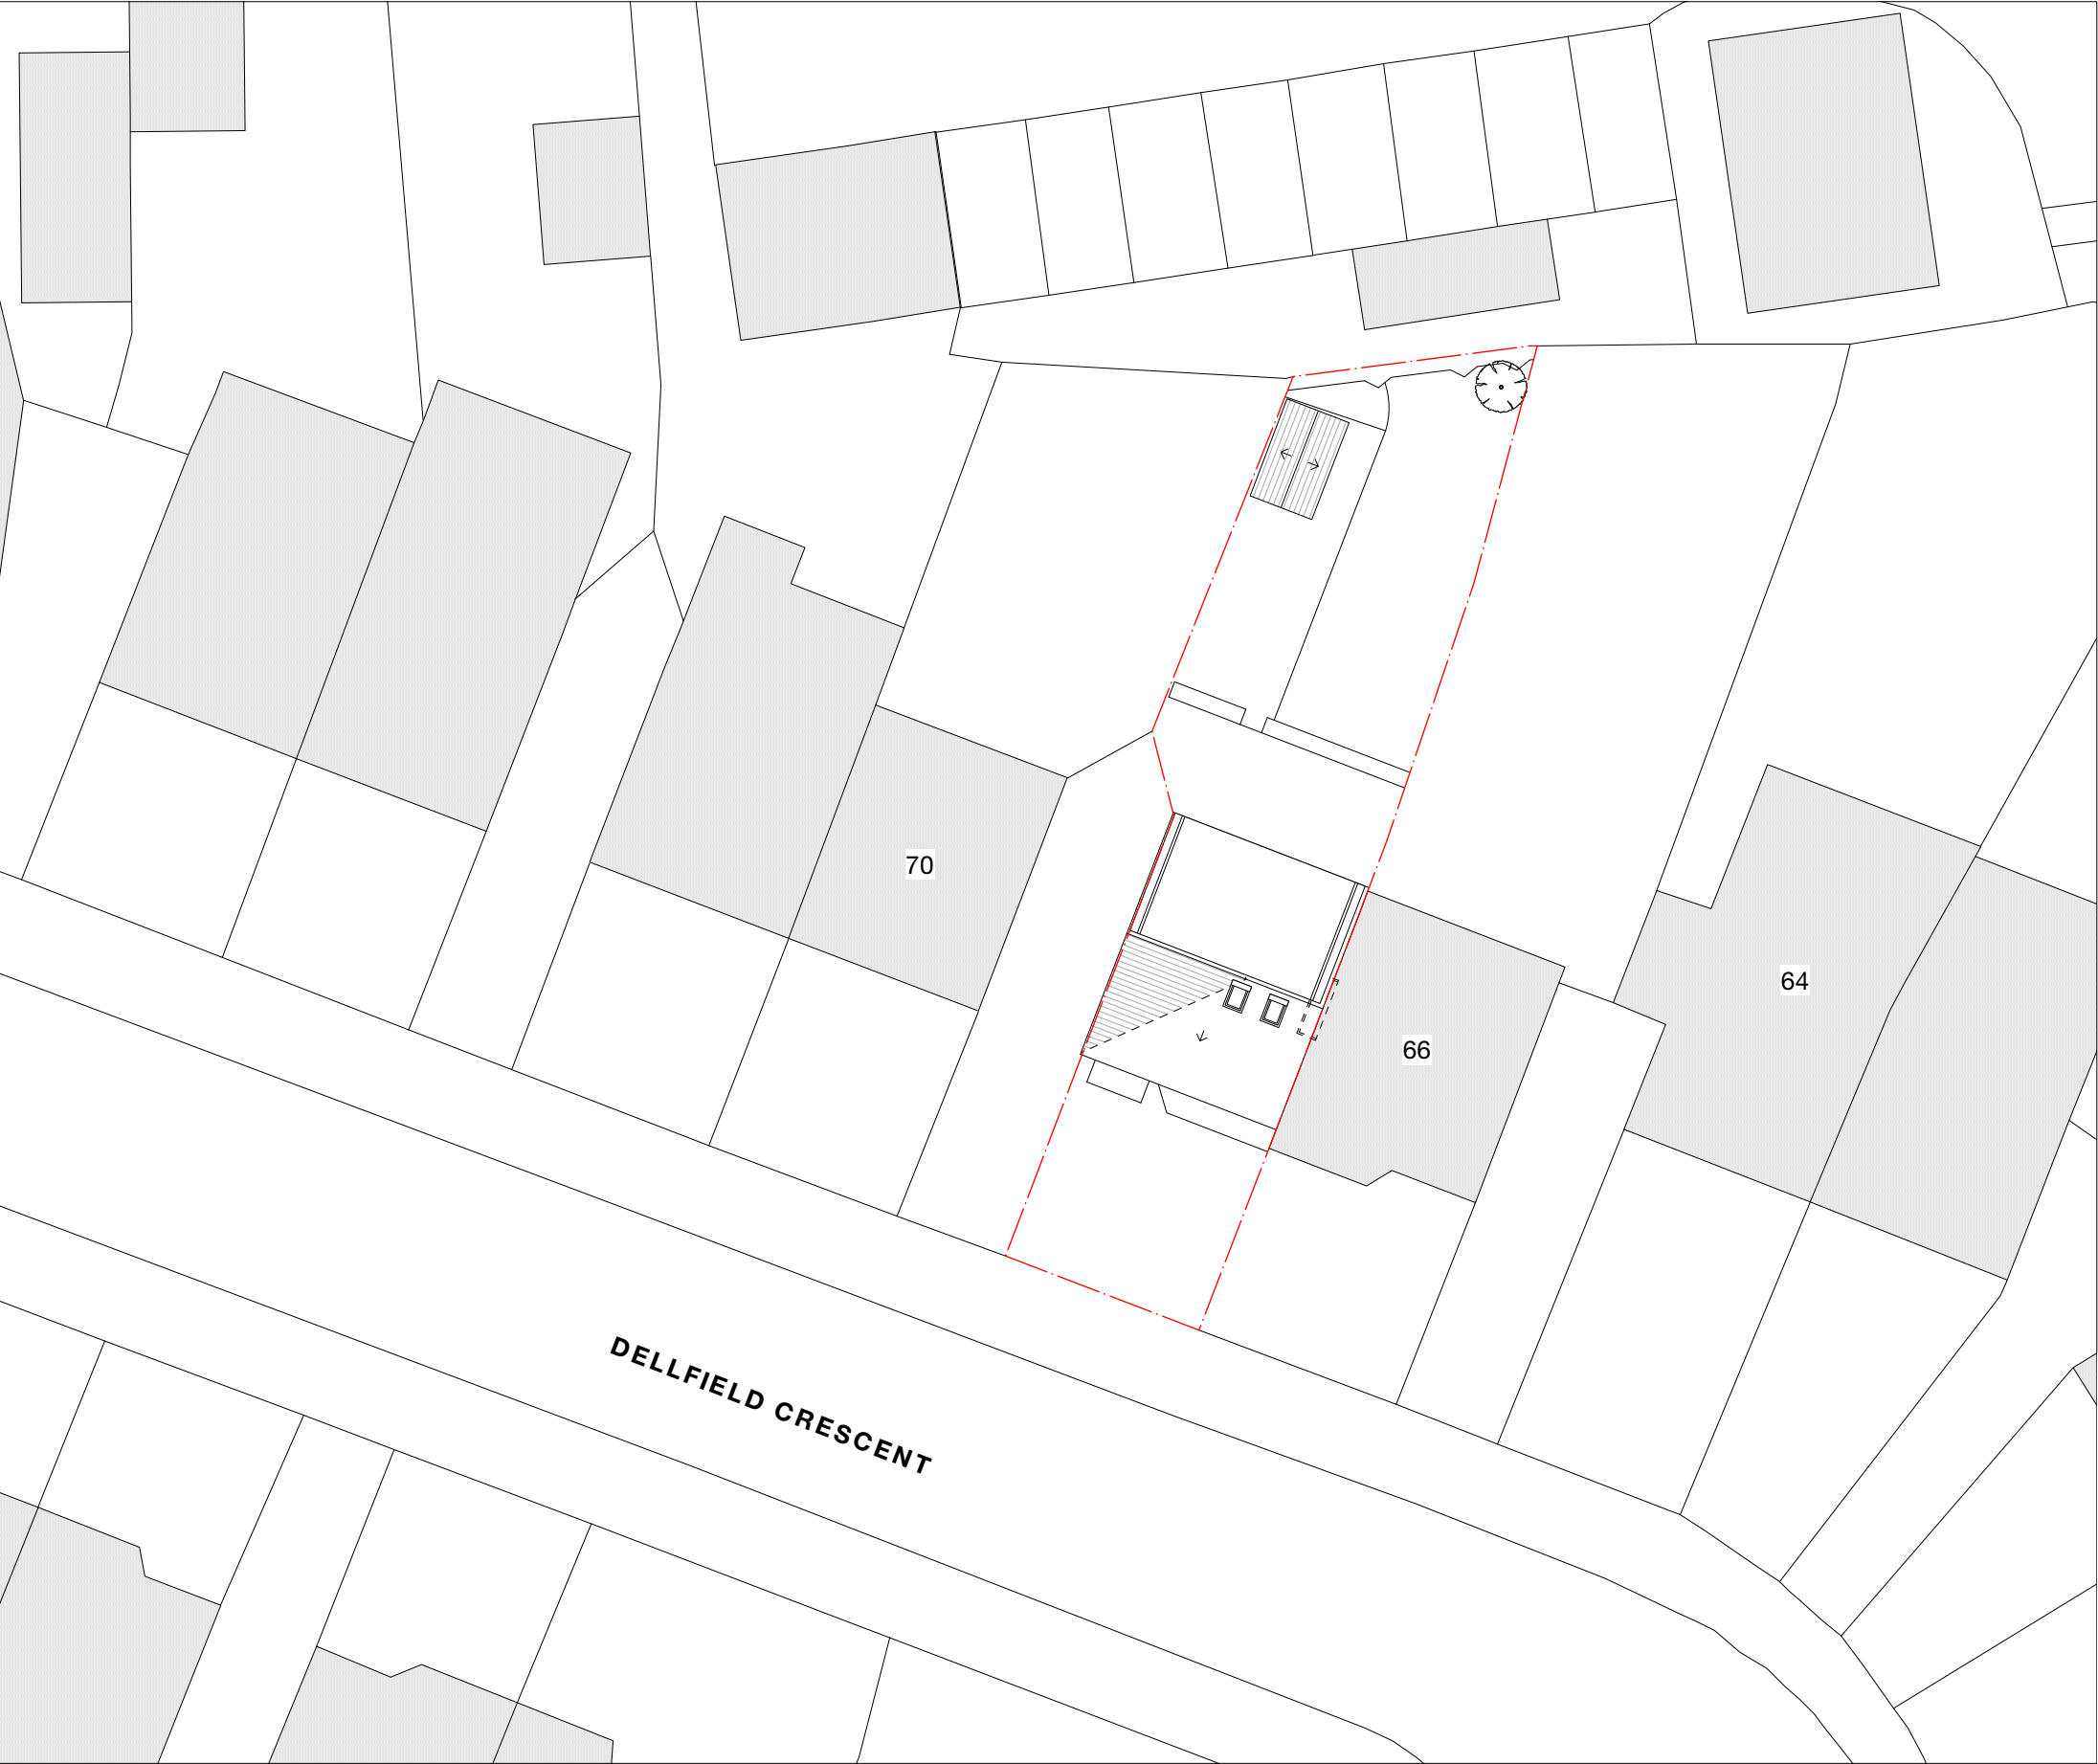


Notes

2no. new front rooflights - will not protrude more than 150mm from the front roof slope

-	-	-	-	-
Revision notes				

PERMITTED DEVELOPMENT



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Navin Mahabeer

project  
68 Dellfield Crescent, Uxbridge UB8 2EU

drawing  
PROPOSED SITE PLAN

date June. 2023	scale 1:200 at A3	project no <b>2023.021</b>
work stage <b>3</b>	drawing no <b>D04</b>	revision -

Notes

**HIP TO GABLE VOLUME CALCULATION=**  $\frac{1}{3}Bh$   
B= surface area of hip:  $\frac{1}{2}(7 \times 4.7) = 16.45\text{m}^2$   
h= height of pyramid from centre point of B: 2.3m


volume:  $\frac{1}{3}(16.45 \times 2.3) = \mathbf{12.61\text{m}^3}$

**DORMER VOLUME CALCULATION=**  $\frac{1}{2}(bh)l$   
b= 3.3m  
h= 2.8m  
l = 5.6m  
volume =  $\frac{1}{2}(3.3 \times 2.8)5.6 = \mathbf{25.87\text{m}^3}$

**TOTAL PROPOSED VOLUME:**  
 $12.61 + 25.87 = \mathbf{38.48\text{m}^3}$

PERMITTED DEVELOPMENT

A	18/07/23	GC	Amendments as per officer (B Smith) email dated 18/07/23
Revision notes			



MASONWOOD  
DESIGN


client  
Navin Mahabeer

project  
68 Dellfield Crescent, Uxbridge UB8 2EU

drawing  
PROPOSED ELEVATIONS

date June. 2023	scale 1:100 at A3	project no <b>2023.021</b>
work stage <b>3</b>	drawing no <b>D05</b>	revision <b>A</b>

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Notes

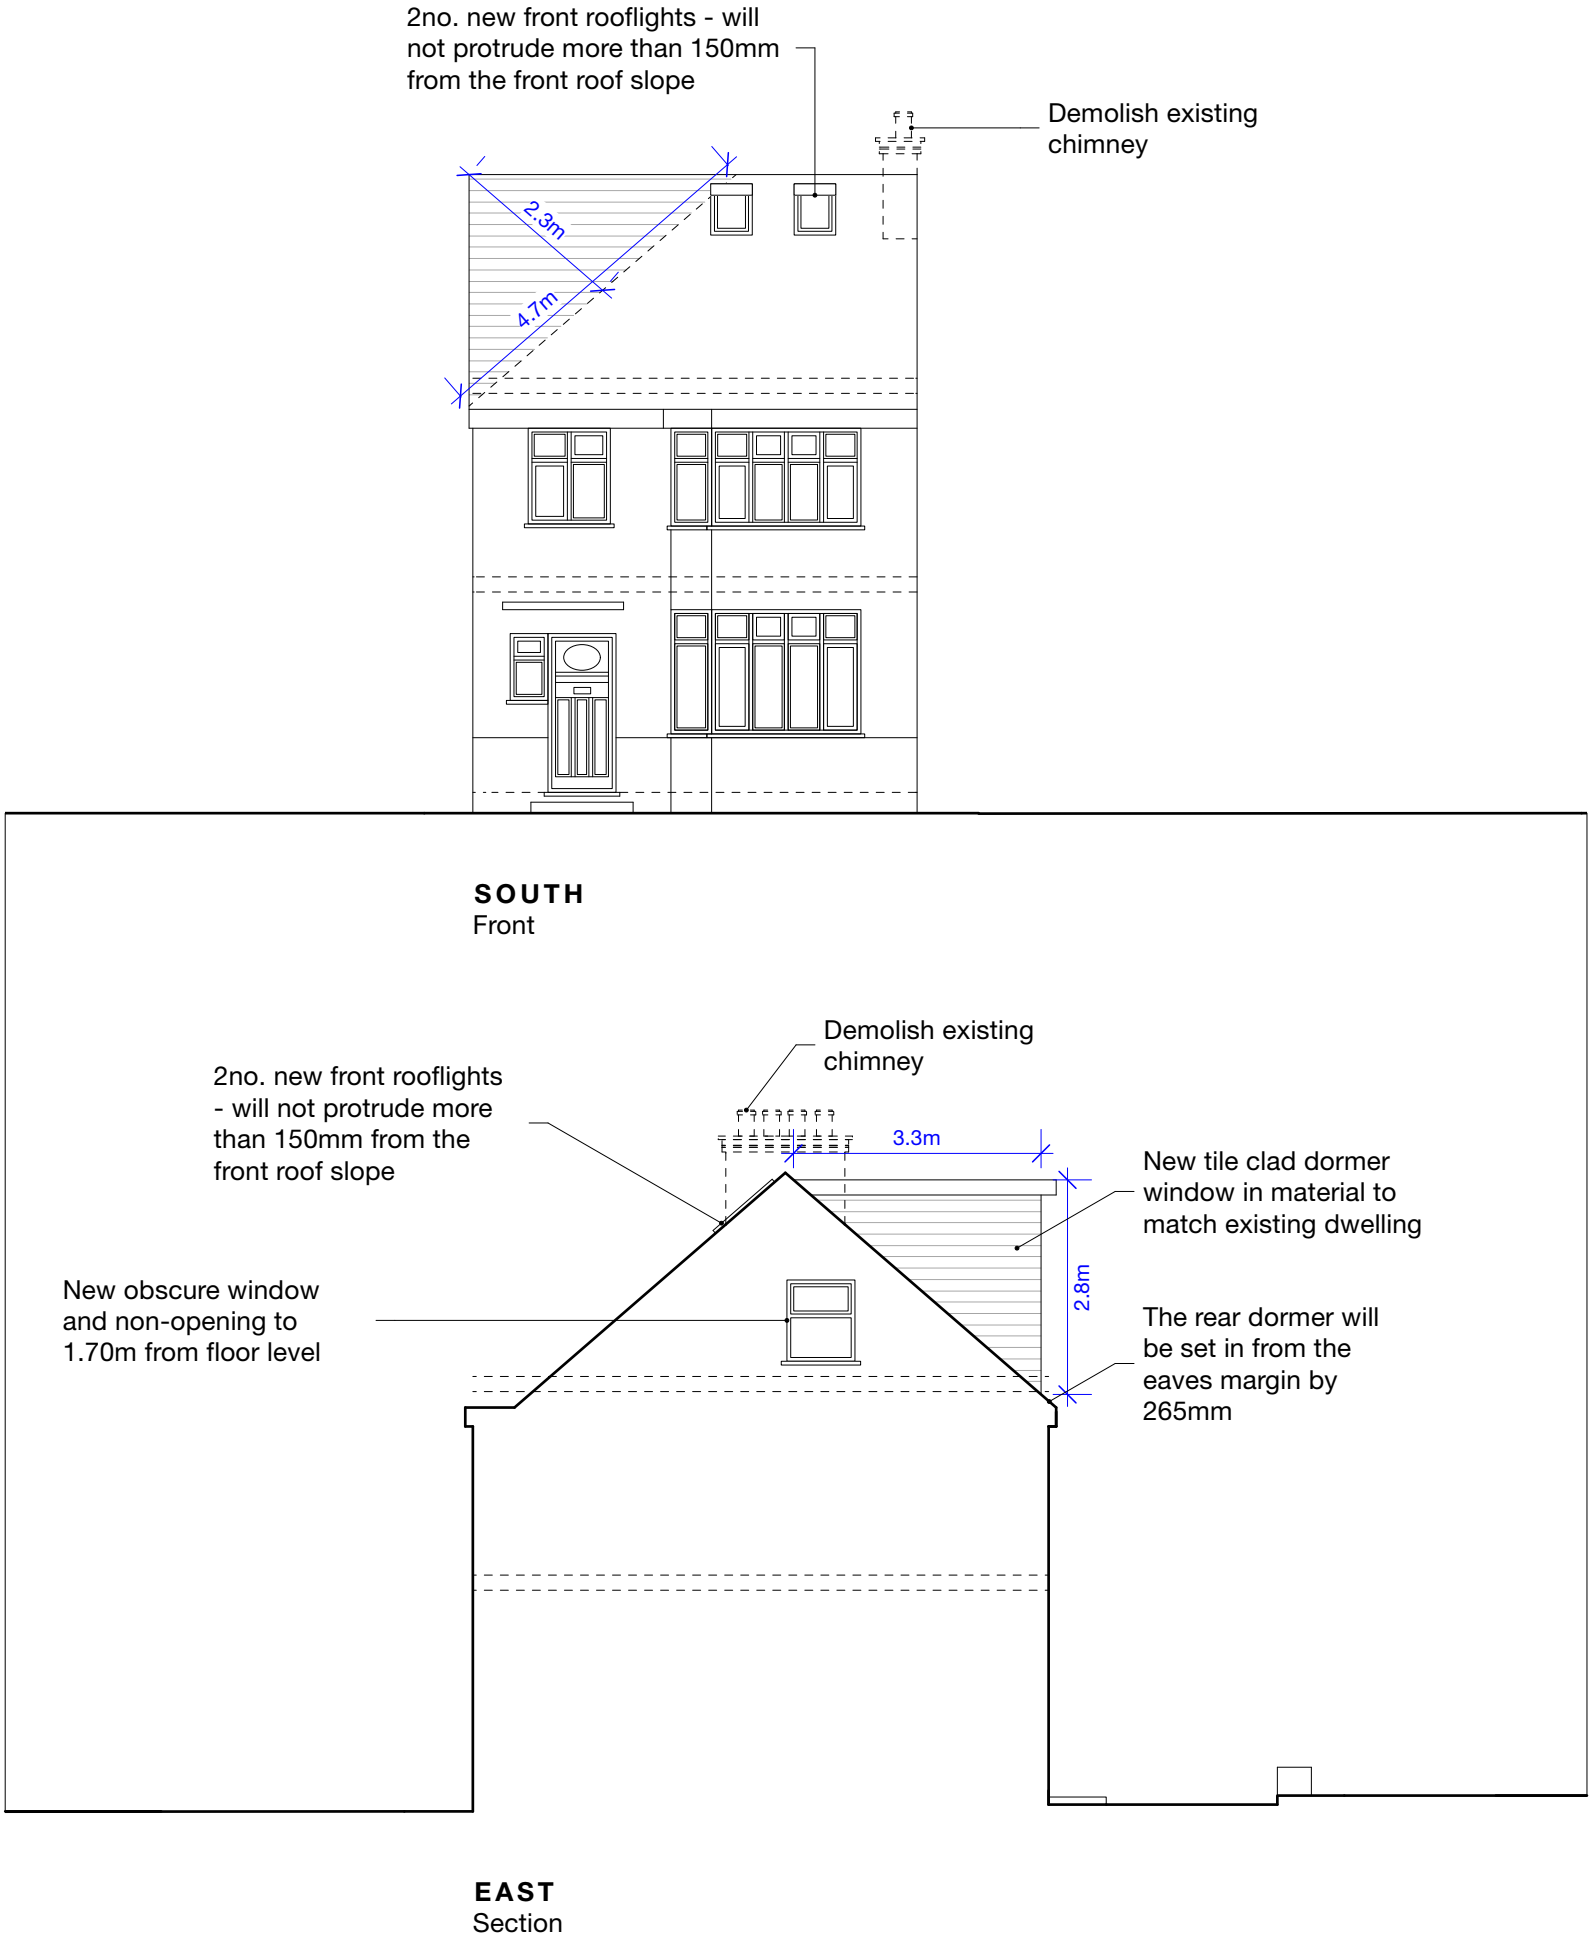
**HIP TO GABLE VOLUME CALCULATION=**  $\frac{1}{3}Bh$   
B= surface area of hip:  $\frac{1}{2}(7 \times 4.7) = 16.45\text{m}^2$   
h= height of pyramid from centre point of B: 2.3m

volume:  $\frac{1}{3}(16.45 \times 2.3) = \mathbf{12.61\text{m}^3}$

**DORMER VOLUME CALCULATION=**  $\frac{1}{2}(bh)l$   
b= 3.3m  
h= 2.8m  
l = 5.6m  
volume =  $\frac{1}{2}(3.3 \times 2.8)5.6 = \mathbf{25.87\text{m}^3}$

**TOTAL PROPOSED VOLUME:**  
 $12.61 + 25.87 = \mathbf{38.48\text{m}^3}$

A	18/07/23	GC	Amendments as per officer (B Smith) email dated 18/07/23
Revision notes			



MASONWOOD  
DESIGN

client  
Navin Mahabeer

project  
68 Dellfield Crescent, Uxbridge UB8 2EU


drawing  
PROPOSED ELEVATIONS

date June. 2023	scale 1:100 at A3	project no <b>2023.021</b>
work stage <b>3</b>	drawing no <b>D06</b>	revision <b>A</b>

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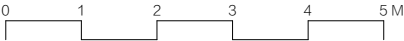



PERMITTED DEVELOPMENT

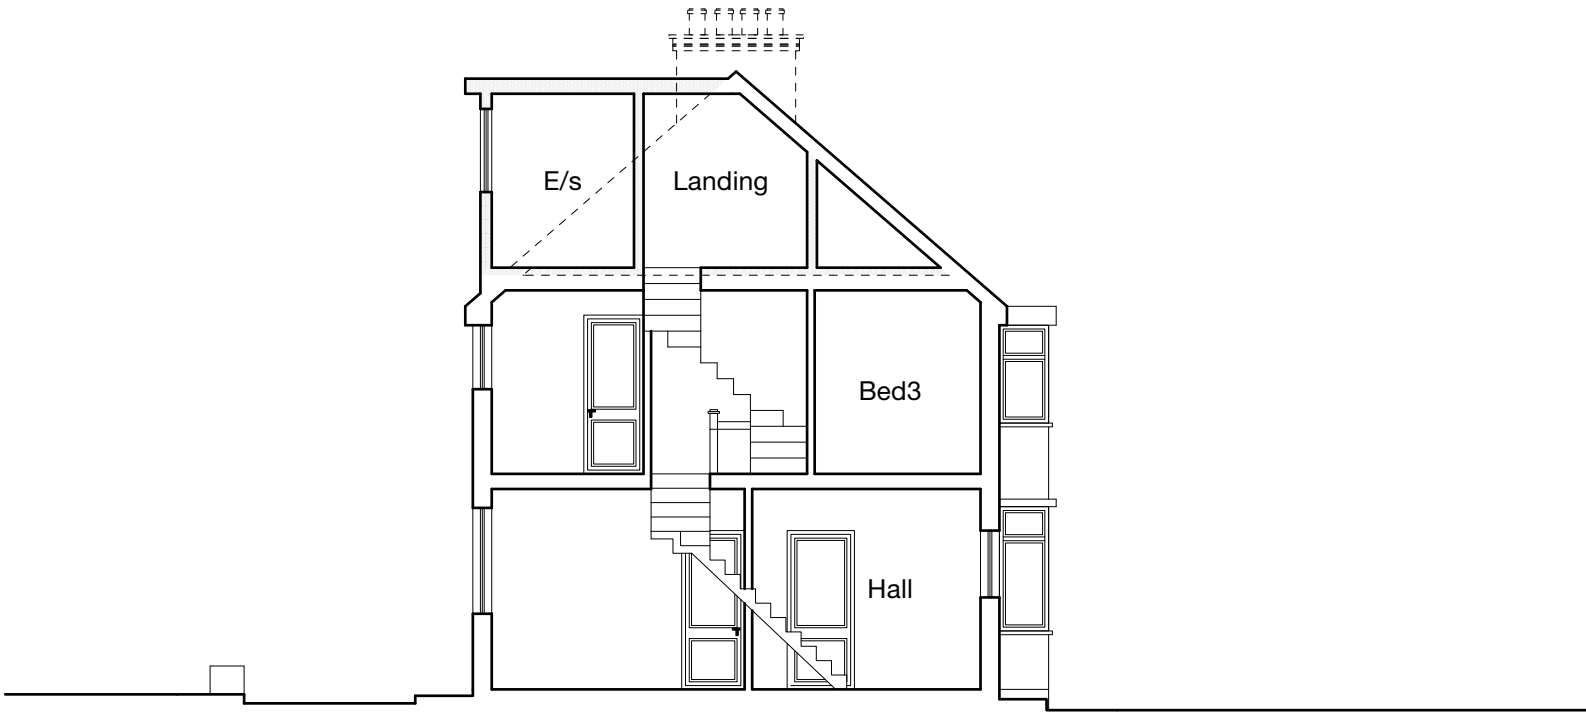

WEST  
Section

A	18/07/23	GC	Amendments as per officer (B Smith) email dated 18/07/23
Revision notes			





MASONWOOD  
DESIGN

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client  
Navin Mahabeer

drawing  
PROPOSED ELEVATIONS

date June. 2023	scale 1:100 at A3	project no <b>2023.021</b>
work stage <b>3</b>	drawing no <b>D07</b>	revision <b>A</b>

PERMITTED DEVELOPMENT