


**Proposed First Floor Plan**  
Scale 1:50



**Proposed Loft Floor Plan**  
Scale 1:50

Velux Window to be installed as per manufacturer specification, not projected more than 150mm from the plane of roof slope

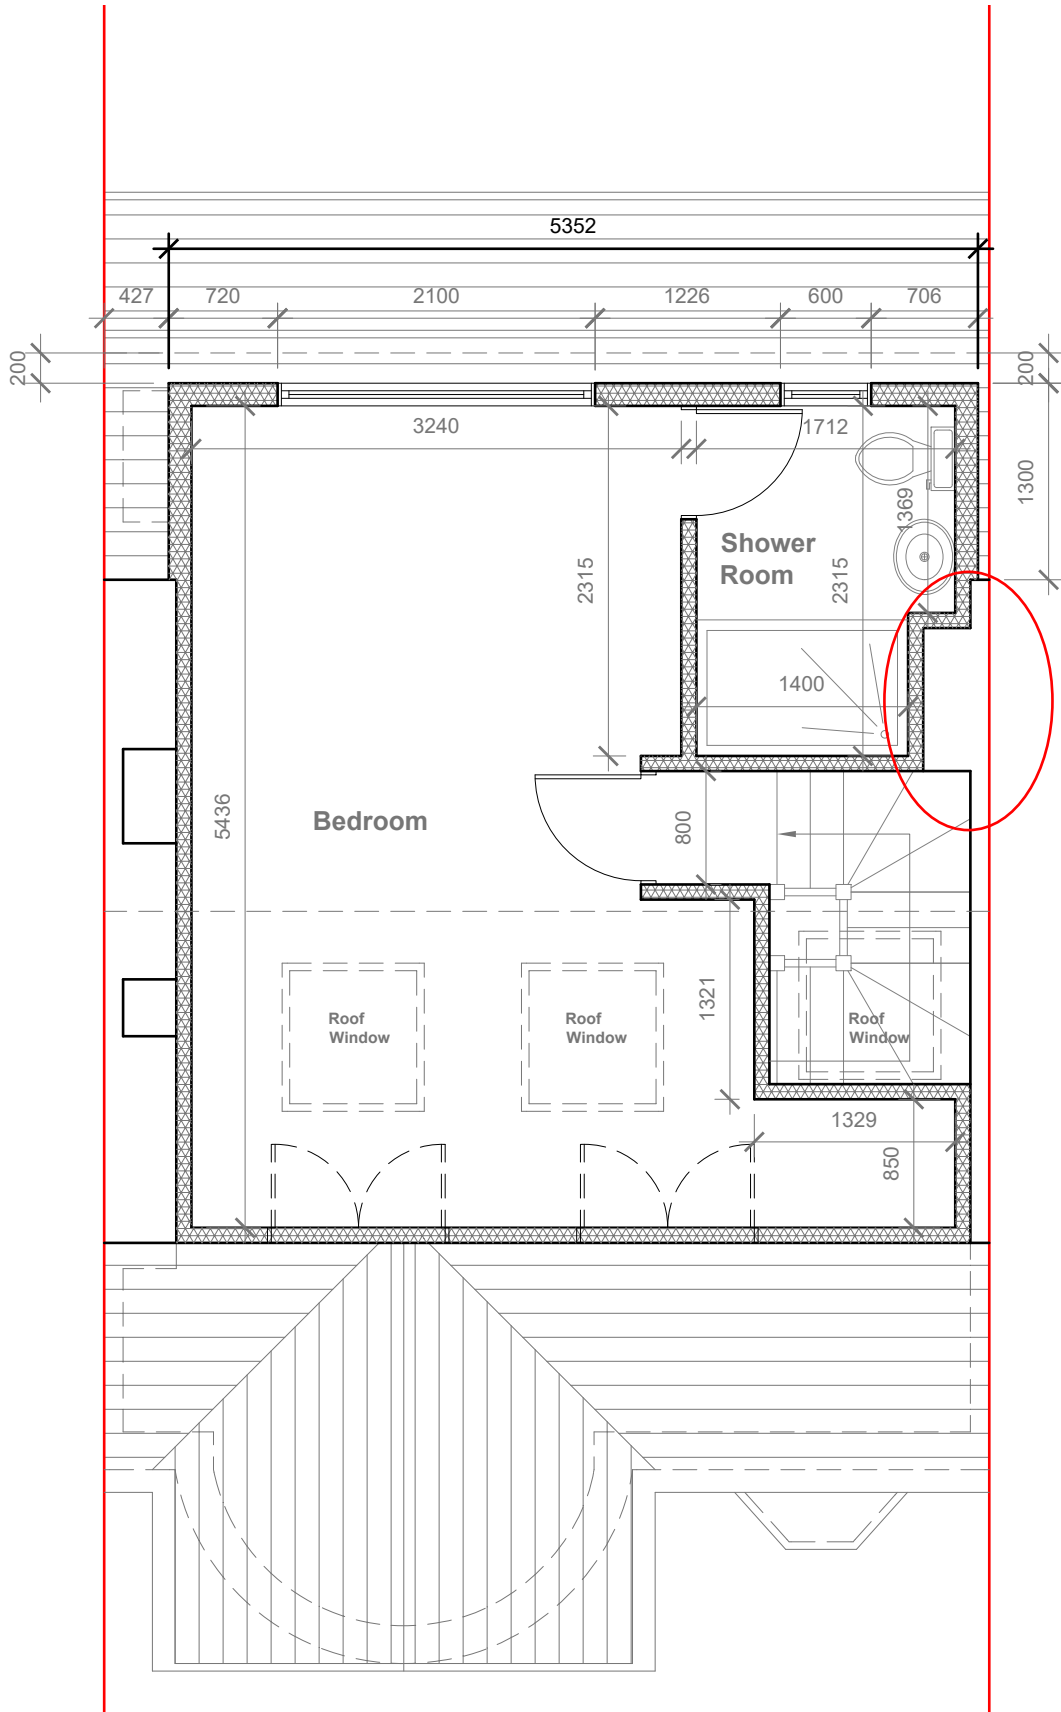

GENERAL NOTES:  
1. ALL DIMENSIONS ARE IN MILLIMETER.  
2. VERIFY ALL DIMENSIONS AND CONDITIONS BEFORE BUILDING OR STARTING CONSTRUCTION. NOTIFY THE DESIGNER IMMEDIATELY OF ANY DISCREPANCY OR VARIATION.  
3. ALL WORK TO COMPLY WITH CURRENT BUILDING REGULATIONS AND CODES OF PRACTICE

Title:

**Proposed First Floor & Loft Plans**

Site Address  
177 West End Road,  
Ruislip.  
HA4 6LB


Scale: 1:50 @A3  
Date: 05/04/2023  
Drawing No.: 2023/049 -03  
Drawn By: RO

Revision Date:  
e:mail - faluckpatel@yahoo.com  
(M) +44 (0) 7871 466 254

**Faluck Patel**



**Proposed Front Elevation**  
Scale 1:100

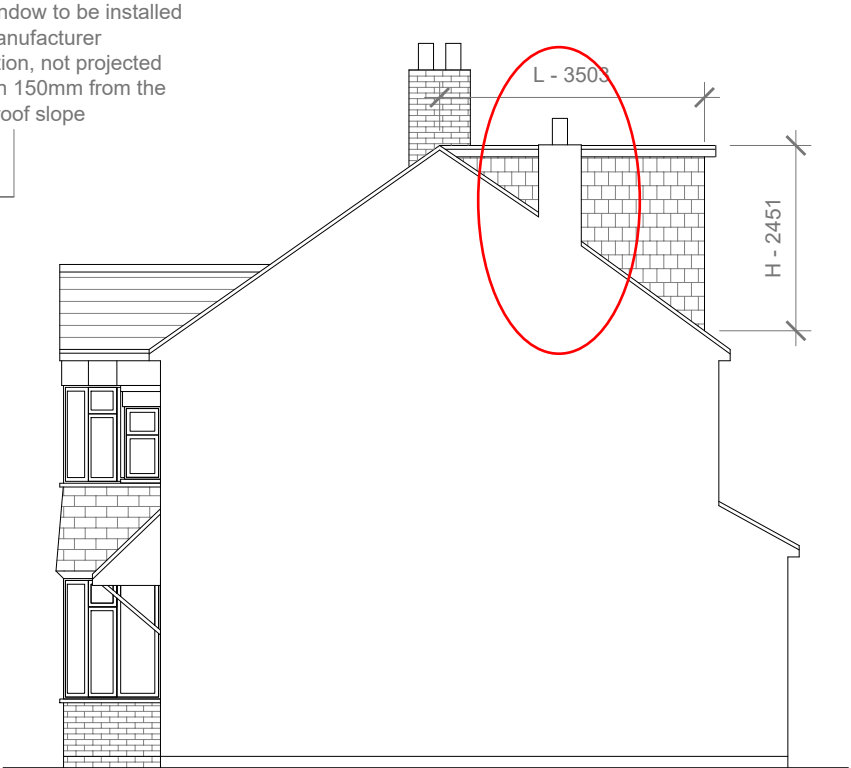

**Proposed Side Elevation**  
Scale 1:100


REAR DORMER VOLUME =

$$W \times H \times L / 2$$
$$5.352 \times 2.451 \times 3.503 / 2$$
$$45.95 / 2$$
$$22.97 \text{ CU.MT.}$$

V1 =

TOTAL ROOF VOLUME =

$$V1$$
$$22.06$$
$$22.06 \text{ CU.MT.} < 40.00 \text{ CU.MT}$$

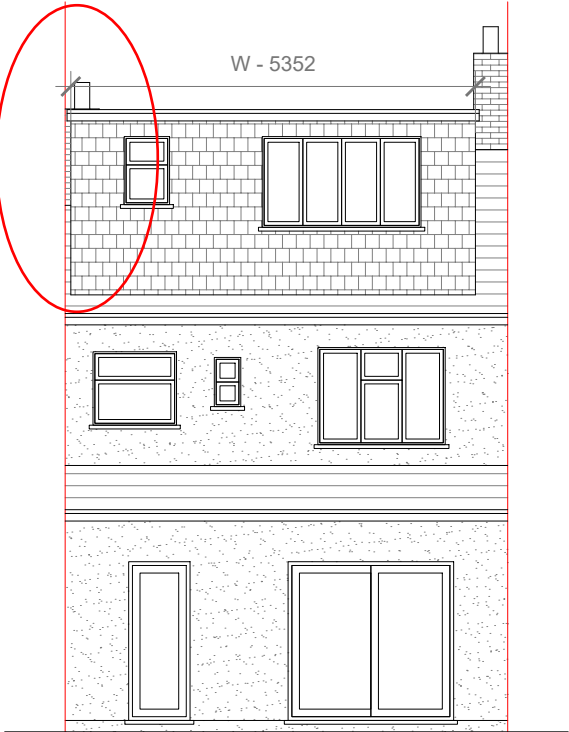

**Proposed Rear Elevation**  
Scale 1:100



**Proposed Side Elevation**  
Scale 1:100



GENERAL NOTES:  
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3. ALL WORK TO COMPLY WITH CURRENT BUILDING REGULATIONS AND CODES OF PRACTICE

Title:  
**Proposed Elevations**

Site Address  
177 West End Road,  
Ruislip.  
HA4 6LB

Scale: 1:100 @A3  
Date: 05/04/2023  
Drawing No.: 2023/049 -04  
Drawn By: RO

Revision Date:  
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