



Existing Ground Floor Plan
Scale 1:100

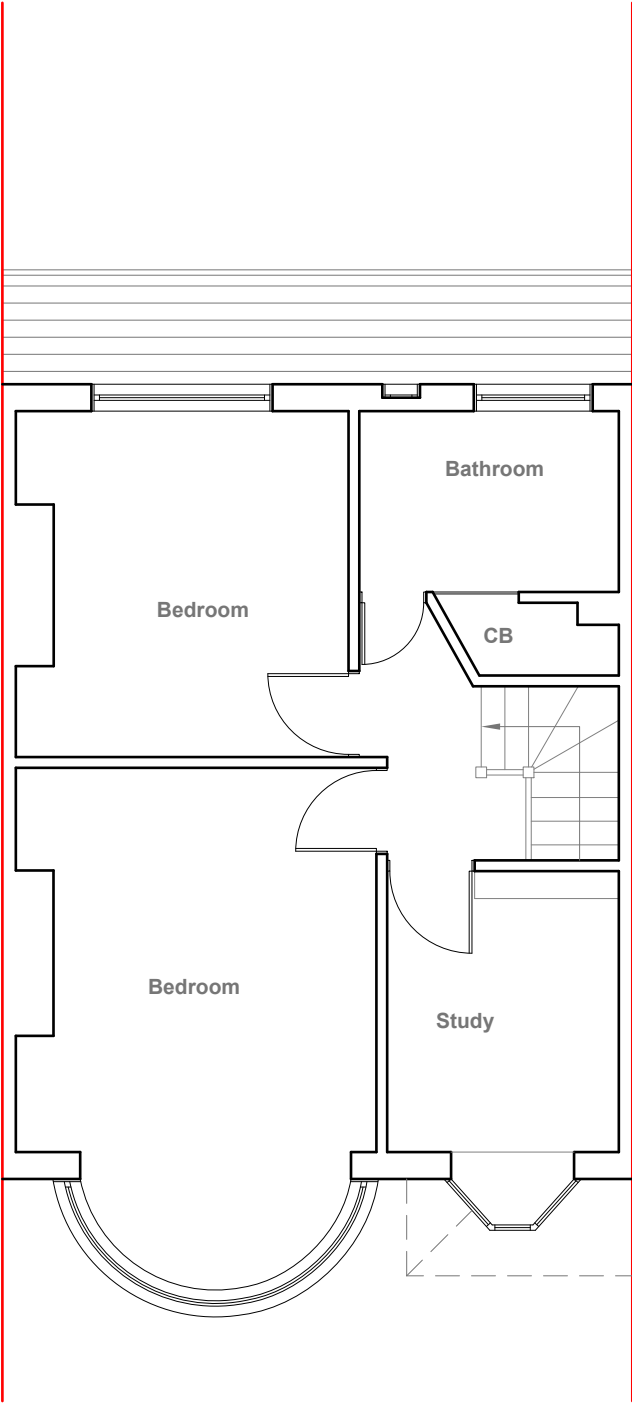

Existing First Floor Plan
Scale 1:100

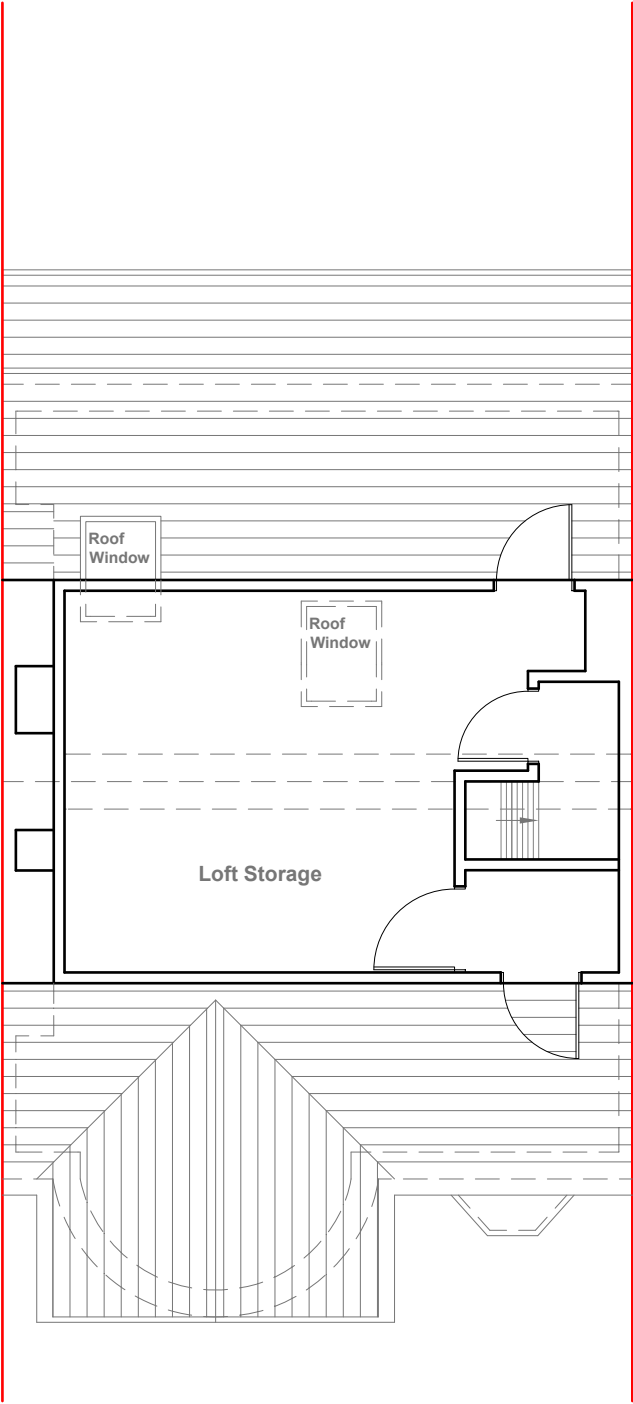

Existing Loft Floor Plan
Scale 1:100



GENERAL NOTES:
1. ALL DIMENSIONS ARE IN MILLIMETER.
2. VERIFY ALL DIMENSIONS AND CONDITIONS BEFORE BUILDING OR STARTING CONSTRUCTION. NOTIFY THE DESIGNER IMMEDIATELY OF ANY DISCREPANCY OR VARIATION.
3. ALL WORK TO COMPLY WITH CURRENT BUILDING REGULATIONS AND CODES OF PRACTICE

Title:

Existing Floor Plans

Site Address
177 West End Road,
Ruislip.
HA4 6LB

Scale: 1:100 @A3
Date: 05/04/2023
Drawing No.: 2023/049 -01
Drawn By: RO

Revision Date:
e:mail - faluckpatel@yahoo.com
(M) +44 (0) 7871 466 254





Existing Front Elevation
Scale 1:100



Existing Side Elevation
Scale 1:100



Existing Rear Elevation
Scale 1:100



Existing Side Elevation
Scale 1:100



GENERAL NOTES:
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3. ALL WORK TO COMPLY WITH CURRENT BUILDING REGULATIONS AND CODES OF PRACTICE

Title:


Existing Elevations

Site Address
177 West End Road,
Ruislip.
HA4 6LB


Scale: 1:100 @A3
Date: 05/04/2023
Drawing No.:
2023/049 -02
Drawn By:
RO

Revision Date:
e:mail -
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Proposed First Floor Plan
Scale 1:50

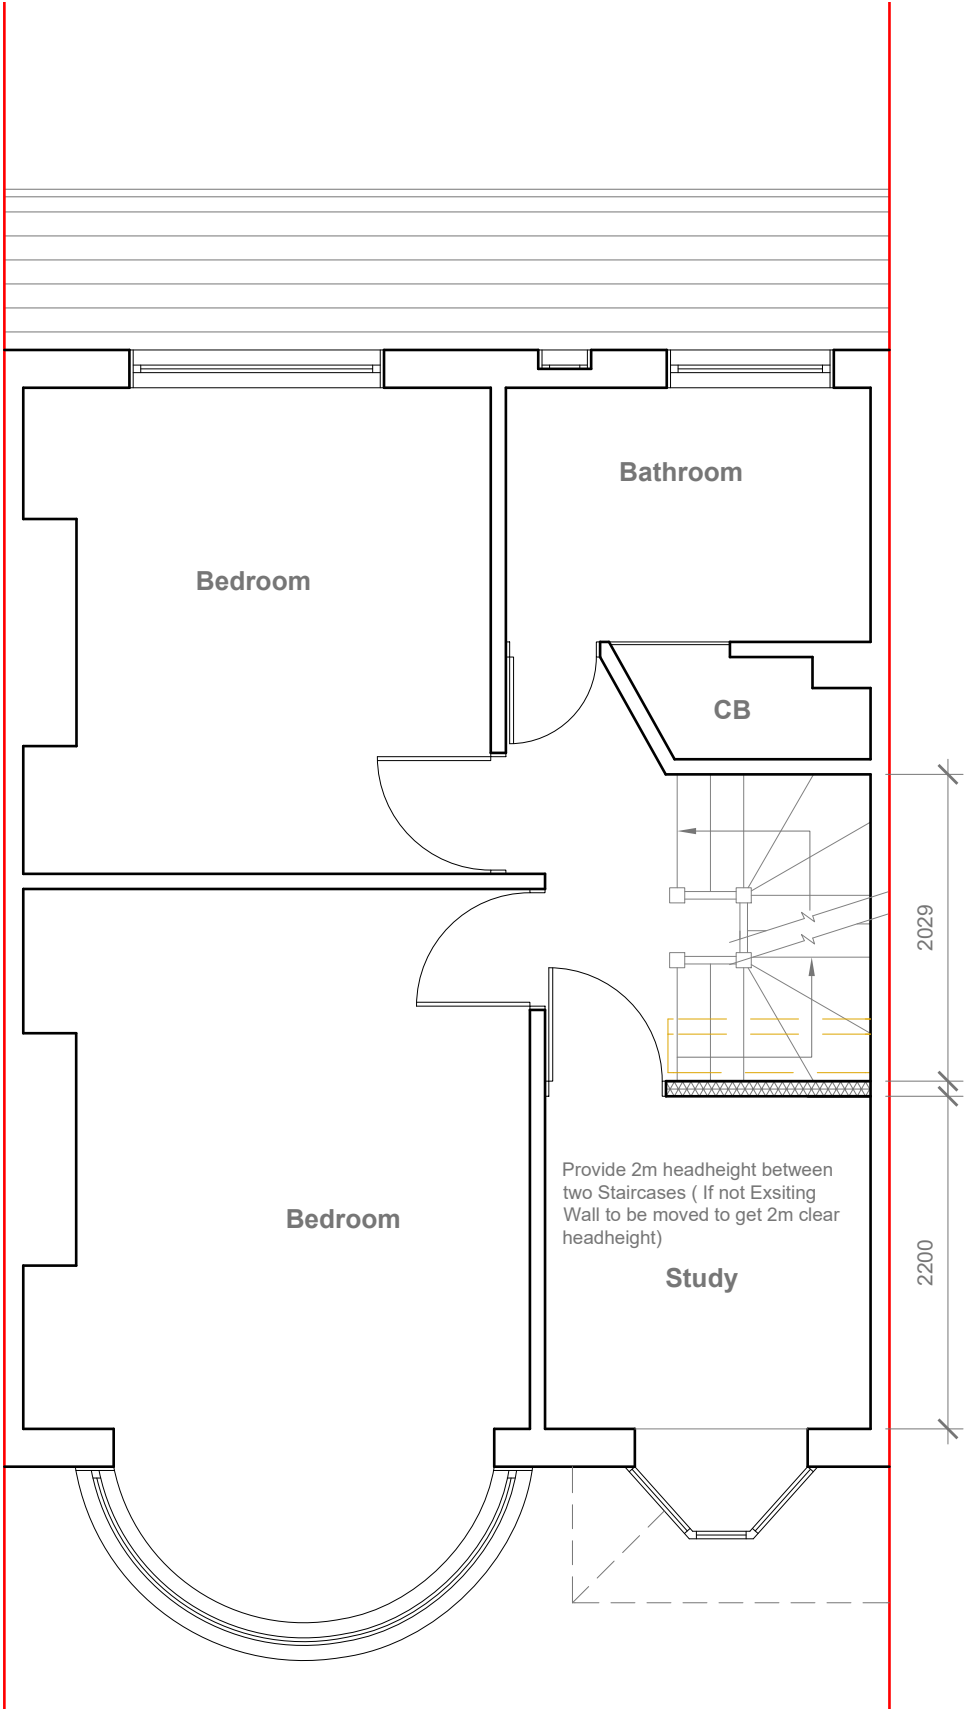

Proposed Loft Floor Plan
Scale 1:50

Velux Window to be installed as per manufacturer specification, not projected more than 150mm from the plane of roof slope

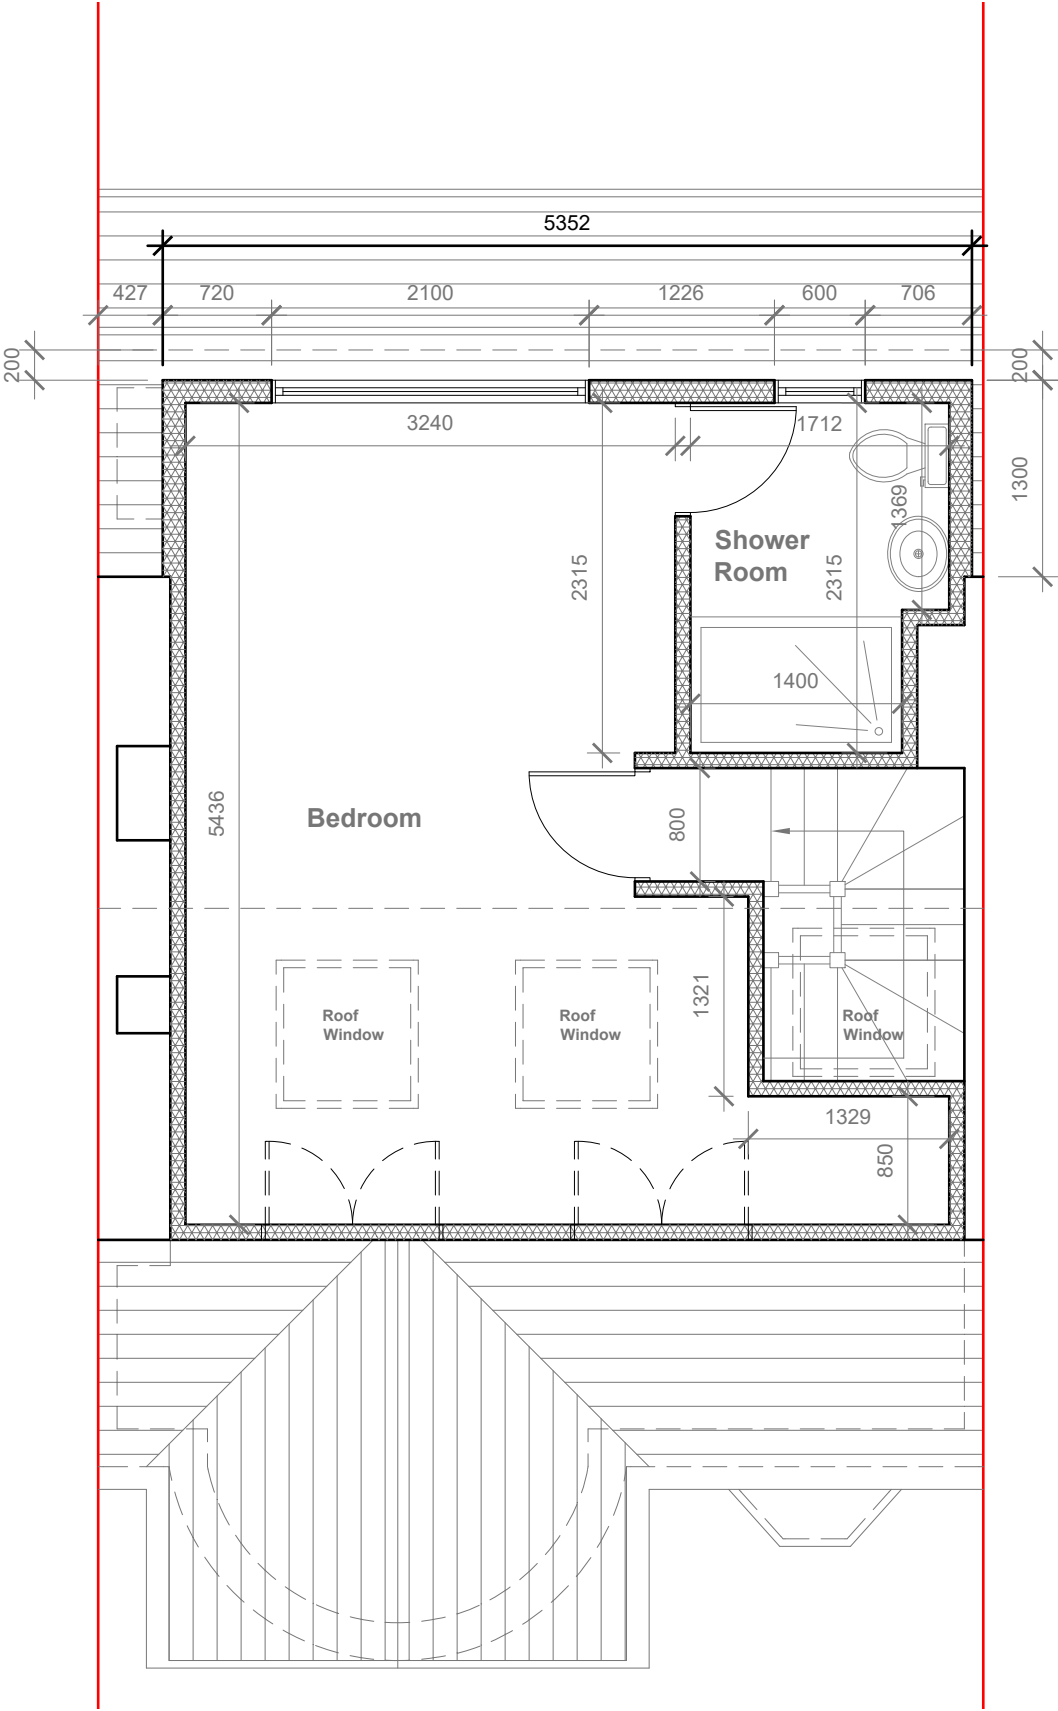

- GENERAL NOTES:
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 - 3. ALL WORK TO COMPLY WITH CURRENT BUILDING REGULATIONS AND CODES OF PRACTICE

Title:

Proposed First Floor & Loft Plans

Site Address
177 West End Road,
Ruislip.
HA4 6LB

Scale: 1:50 @A3
Date: 05/04/2023
Drawing No.: 2023/049 -03
Drawn By: RO

Revision Date:


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Proposed External Finish
Materials to Match Existing
External Finish Materials



Proposed Front Elevation
Scale 1:100



Proposed Side Elevation
Scale 1:100

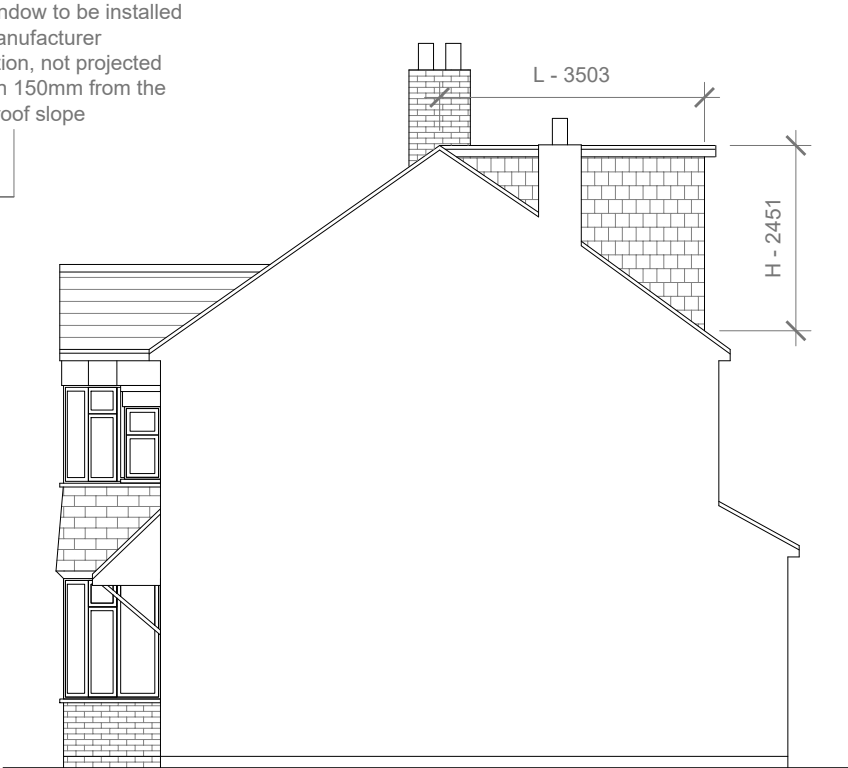REAR DORMER VOLUME =

$$W \times H \times L / 2$$
$$5.352 \times 2.451 \times 3.503 / 2$$
$$45.95 / 2$$
$$22.97 \text{ CU.MT.}$$

V1 =

TOTAL ROOF VOLUME =

$$V1$$
$$22.06$$
$$22.06 \text{ CU.MT.} < 40.00 \text{ CU.MT}$$



Proposed Rear Elevation
Scale 1:100



Proposed Side Elevation
Scale 1:100



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3. ALL WORK TO COMPLY WITH CURRENT BUILDING REGULATIONS AND CODES OF PRACTICE

Title:

Proposed Elevations

Site Address
177 West End Road,
Ruislip.
HA4 6LB

Scale: 1:100 @A3
Date: 05/04/2023
Drawing No.: 2023/049 -04
Drawn By: RO

Revision Date:

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