



EXISTING BLOCK / ROOF PLAN (SCALE 1:200)

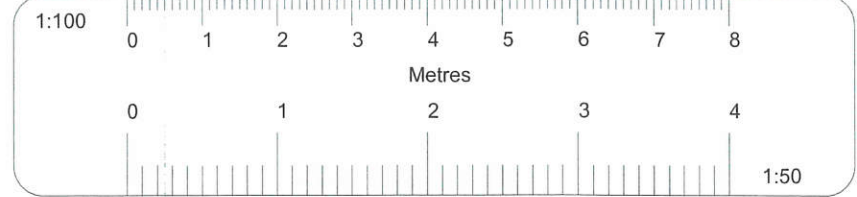


All dimensions verified on site.  
All work to comply with British Standards, Code of practice.  
All internal works to be in accordance with client instructions.  
All external surfaces to match existing.  
All work to be to the satisfaction of the local authority-building surveyor.  
Builder to serve building notice and comply fully in all respects.  
Owner responsible for compliance with 1.Party Wall etc Act 1996. 2. Thames water Build Over Agreement.  
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All proprietary materials to manufacturers recommendations  
Works to boiler/Gas to be carried out by Gas Safe registered installer and to Gas Safe recommendations

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The competent person is to send a self-certification certificate to the Local Authority Building Control Department within 30 days of completion of the electrical works. The client must receive both a copy of the self-certification certificate and a BS 7671:2001 (2004) Electrical Installation Test Certificate and forward copies to the Local Authority Building Control Dept.



- Upgrade doors to minimum 20mins. fire rated.
- Smoke detection provided through out complying with requirements of BS5839 part-6.

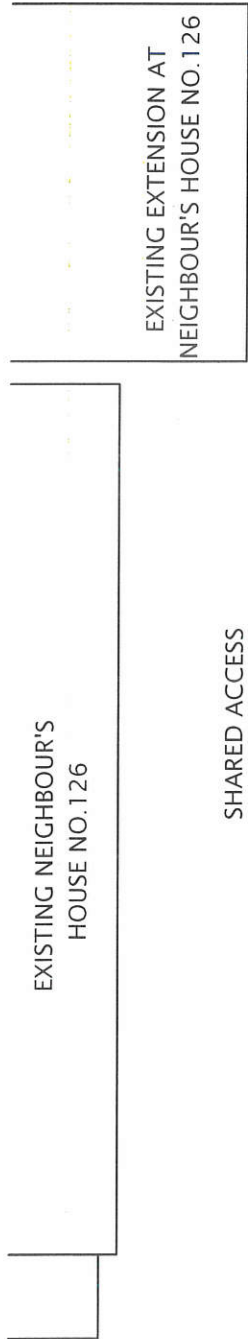

EXISTING GROUND FLOOR PLAN

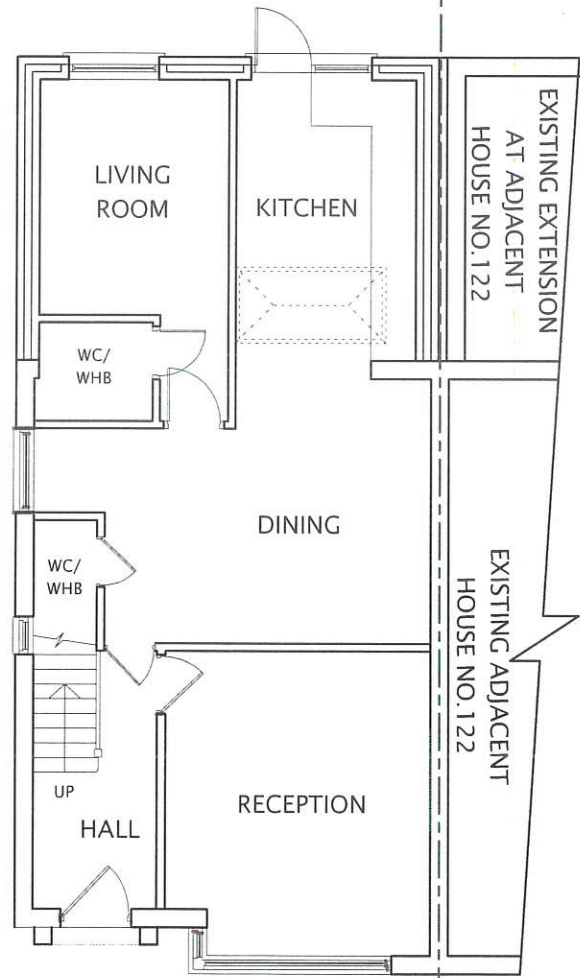



EXISTING FIRST FLOOR PLAN

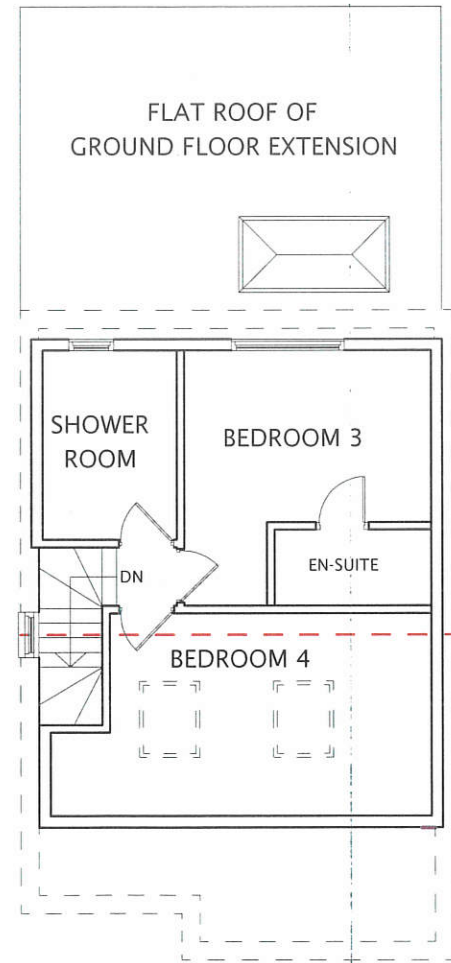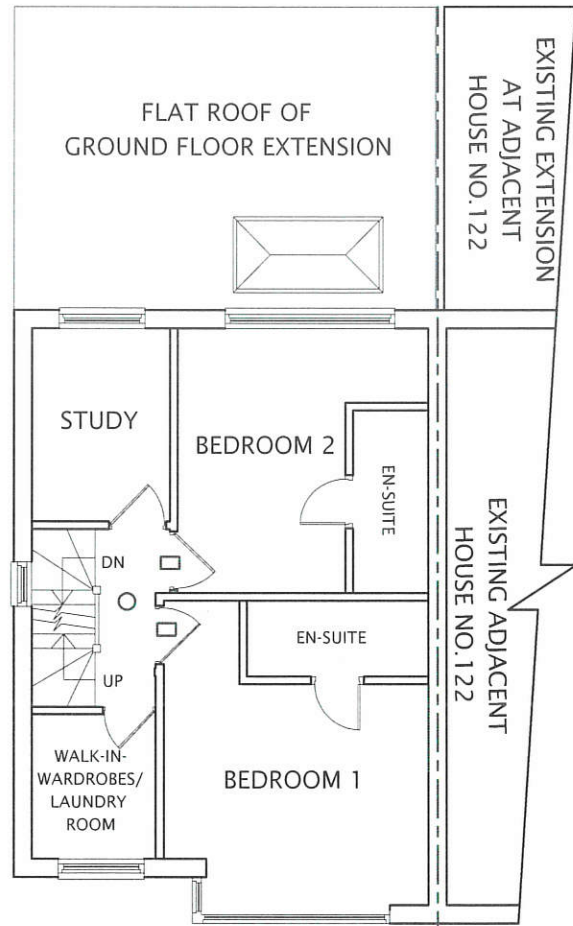

EXISTING FRONT ELEVATION

EXISTING LOFT FLOOR PLAN


DATE	REVISION
COPYRIGHT:	
JOB TITLE: 124 WEST DRAYTON ROAD UXBRIDGE	
DRAWING TITLE: EXISTING GROUND FLOOR, FIRST FLOOR , LOFT AND BLOCK PLANS	
SCALE : 1:100	
DATE: 23-07-2024	DRAWN BY:
DRG. NO. 2024/124/WDRU/1001/B	REV.

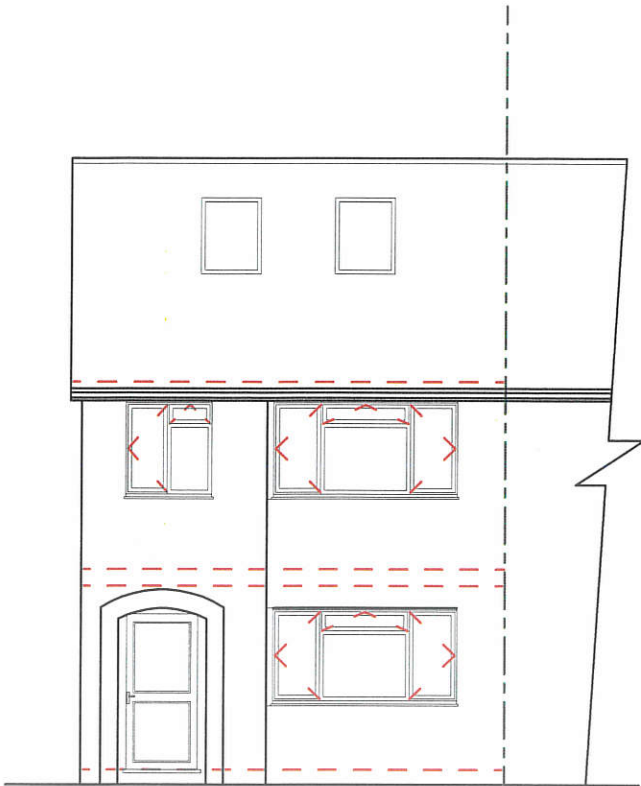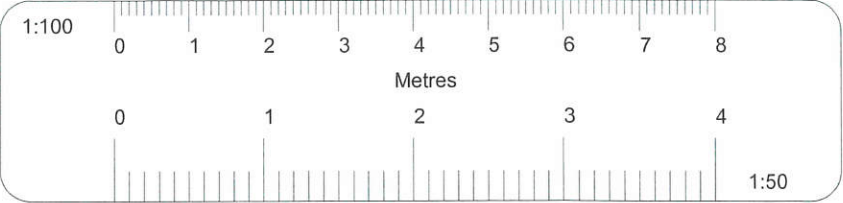


EXISTING FRONT ELEVATION



EXISTING REAR ELEVATION

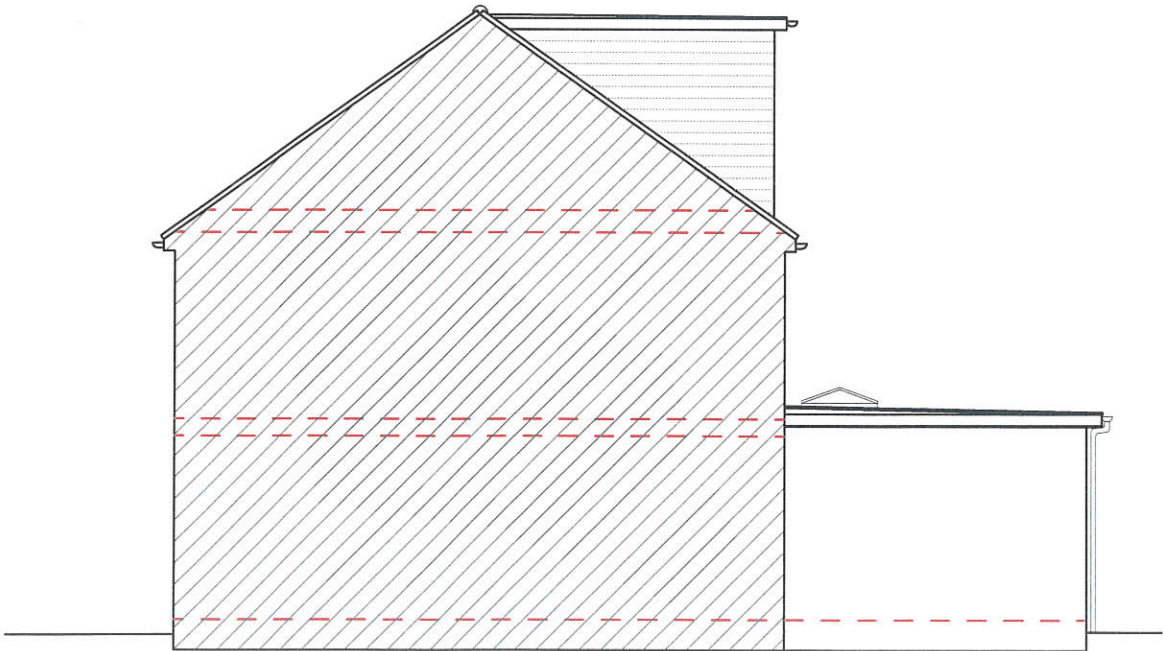

EXISTING RIGHT SIDE ELEVATION

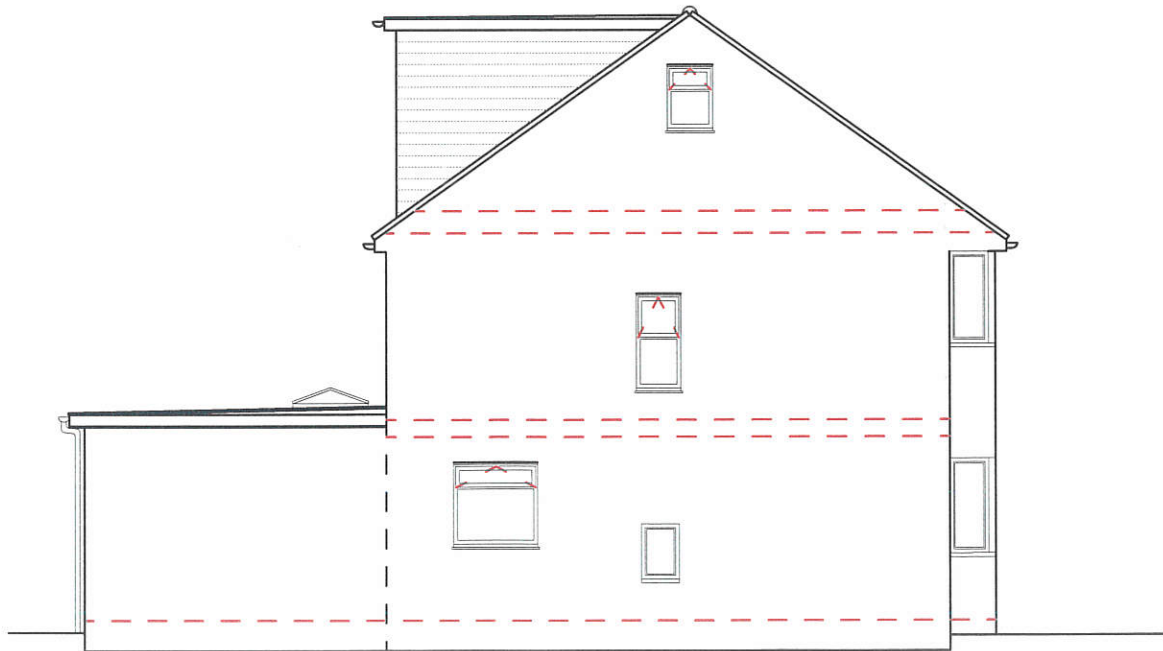

EXISTING LEFT SIDE ELEVATION

All dimensions verified on site.  
All work to comply with British Standards, Code of practice.  
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- Upgrade doors to minimum 20mins. fire rated.
- Smoke detection provided through out complying with requirements of BS5839 part-6.

DATE	REVISION

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JOB TITLE:  
124 WEST DRAYTON ROAD  
UXBRIDGE

DRAWING TITLE:  
EXISTING ELEVATIONS


SCALE : 1:100

DATE: 23-07-2024


DRAWN BY:

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2024/124/WDRU/1002/A	



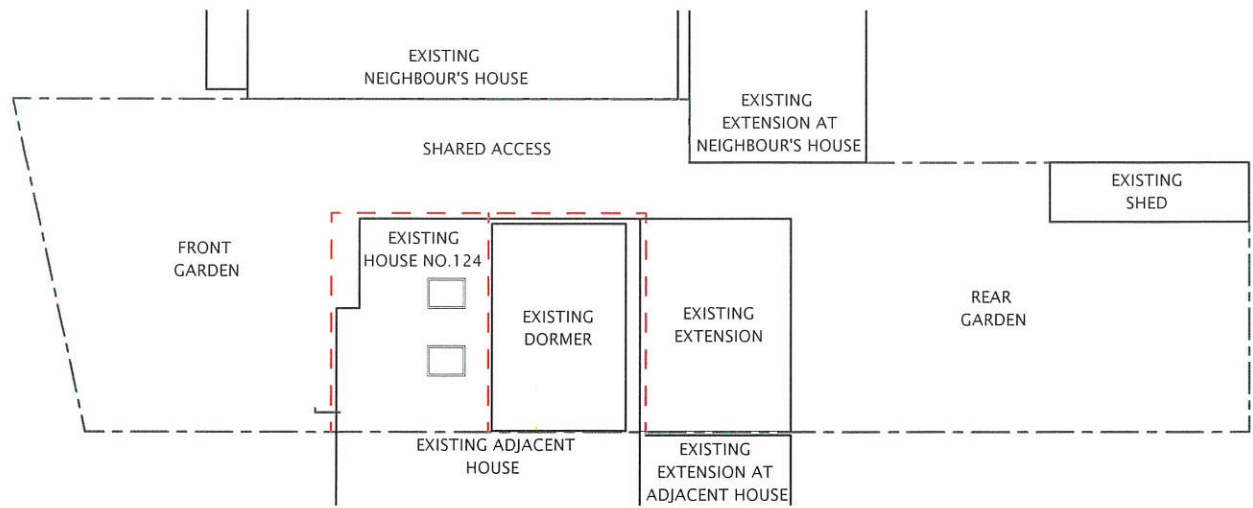


PROPOSED BLOCK / ROOF PLAN (SCALE 1:200)

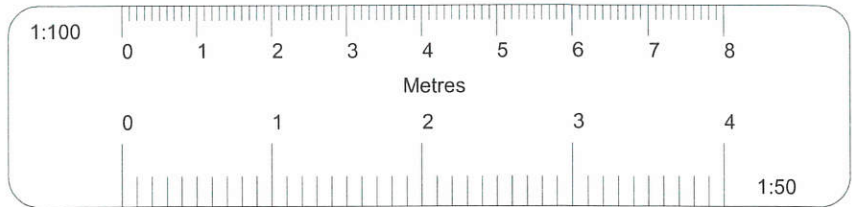


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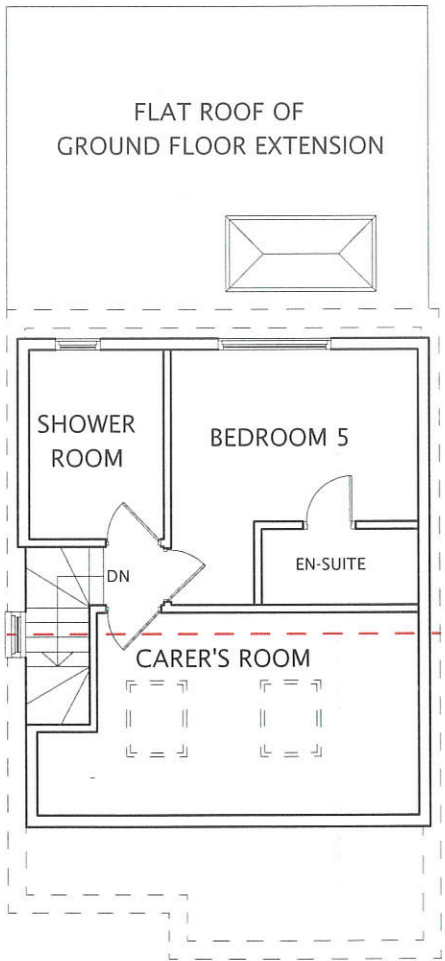
- Upgrade doors to minimum 20mins. fire rated.
- Smoke detection provided through out complying with requirements of BS5839 part-6.



PROPOSED GROUND FLOOR PLAN


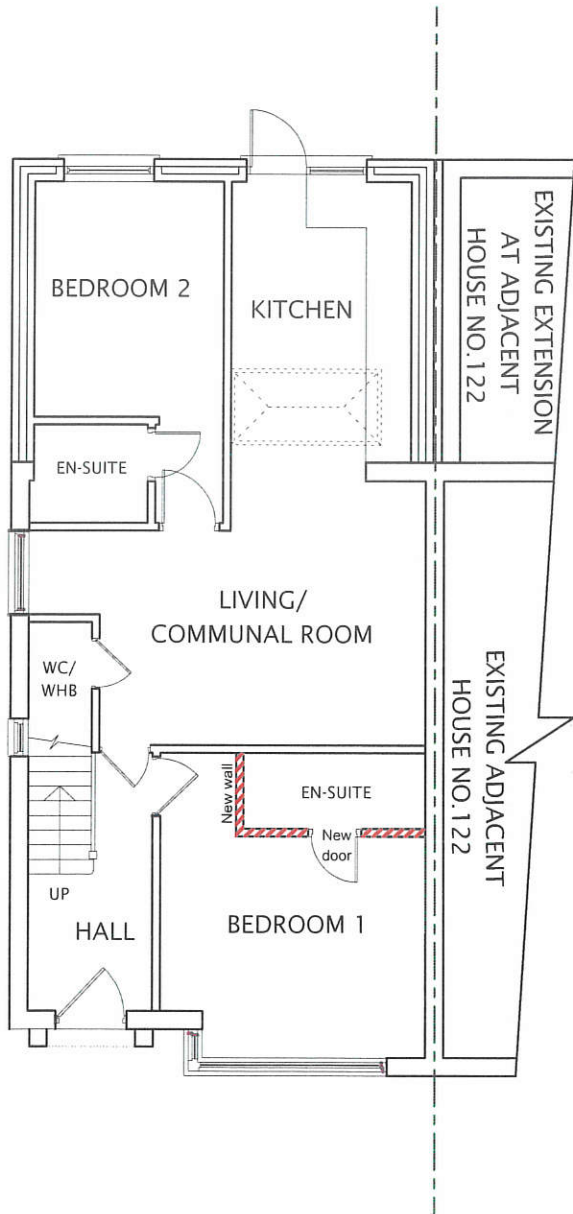


PROPOSED FIRST FLOOR PLAN

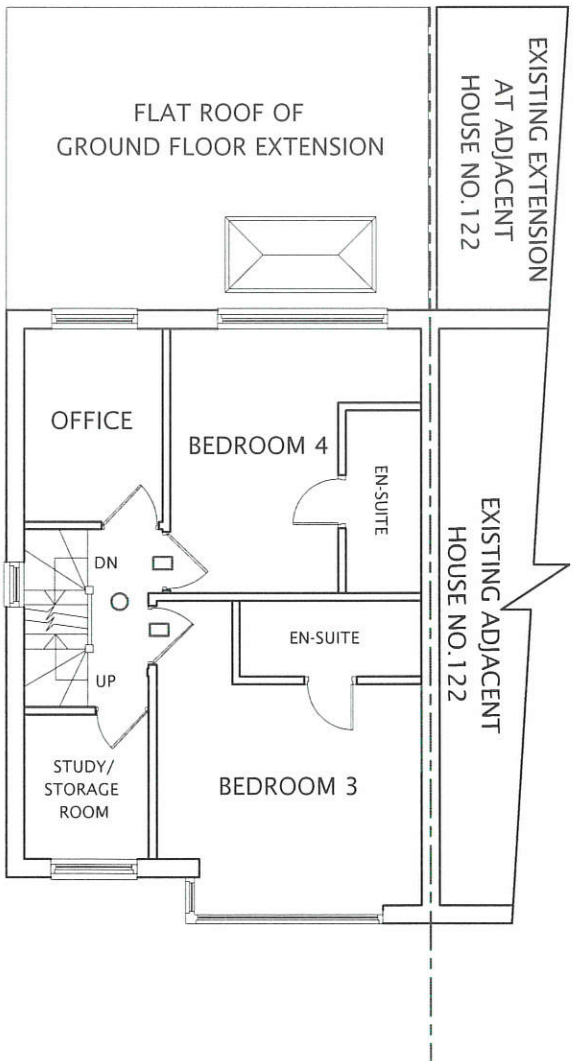

PROPOSED LOFT FLOOR PLAN


DATE	REVISION
COPYRIGHT:	
JOB TITLE: 124 WEST DRAYTON ROAD UXBRIDGE	
DRAWING TITLE: PROPOSED GROUND FLOOR, FIRST FLOOR , LOFT AND BLOCK PLANS	
SCALE : 1:100	
DATE: 23-07-2024      DRAWN BY:	
DRG. NO.  2024/124/WDU/1003/B1	REV.

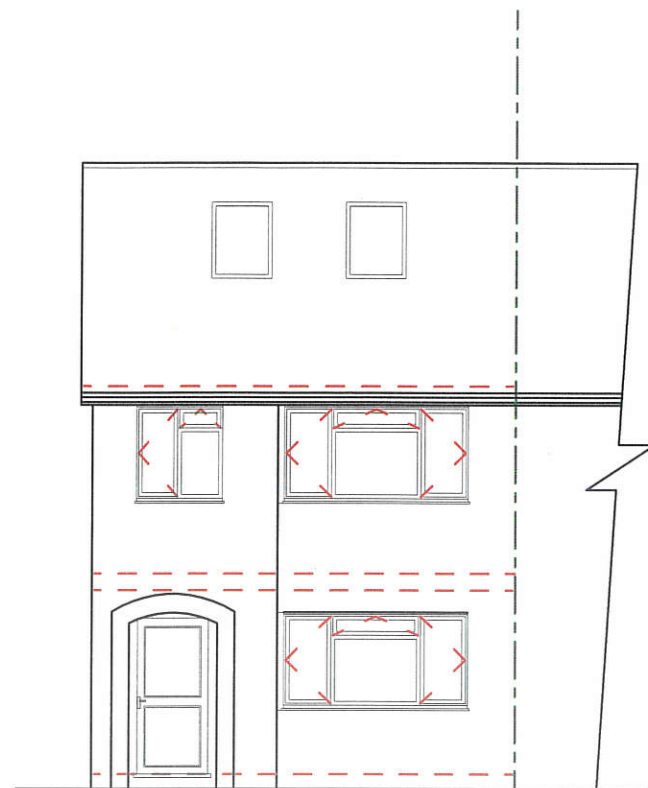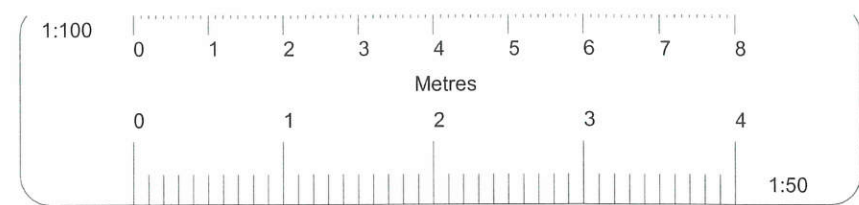


PROPOSED FRONT ELEVATION



PROPOSED REAR ELEVATION

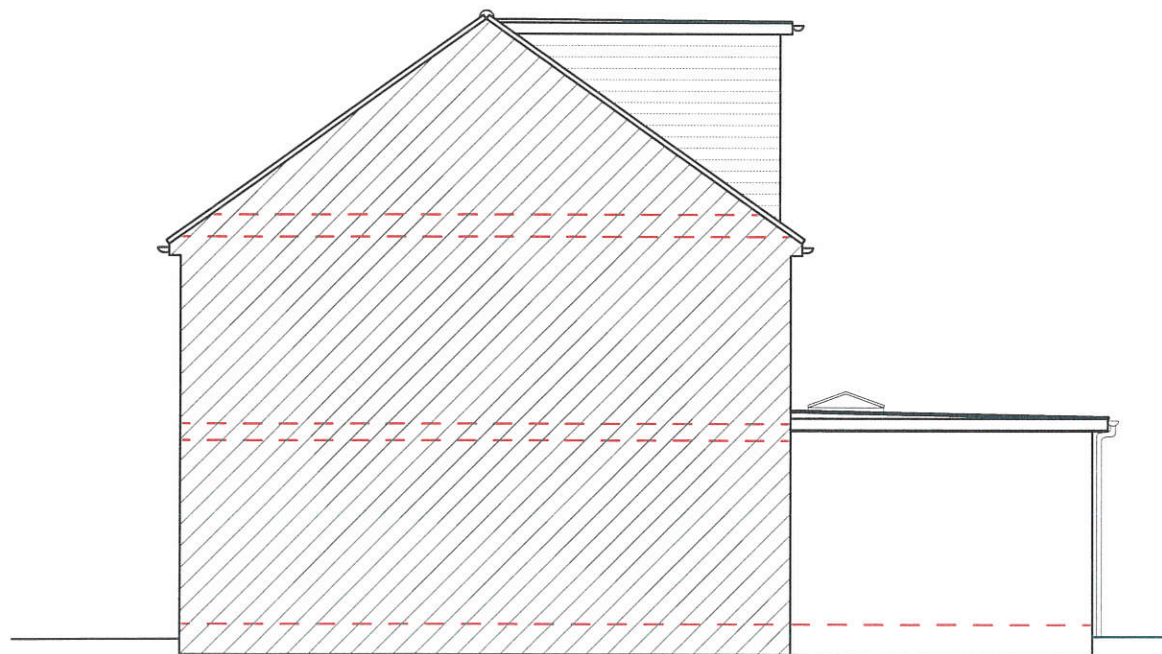

PROPOSED RIGHT SIDE ELEVATION

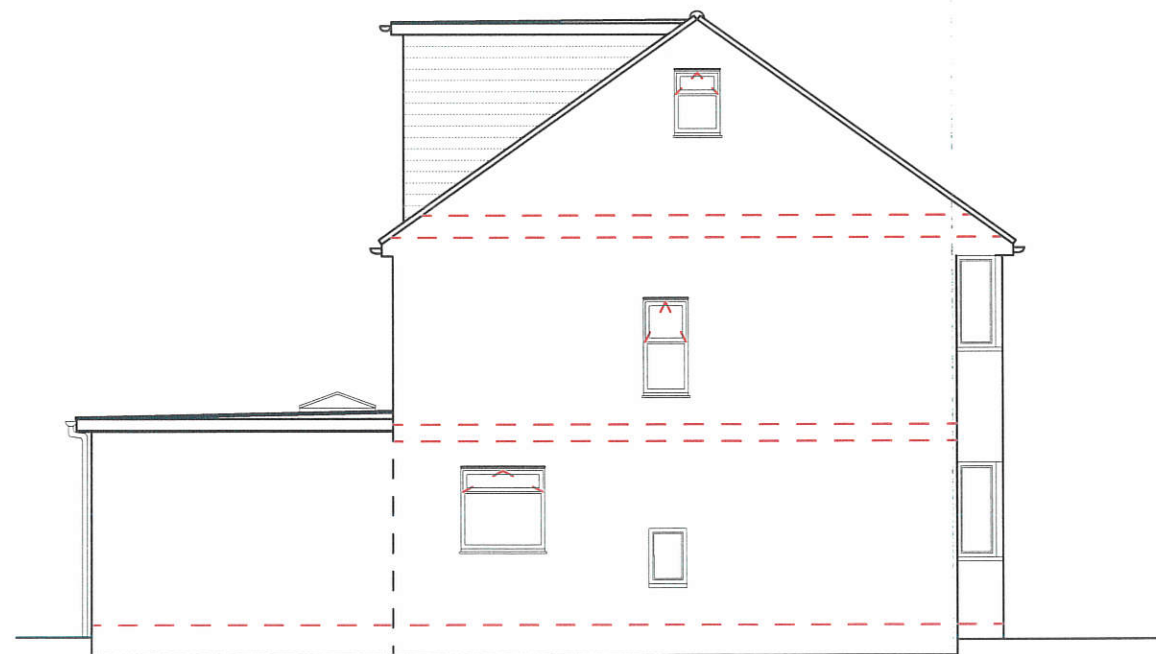

PROPOSED LEFT SIDE ELEVATION

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- Upgrade doors to minimum 20mins. fire rated.
- Smoke detection provided through out complying with requirements of BS5839 part-6.

	DATE	REVISION
COPYRIGHT:		
JOB TITLE:		
124 WEST DRAYTON ROAD UXBRIDGE		
DRAWING TITLE:		
PROPOSED ELEVATIONS		
SCALE : 1:100		
DATE: 23-07-2024		
DRAWN BY:		
DRG. NO.		REV.
2024/124/WDU/1004/A1		