


Existing Ground Floor Plan
Scale 1:100



Existing First Floor Plan
Scale 1:100

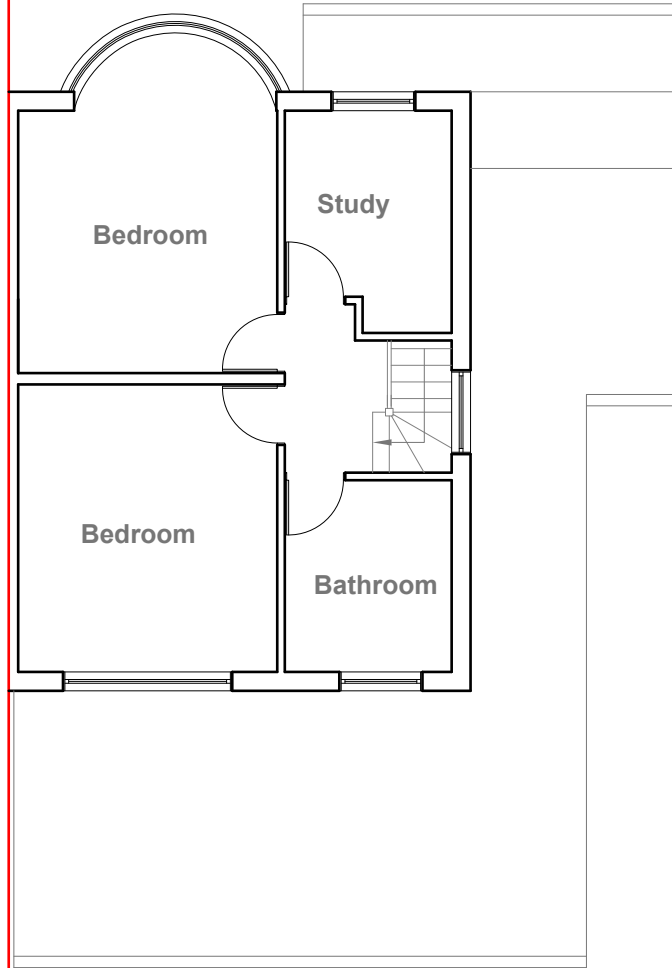

GENERAL NOTES:
1. ALL DIMENSIONS ARE IN MILLIMETER.
2. VERIFY ALL DIMENSIONS AND CONDITIONS BEFORE BUILDING OR STARTING CONSTRUCTION. NOTIFY THE DESIGNER IMMEDIATELY OF ANY DISCREPANCY OR VARIATION.
3. ALL WORK TO COMPLY WITH CURRENT BUILDING REGULATIONS AND CODES OF PRACTICE

Title:

Existing Floor Plans

Site Address
19 Herlwyn Avenue
Ruislip
Middlesex
HA5 6HE

Scale: 1:100 @A3
Date: 26/03/2021
Drawing No.: 2021/45 -01
Drawn By: FP


Revision Date:

e:mail -
faluckpatel@yahoo.com
(M) +44 (0) 7871 466 254





Existing Front Elevation
Scale 1:100

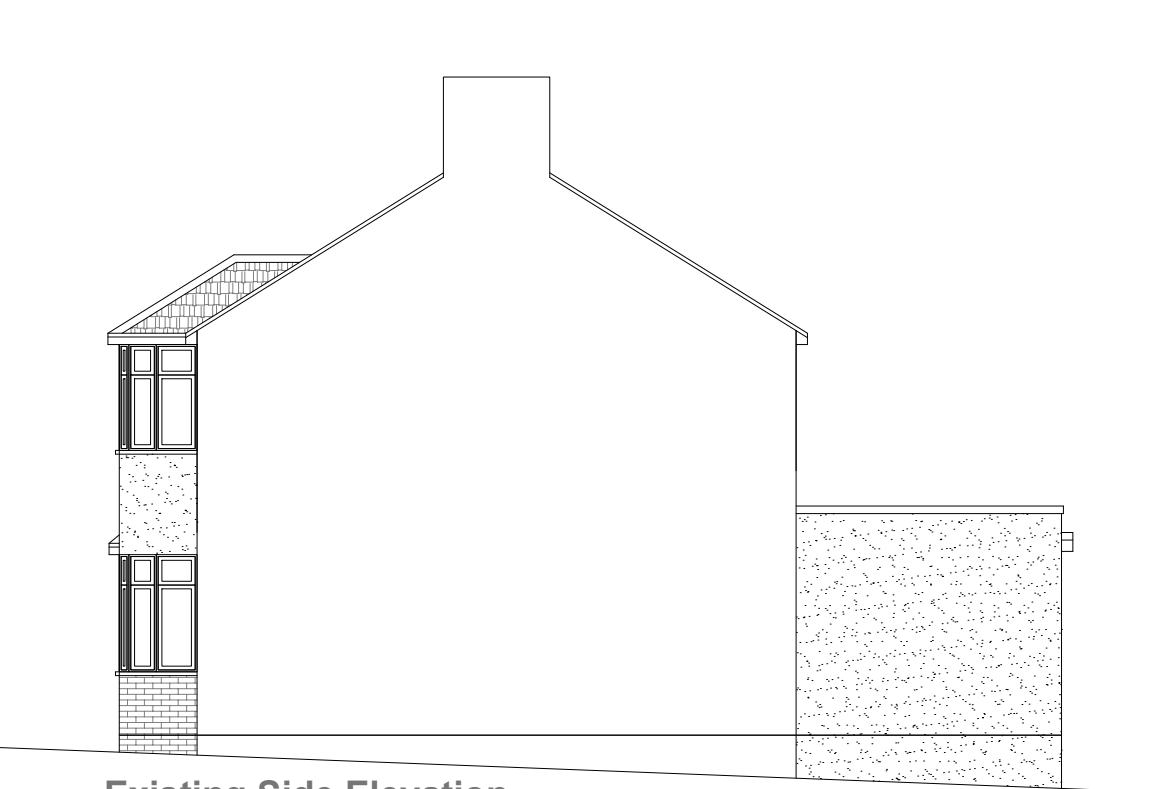

Existing Side Elevation
Scale 1:100



Existing Rear Elevation
Scale 1:100



Existing Side Elevation
Scale 1:100



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3. ALL WORK TO COMPLY WITH CURRENT BUILDING REGULATIONS AND CODES OF PRACTICE

Title:

Existing Elevations


Site Address
19 Herlwyn Avenue
Ruislip
Middlesex
HA5 6HE

Scale: 1:100 @A3
Date: 26/03/2021
Drawing No.: 2021/45 -02
Drawn By: FP


Revision Date:

e:mail -
faluckpatel@yahoo.com
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Proposed First Floor Plan
Scale 1:50

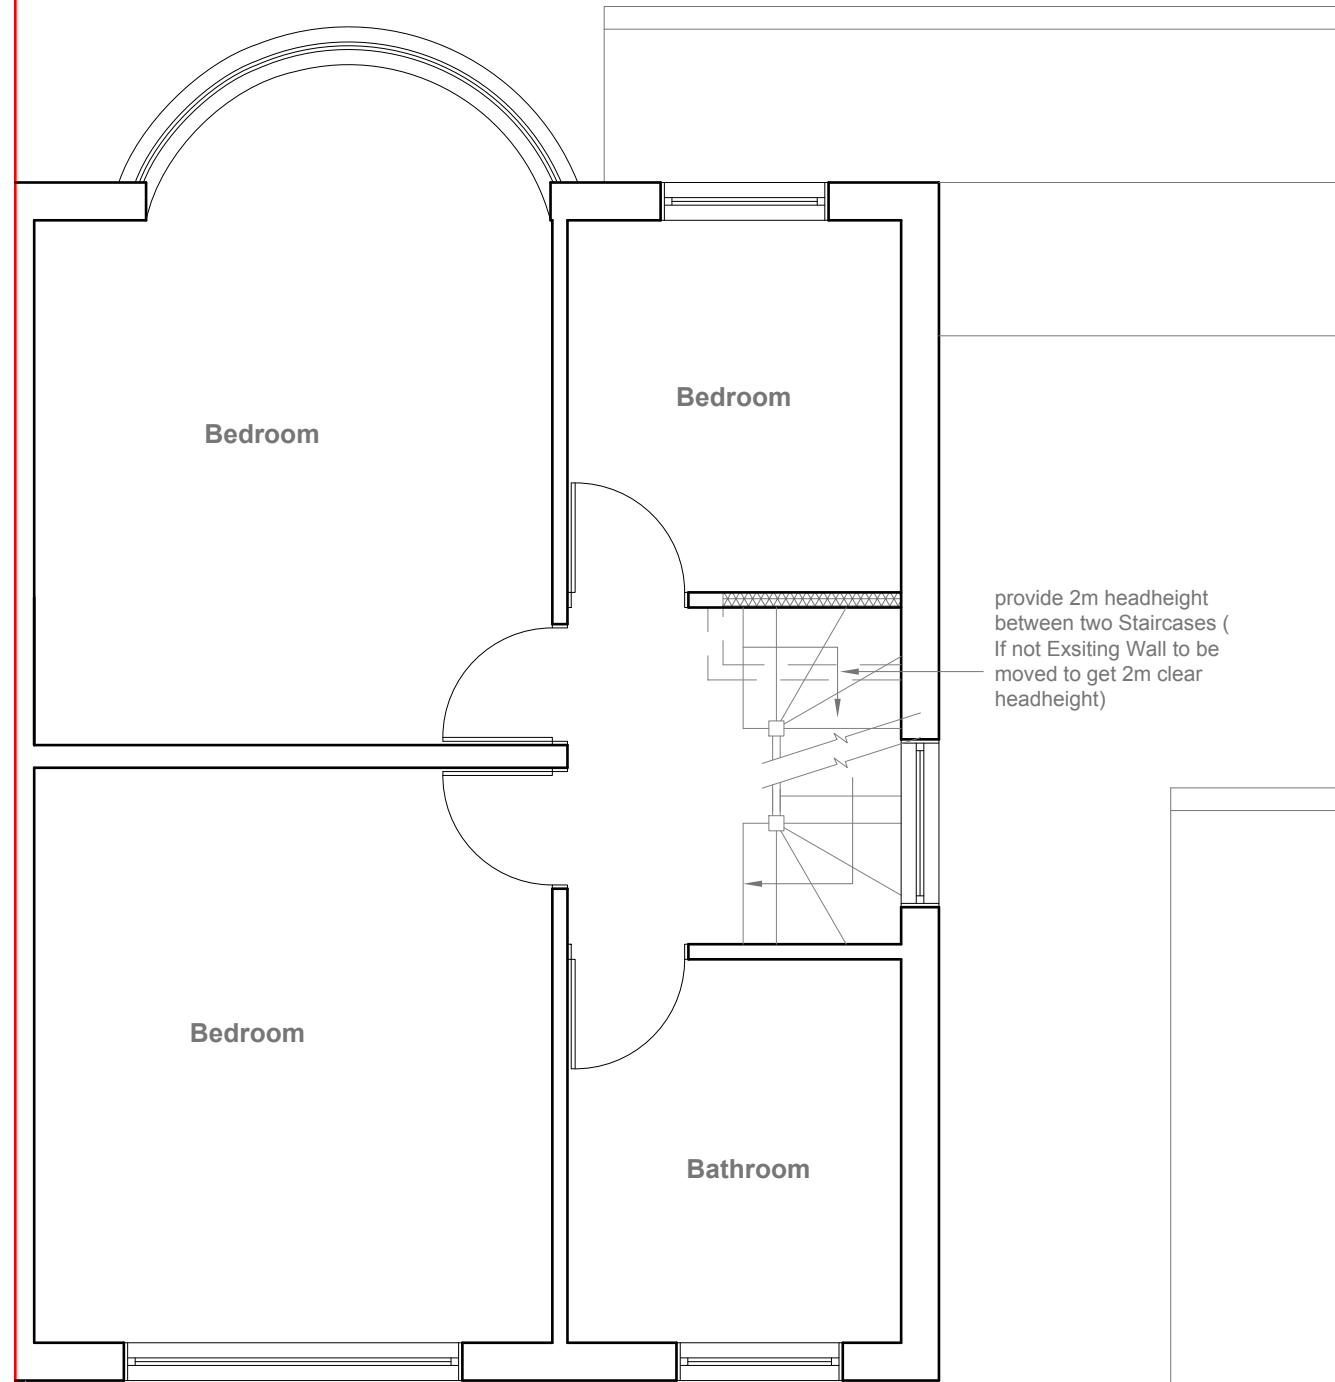

Proposed Loft Floor Plan
Scale 1:50

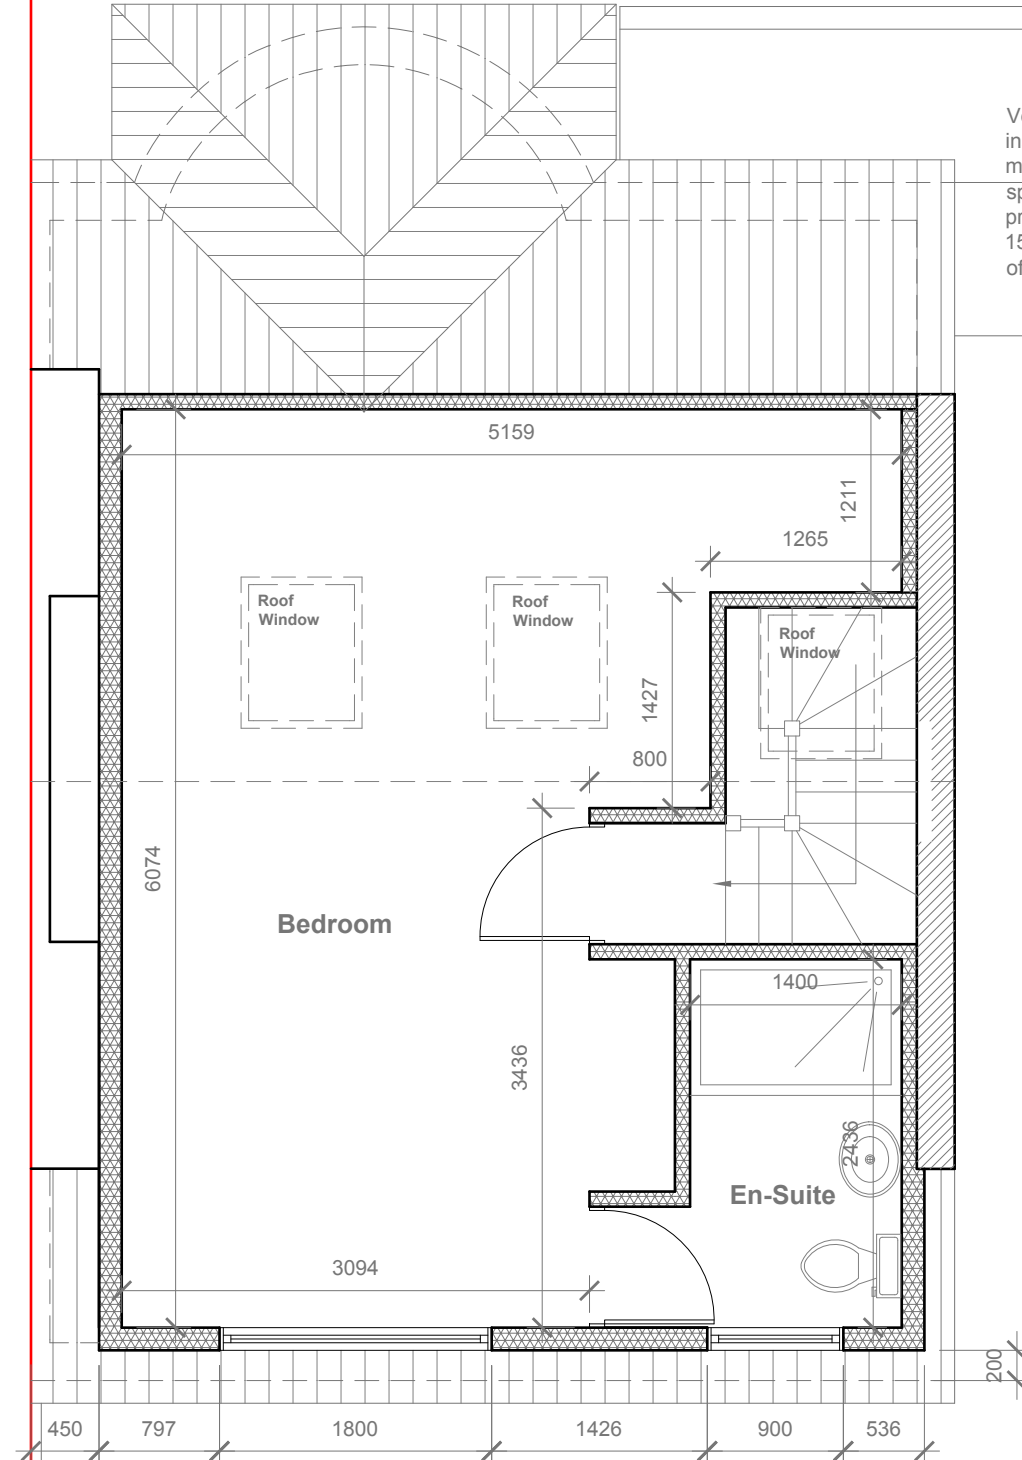

- GENERAL NOTES:**
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 3. ALL WORK TO COMPLY WITH CURRENT BUILDING REGULATIONS AND CODES OF PRACTICE

Title:

Proposed First Floor & Loft Plans

Site Address

19 Herlwyn Avenue
Ruislip
Middlesex
HA5 6HE

Scale: 1:50 @A3

Date: 26/03/2021

Drawing No.:
2021/45 -03

Drawn By:
FP

Revision Date:


e:mail - faluckpatel@yahoo.com (M) +44 (0) 7871 466 254	

Faluck Patel

Proposed External Finish
Materials to Match Existing
External Finish Materials



Proposed Front Elevation
Scale 1:100

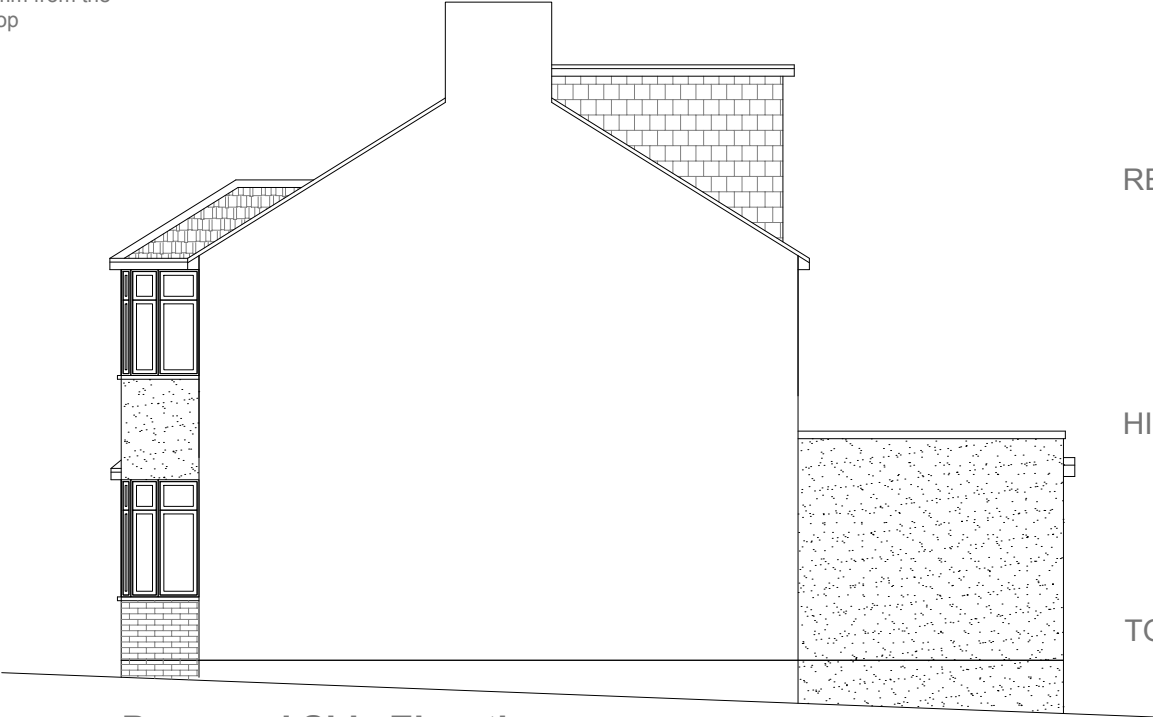

Proposed Side Elevation
Scale 1:100

REAR DORMER VOLUME = $W \times H \times L / 2$
 $5.459 \times 2.341 \times 3.762 / 2$
 $48.07 / 2$
 $V1 = 24.03 \text{ CU.MT.}$

HIP TO GABLE ROOF VOLUME = $W1 \times H1 \times L1 / 6$
 $8.224 \times 2.709 \times 3.962 / 6$
 $88.26 / 6$
 $V2 = 14.71 \text{ CU.MT.}$

TOTAL ROOF VOLUME = $V1 + V2$
 $24.03 + 14.71$
 $38.74 \text{ CU.MT.} < 50.00 \text{ CU.MT}$



Proposed Rear Elevation
Scale 1:100



Proposed Side Elevation
Scale 1:100



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3. ALL WORK TO COMPLY WITH CURRENT BUILDING REGULATIONS AND CODES OF PRACTICE

Title:

Proposed Elevations

Site Address	Scale: 1:100 @A3	Revision Date:
19 Herlwyn Avenue	Date: 26/03/2021	
Ruislip	Drawing No.:	
Middlesex	2021/45 -04	
HA5 6HE	Drawn By:	
	FP	e:mail - faluckpatel@yahoo.com (M) +44 (0) 7871 466 254

