


**Existing Ground Floor Plan**  
Scale 1:100

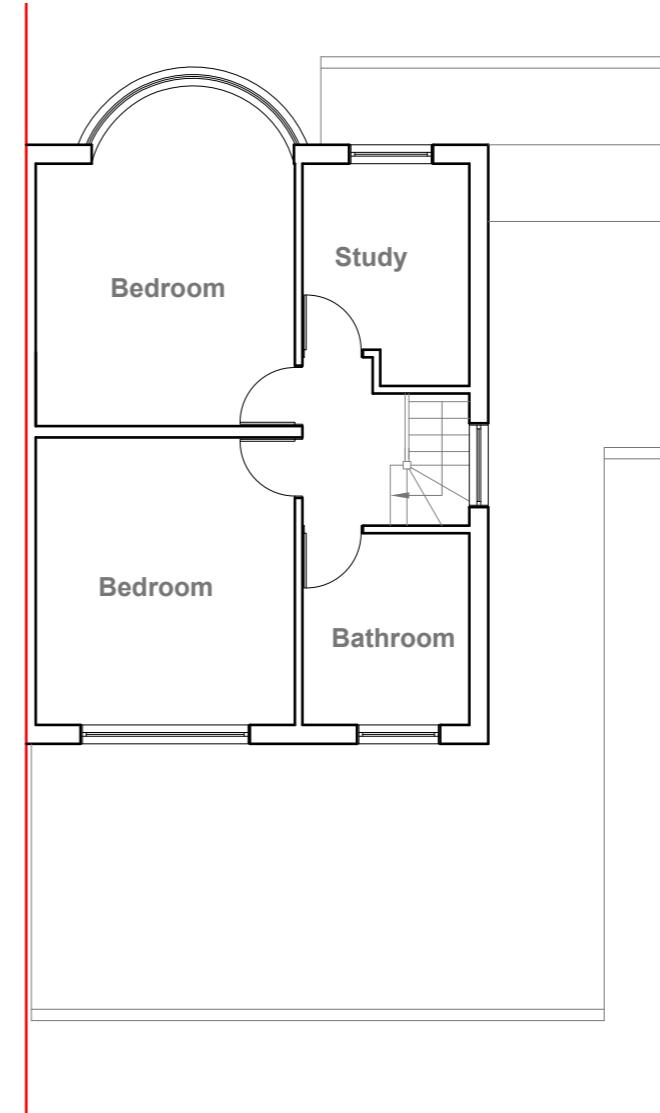

**Existing First Floor Plan**  
Scale 1:100

**GENERAL NOTES:**

1. ALL DIMENSIONS ARE IN MILLIMETER.
2. VERIFY ALL DIMENSIONS AND CONDITIONS BEFORE BUILDING OR STARTING CONSTRUCTION. NOTIFY THE DESIGNER IMMEDIATELY OF ANY DISCREPANCY OR VARIATION.
3. ALL WORK TO COMPLY WITH CURRENT BUILDING REGULATIONS AND CODES OF PRACTICE

**Title:**

## Existing Floor Plans

**Site Address**

19 Herlwyn Avenue  
Ruislip  
Middlesex  
HA5 6HE

**Scale: 1:100 @A3**


Date: 26/03/2021  
Drawing No.: 2021/45-01  
Drawn By: FP

**Revision Date:**



**Existing Front Elevation**

Scale 1:100

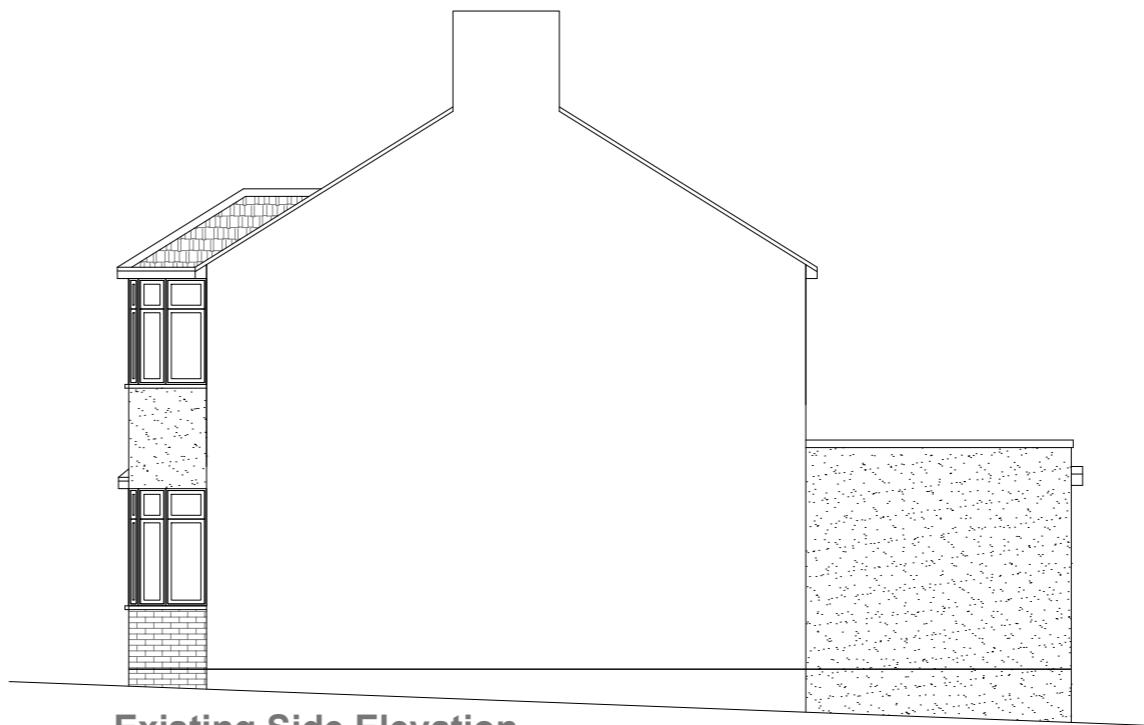

**Existing Side Elevation**

Scale 1:100



**Existing Rear Elevation**

Scale 1:100



**Existing Side Elevation**

Scale 1:100

**GENERAL NOTES:**

1. ALL DIMENSIONS ARE IN MILLIMETER.
2. VERIFY ALL DIMENSIONS AND CONDITIONS BEFORE BUILDING OR STARTING CONSTRUCTION. NOTIFY THE DESIGNER IMMEDIATELY OF ANY DISCREPANCY OR VARIATION.
3. ALL WORK TO COMPLY WITH CURRENT BUILDING REGULATIONS AND CODES OF PRACTICE

**Title:**

## Existing Elevations


**Site Address**  
19 Herlwyn Avenue  
Ruislip  
Middlesex  
HA5 6HE

**Scale: 1:100 @A3**  
Date: 26/03/2021  
Drawing No.:  
2021/45-02  
Drawn By:  
FP

**Revision Date:**  
e:mail -  
faluckpatel@yahoo.com  
(M) +44 (0) 7871 466 254


10 Meter  
5  
2  
1  
0  
1:100

**Faluck Patel**

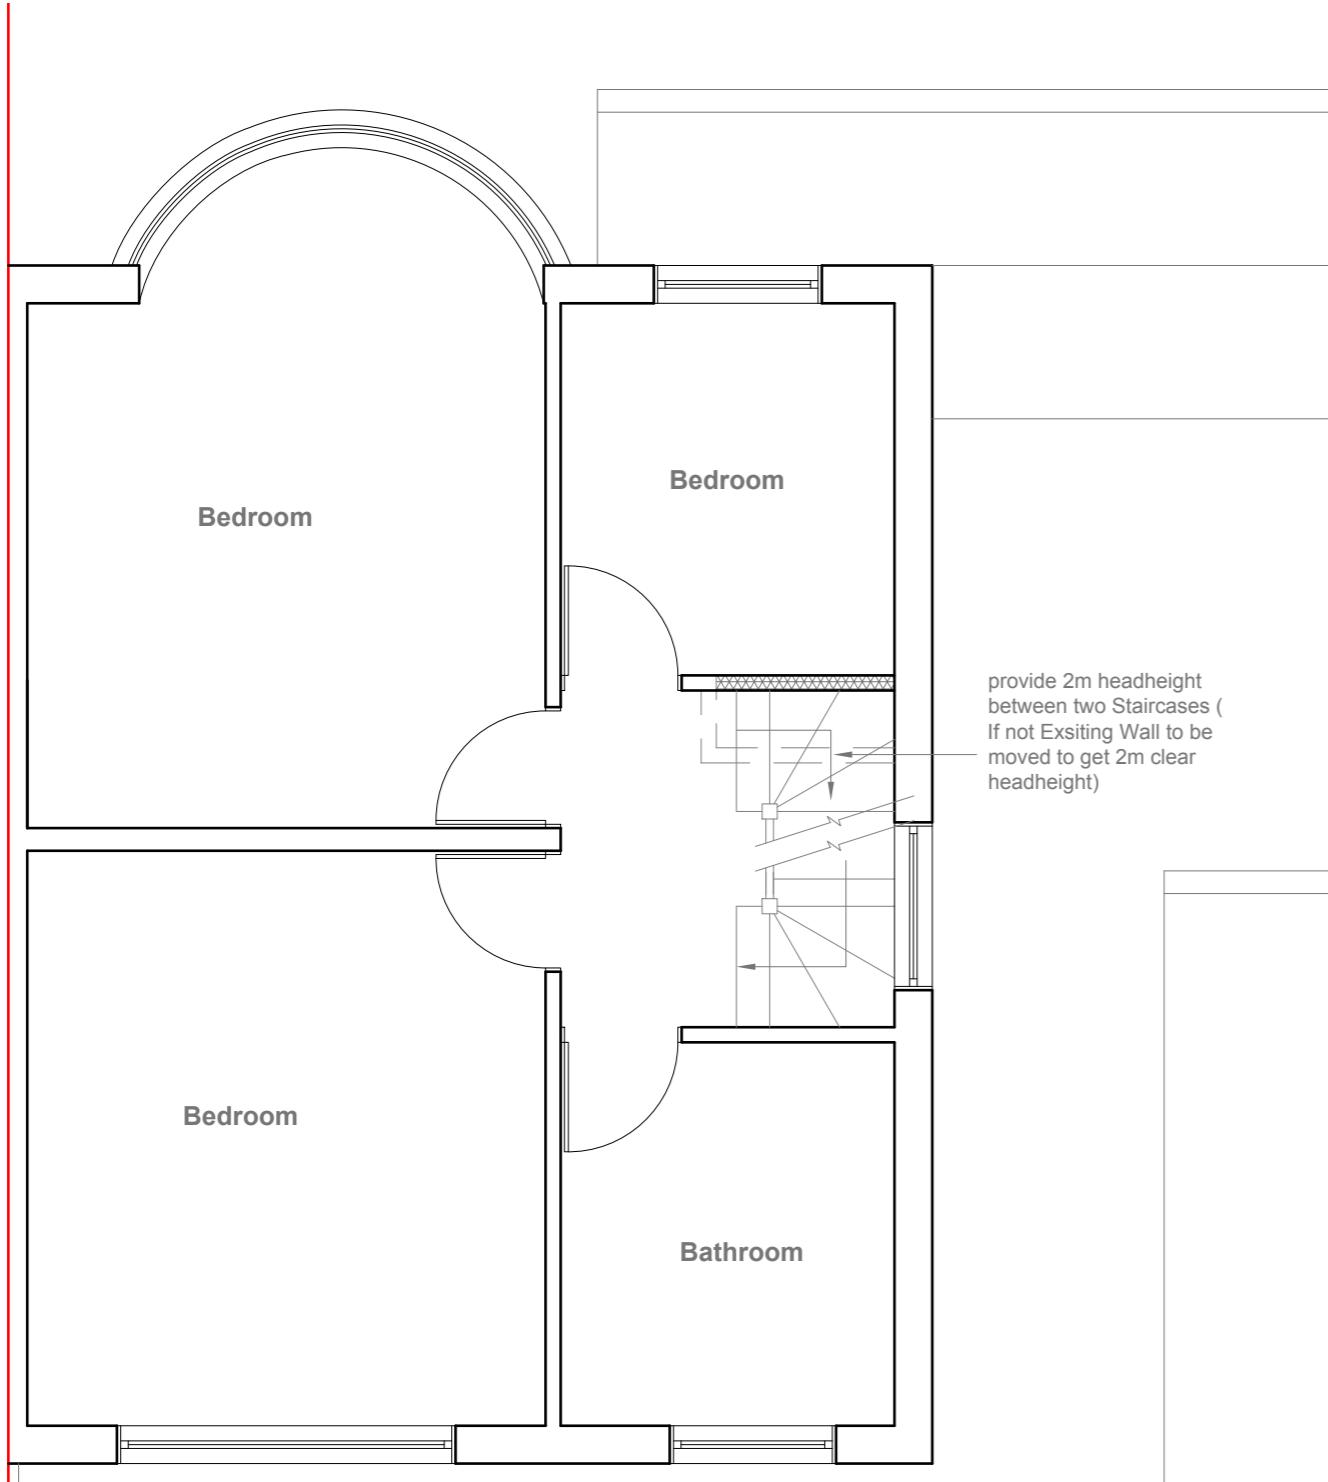

## Proposed First Floor Plan

Scale 1:50

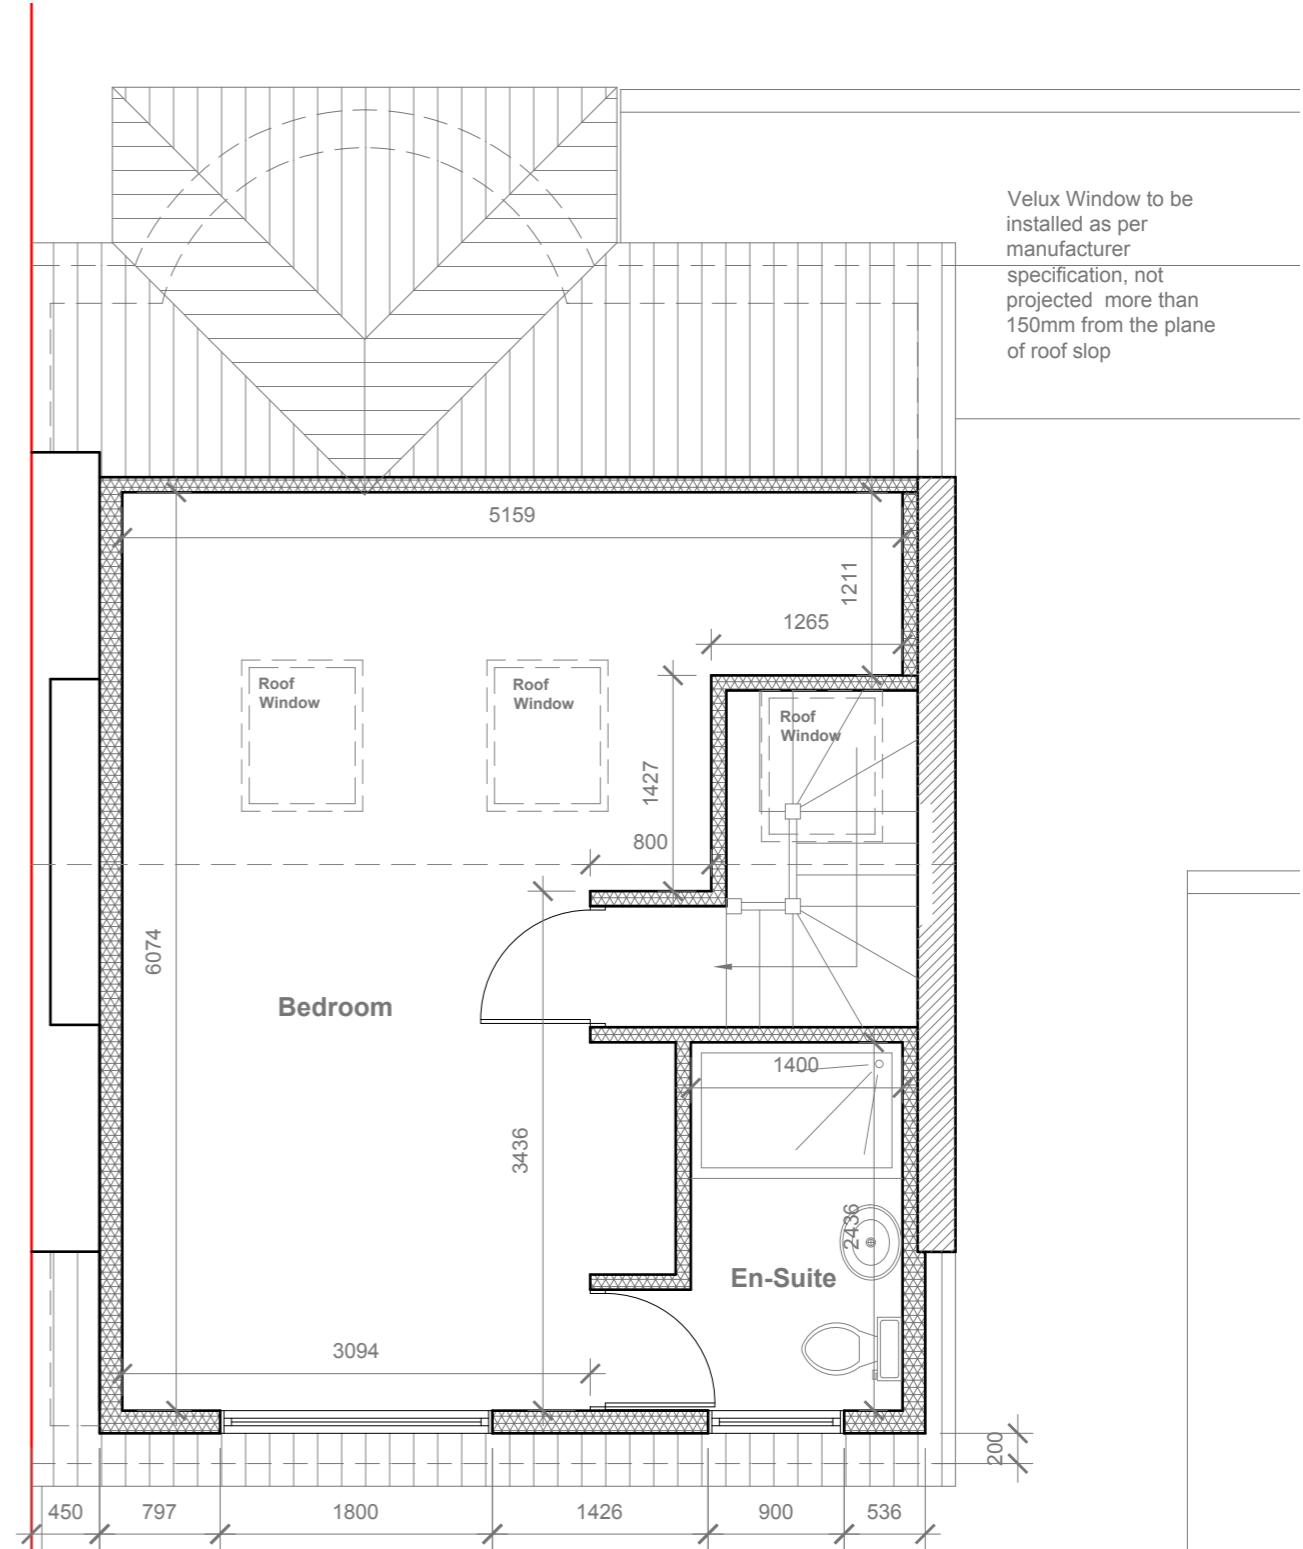

## Proposed Loft Floor Plan

Scale 1:50

**GENERAL NOTES:**

**GENERAL NOTES:**


1. ALL DIMENSIONS ARE IN MILLIMETER.
2. VERIFY ALL DIMENSIONS AND CONDITIONS BEFORE BUILDING OR STARTING CONSTRUCTION. NOTIFY THE DESIGNER IMMEDIATELY OF ANY DISCREPANCY OR VARIATION.
3. ALL WORK TO COMPLY WITH CURRENT BUILDING REGULATIONS AND CODES OF PRACTICE

Title:

## Proposed First Floor & Loft Plans


Site Address  19 Herwyn Avenue Ruislip Middlesex HA5 6HE	Scale: 1:50 @A3  Date: 26/03/2021  Drawing No.: 2021/45 -03  Drawn By:  FP	Revision Date:  _____ _____ _____ _____	Faluck Patel
-------------------------------------------------------------------------	-------------------------------------------------------------------------------------------------------	--------------------------------------------------------	-----------------

# Faluck Patel

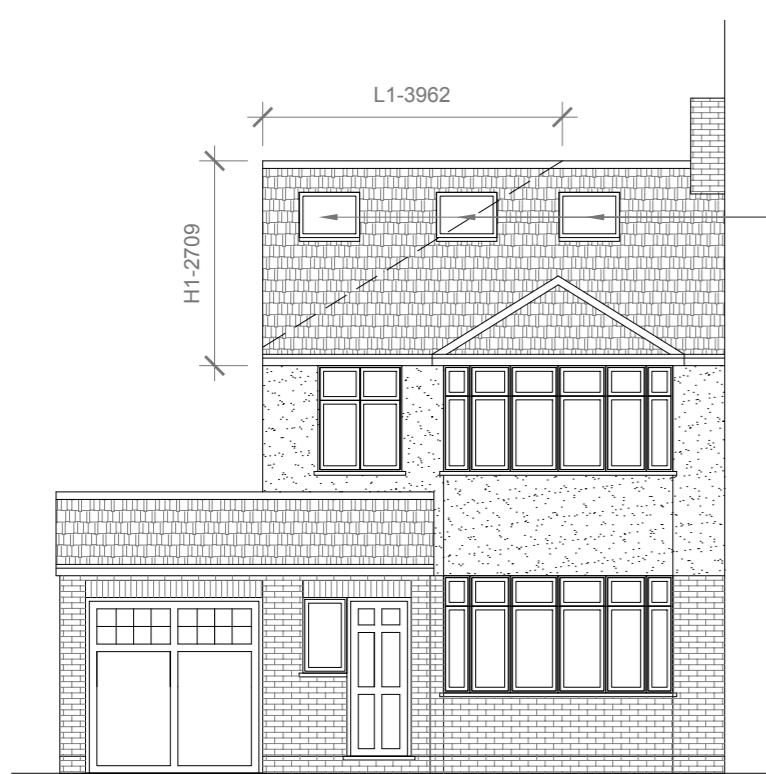

**Proposed Front Elevation**

Scale 1:100

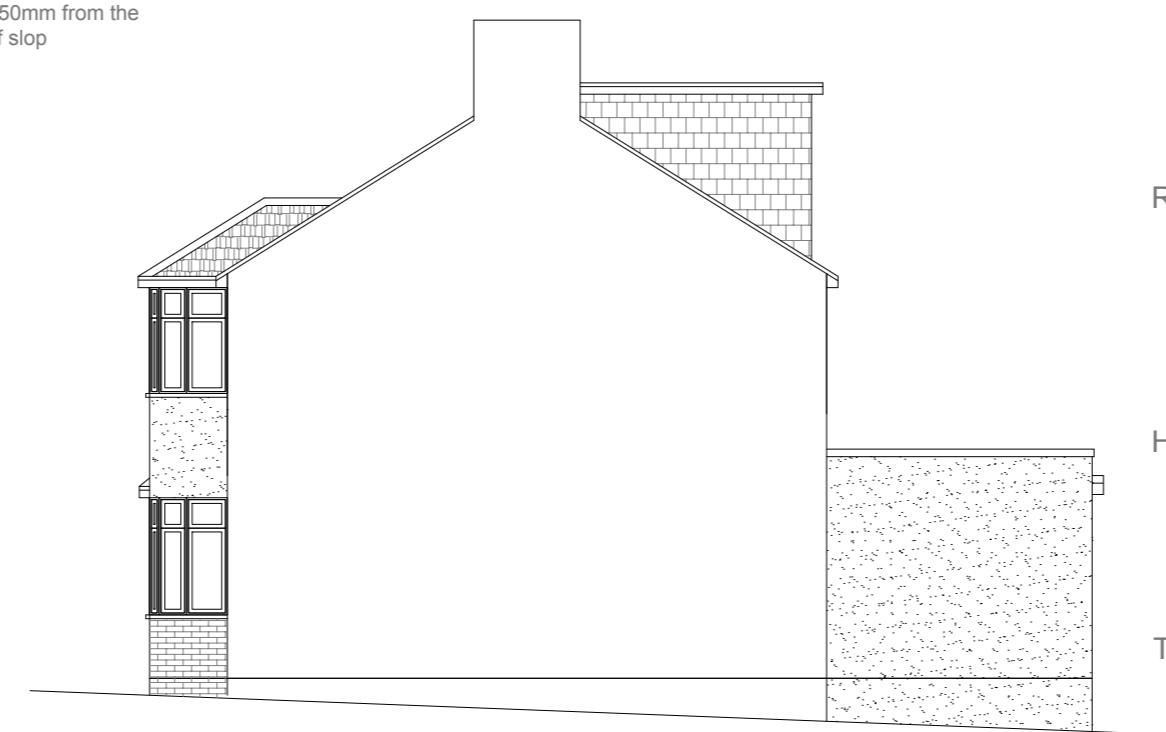

**Proposed Side Elevation**

Scale 1:100



**Proposed Rear Elevation**

Scale 1:100



**Proposed Side Elevation**

Scale 1:100

Proposed External Finish Materials to Match Existing External Finish Materials

REAR DORMER VOLUME =  $W \times H \times L / 2$   
 $5.459 \times 2.341 \times 3.762 / 2$   
 $48.07 / 2$   
 $24.03 \text{ CU.MT.}$

HIP TO GABLE ROOF VOLUME =  $W1 \times H1 \times L1 / 6$   
 $8.224 \times 2.709 \times 3.962 / 6$   
 $88.26 / 6$   
 $14.71 \text{ CU.MT.}$

TOTAL ROOF VOLUME =  $V1 + V2$   
 $24.03 + 14.71$   
 $38.74 \text{ CU.MT.} < 50.00 \text{ CU.MT.}$

10 Meter  
5  
2  
1  
0  
1:100

GENERAL NOTES:  
1. ALL DIMENSIONS ARE IN MILLIMETER.  
2. VERIFY ALL DIMENSIONS AND CONDITIONS BEFORE BUILDING OR  
STARTING CONSTRUCTION. NOTIFY THE DESIGNER IMMEDIATELY OF ANY  
DISCREPANCY OR VARIATION.  
3. ALL WORK TO COMPLY WITH CURRENT BUILDING REGULATIONS  
AND CODES OF PRACTICE

Title:

## Proposed Elevations

Site Address  
19 Herlyn Avenue  
Ruislip  
Middlesex  
HA5 6HE

Scale: 1:100 @A3  
Date: 26/03/2021  
Drawing No.: 2021/45-04  
Drawn By: FP

Revision Date:  
e:mail - faluckpatel@yahoo.com  
(M) +44 (0) 7871 466 254

**Faluck Patel**