

Scale 1:1250


Projection : British National Grid
29 August 2024 03:23

SITE LOCATION PLAN

Notes:
Contractors must verify all dimensions on site before commencing any work or shop drawings. This drawing must not be scaled. Use figured dimensions only. Subject to statutory approvals and survey.

Proposal

Boundary

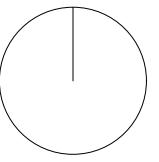

Existing Block Plan (1:500)

This is a 'Scheme Level Drawing' and is intended to illustrate the general arrangement of the project proposals. As it stands this drawing does not include all of the detail necessary for a full plans building regulations application.

While this drawing can be used as a base drawing for construction purposes, your building contractor may require more information. It is therefore important to discuss, with your architect & builder together, where more detail would be appropriate.

1. This drawing has been based upon a measured survey drawing by others. As a result, the precision of the dimensions indicated is dependent upon the information supplied.
2. While this drawing can be used as a base drawing for construction purposes, it is **VERY IMPORTANT** that all dimensions are checked carefully before any work commences or any materials are ordered.
3. This drawing can be used as part of a planning application, although your planning officer may ask for more specific information about some aspects of the design. Ask your architect for more information on planning applications.

4. Where applicable, a suitable Structural Engineer and/or a Party Wall Surveyor should be consulted. Although as far as possible these instances have been indicated, this is not necessarily exhaustive and the whole scope of proposed works should be reviewed.

Further detailed design / dwgs may be needed for this section.

This symbol indicates that it may be beneficial to have more detailed design drawings prepared to illustrate elements of the proposal in more detail so that your building contractor can more fully understand the intention of the design.

You may need to consult a Party Wall Surveyor for this section.

This symbol indicates that you may need to take action in order to comply with the Party Wall Act and it may be wise to consult a suitable Party Wall surveyor. Your architect can help point you in the right direction.

This symbol indicates that structural calculations / structural design may be required, both of which should be undertaken by a suitable structural engineer. Your architect can help point you in the right direction.

Revisions:
a. date.

All dimensions are in millimetres
All dimensions to be checked on site



Proposed Block Plan (1:500)


0 10 20 30 40 50m
SCALE: 1/ 500 @ A3

Project name:


47 Ashford Avenue,
Hayes, UB4 0LZ

Drawing name: Existing & Proposed Block Plan		
Job no:	Drawing no:	Revision:
AH 735	01	-
Scale: 1/500 @ A3	Date: 29/08/2024	Drawn by: GG

Notes:
Contractors must verify all dimensions on site before commencing any work or shop drawings. This drawing must not be scaled. Use figured dimensions only. Subject to statutory approvals and survey.

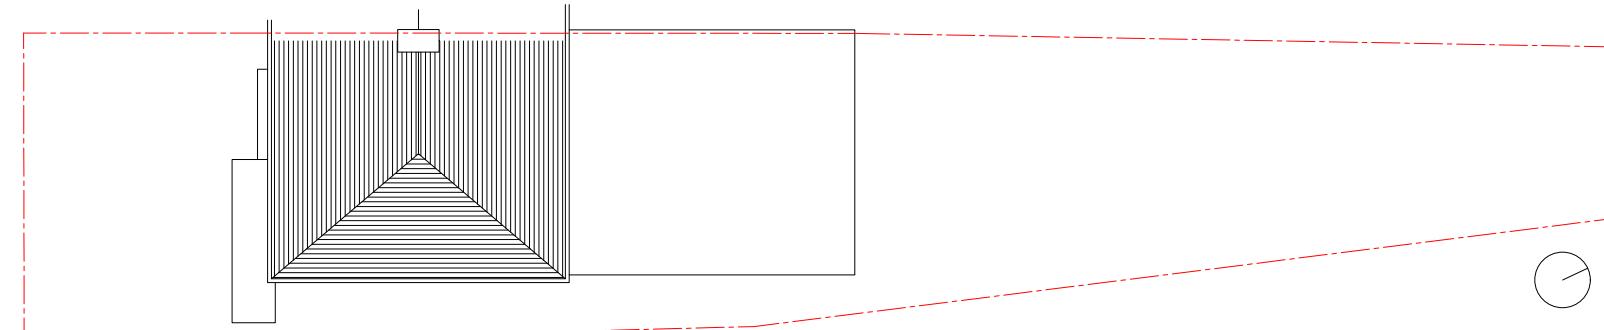

Existing Site Plan (1:200)

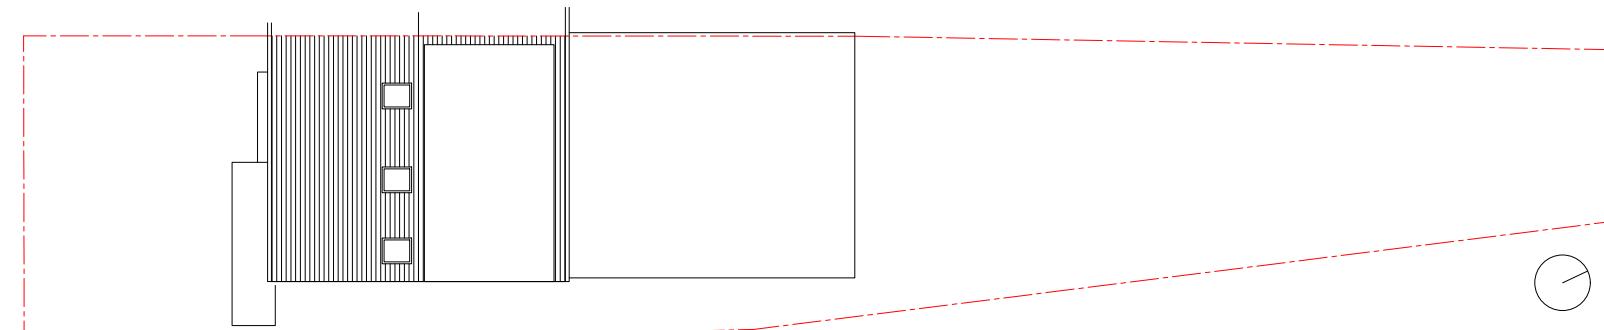

Proposed Site Plan (1:200)

This is a 'Scheme Level Drawing' and is intended to illustrate the general arrangement of the project proposals. As it stands this drawing does not include all of the detail necessary for a full plans building regulations application.

While this drawing can be used as a base drawing for construction purposes, your building contractor may require more information. It is therefore important to discuss, with your architect & builder together, where more detail would be appropriate.

1. This drawing has been based upon a measured survey drawing by others. As a result, the precision of the dimensions indicated is dependent upon the information supplied.
2. While this drawing can be used as a base drawing for construction purposes, it is **VERY IMPORTANT** that all dimensions are checked carefully before any work commences or any materials are ordered.
3. This drawing can be used as part of a planning application, although your planning officer may ask for more specific information about some aspects of the design. Ask your architect for more information on planning applications.
4. Where applicable, a suitable Structural Engineer and/or a Party Wall Surveyor should be consulted. Although as far as possible these instances have been indicated, this is not necessarily exhaustive and the whole scope of proposed works should be reviewed.

5. Unless other arrangements have been specifically made, your building contractor should serve a Building Notice, as and where applicable, to your local authority to satisfy the requirements of the Building Regulations. Your building contractor should also liaise with the Building Control Officer regarding routine inspections of the work.

Further detailed design / dwgs may be needed for this section.

This symbol indicates that it may be beneficial to have more detailed design drawings prepared to illustrate elements of the proposal in more detail so that your building contractor can more fully understand the intention of the design.

You may need to consult a Party Wall Surveyor for this section.

This symbol indicates that you may need to take action in order to comply with the Party Wall Act and it may be wise to consult a suitable Party Wall surveyor. Your architect can help point you in the right direction.

You may need a Structural Engineer for this section.

This symbol indicates that structural calculations / structural design may be required, both of which should be undertaken by a suitable structural engineer. Your architect can help point you in the right direction.

Revisions:
a. date.

All dimensions are in millimetres
All dimensions to be checked on site


0 4 8 12 16 20m
SCALE: 1/ 200 @ A3

Project name:


Drawing name: Existing & Proposed Site Plan		
Job no:	Drawing no:	Revision:
AH 735	01	-
1/200 @ A3	Date: 29/08/2024	Drawn by: GG

47 Ashford Avenue,
Hayes, UB4 0LZ


Notes:
Contractors must verify all dimensions on site before commencing any work or shop drawings. This drawing must not be scaled. Use figured dimensions only. Subject to statutory approvals and survey.

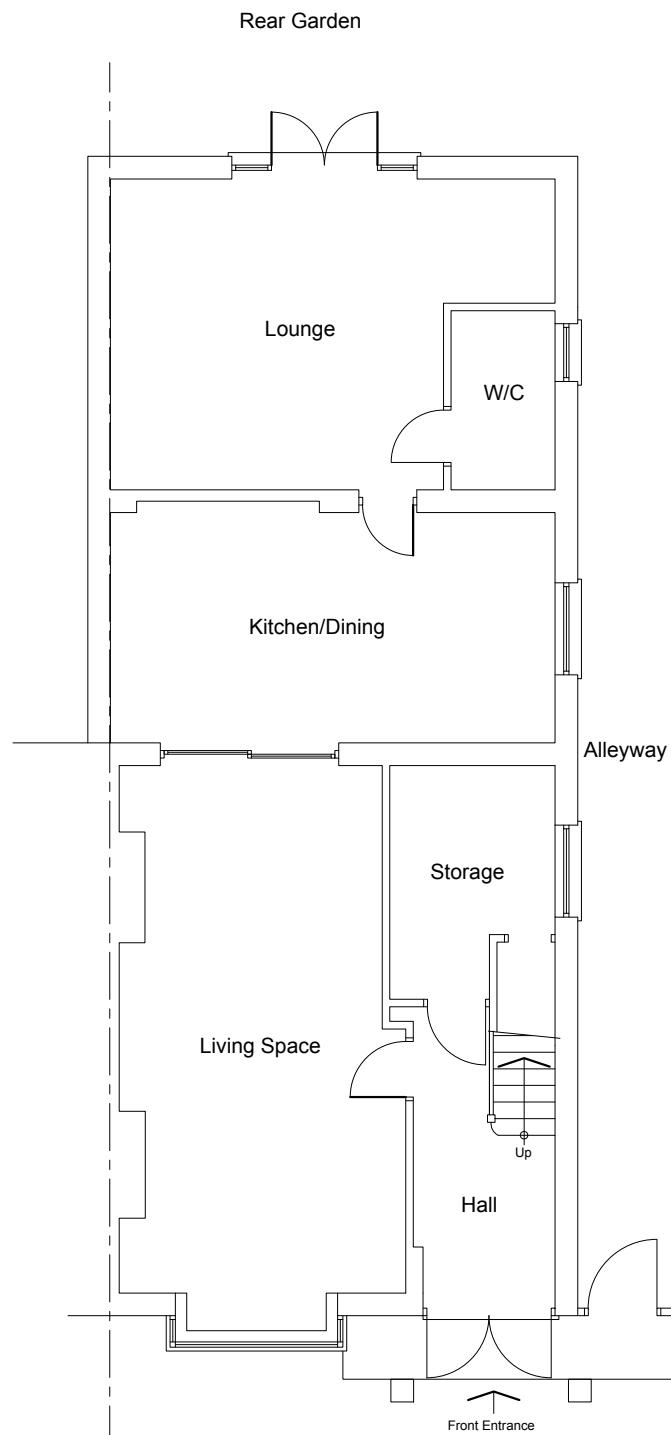

Existing Ground Floor Plan

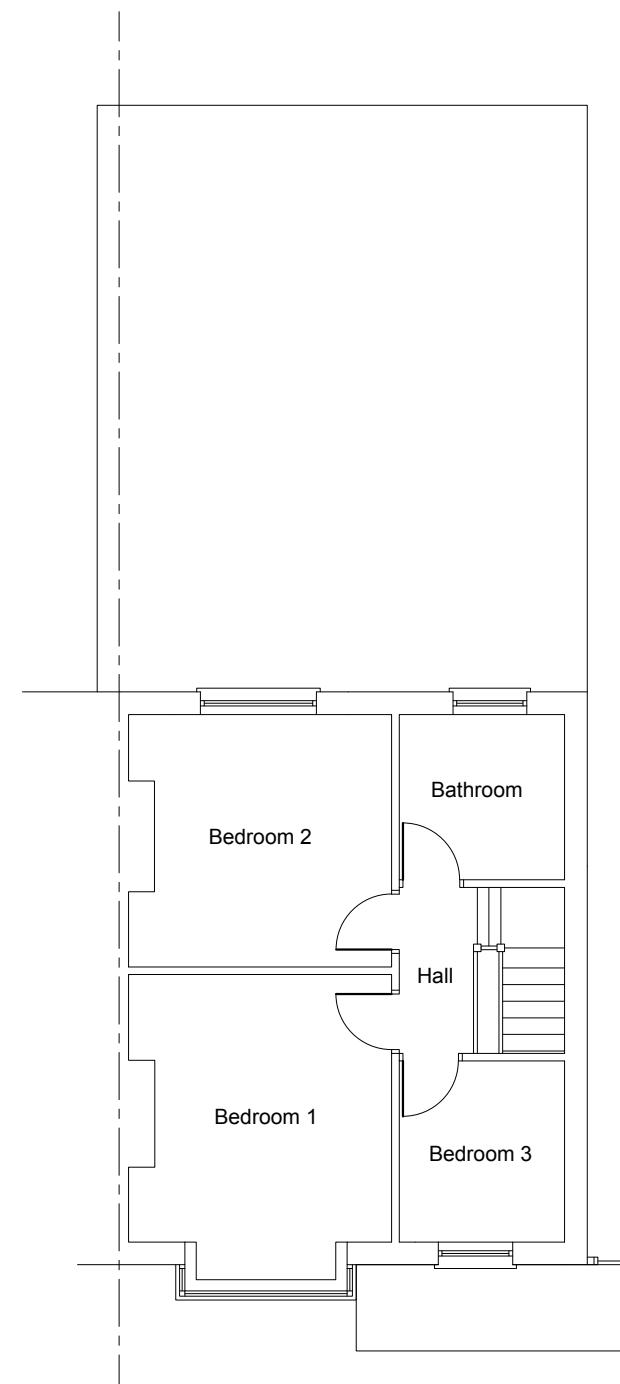

Existing First Floor Plan

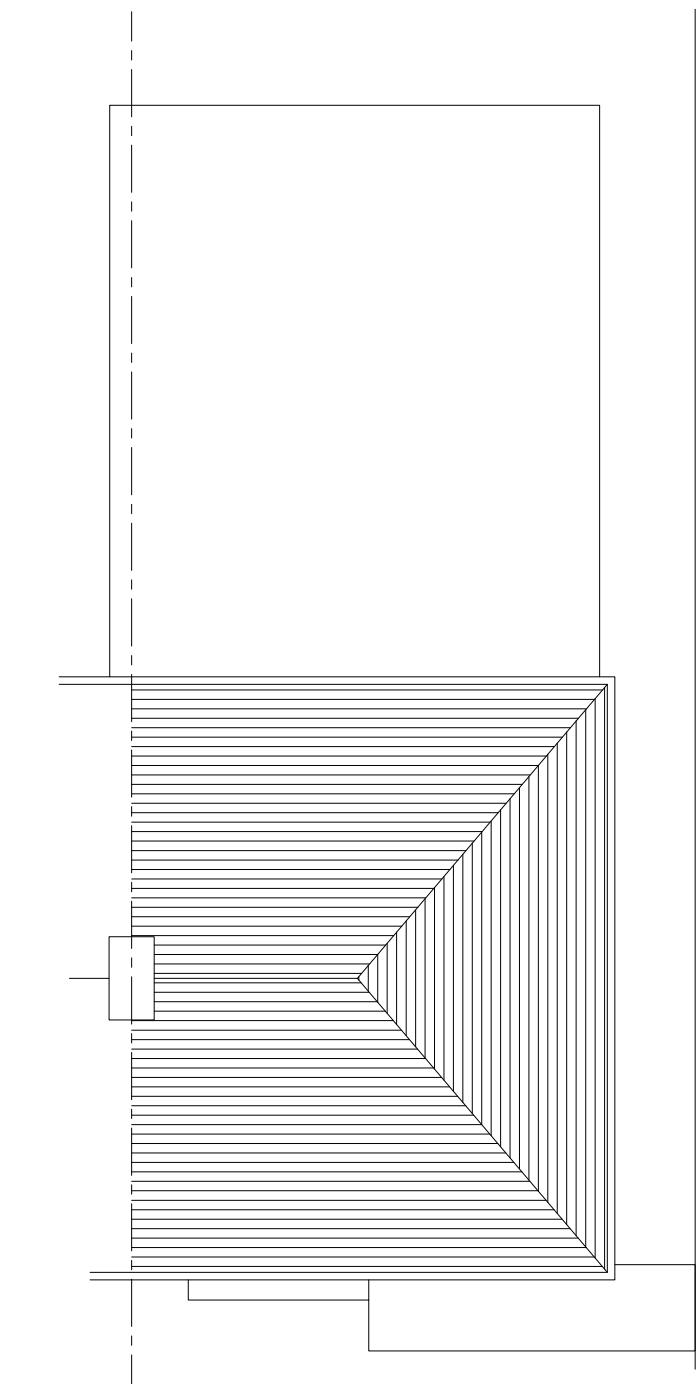

Existing Roof Plan

This is a 'Scheme Level Drawing' and is intended to illustrate the general arrangement of the project proposals. As it stands this drawing does not include all of the detail necessary for a full plans building regulations application.

While this drawing can be used as a base drawing for construction purposes, your building contractor may require more information. It is therefore important to discuss, with your architect & builder together, where more detail would be appropriate.

1. This drawing has been based upon a measured survey drawing by others. As a result, the precision of the dimensions indicated is dependent upon the information supplied.
2. While this drawing can be used as a base drawing for construction purposes, it is **VERY IMPORTANT** that all dimensions are checked carefully before any work commences or any materials are ordered.
3. This drawing can be used as part of a planning application, although your planning officer may ask for more specific information about some aspects of the design. Ask your architect for more information on planning applications.
4. Where applicable, a suitable Structural Engineer and/or a Party Wall Surveyor should be consulted. Although as far as possible these instances have been indicated, this is not necessarily exhaustive and the whole scope of proposed works should be reviewed.
5. Unless other arrangements have been specifically made, your building contractor should serve a Building Notice, as and where applicable, to your local authority to satisfy the requirements of the Building Regulations. Your building contractor should also liaise with the Building Control Officer regarding routine inspections of the work.

Further detailed design / dwgs may be needed for this section.

This symbol indicates that it may be beneficial to have more detailed design drawings prepared to illustrate elements of the proposal in more detail so that your building contractor can more fully understand the intention of the design.

You may need to consult a Party Wall Surveyor for this section.

This symbol indicates that you may need to take action in order to comply with the Party Wall Act and it may be wise to consult a suitable Party Wall surveyor. Your architect can help point you in the right direction.

Revisions:
a. date:

All dimensions are in millimetres
All dimensions to be checked on site

0 2 4 6 8 10m
SCALE: 1/100 @ A3

Project name:

47 Ashford Avenue,
Hayes, UB4 0LZ

Drawing name: Existing Floor Plans		
Job no: AH 735	Drawing no: 02	Revision: -
Scale: 1/100 @ A3	Date: 29/08/2024	Drawn by: GG

Notes:
Contractors must verify all dimensions on site before commencing any work or shop drawings. This drawing must not be scaled. Use figured dimensions only. Subject to statutory approvals and survey.

**ALL DRAWINGS 954/01-06,
AND ENGINEER'S DETAILS TO BE READ TOGETHER**

New Doors:

FD30 rated fire doors and frames; solidly built into partitions 4 panel doors - 1981x762x44mm with 32 linings and 13 stops; fix ironmongery - 1.5 pairs 100 s/s rising butt hinges;

All electrical works will be designed, installed, inspected and tested in accordance BS 7671:2001 and certified by a NIC EIC registered electrician.

Switch (900 to 1100mm above floor) & socket outlet (450 above floor) heights to comply with Part M 4.30

Installers Electrical Installation Test Certificate to be provided to Local Authority and owner on completion

Internal Wall type P1: (internal partitions)
Internal timber stud partitions framed in softwood 50x100mm as SE design. Vertical studs fixed @ max. 400mm c/c. Top and bottom rails plus horizontal noggin max 100mm c/c.
Mineral wool insulation/ (acoustic insulation) fitted tight between studs to full thickness. Tile backer board to bathroom side or MR grade gypsum plasterboard. 12.5mm gypsum board elsewhere.


Internal Wall type P2 (Fire resisting internal partitions):
As above but with 2 layers 9mm plasterboard, staggered joints, **Thickness 120 or 145mm** **Sound resistance to part E, types A & B**
Part B - Fire resistance 30min. Fire spread Class O

Floor type 3 (Loft Conversion Floor):
Floor finish / carpet by others TBC, 19 mm T&G V313 chipboard, ply or timber boards, min mass 15kg/m³, (WBP Ply in bathrooms) on treated 150x50mm softwood joists @ 400 centres TBC. Joists beside existing ceiling joists loaded onto central load bearing wall.
Fill gap with mineral wool, min density 10kg/m³, to min 100mm deep.

Use FR caps to light fittings Floor boards to be screwed with occasional screw fixings to the joists to prevent squeaking. Test before laying any floor finishes.

Wall type E12: new timber frame tiled dormer face
New tiles as per elevation drawings clay tiles to match existing lapped 100mm on 25x38mm treated s.w. battens on counter battens, on 'Tyvek Supro' breather membrane, on 19mm OSB, on 50x125 mm treated soft wood studs @ 400 c/c with 100mm celotex 'FR5000' insulation fitted tight between studs line with 57.5mm celotex 'PL4000' linerboard with joints taped as VCL+ air leakage barrier skim finish.
(double studs around window openings.) **U-value = 0.18 W/m²K**

Flat Roof type 2
Warm deck flat roof:
grey single ply membrane flat roof or fiberglass roof bonded to 19mm OSB, 120mm roof insulation fixings to fall 1/40 on SC3 50x150mm s.w. joists @ 400 centers
Mineral wool insulation between joists 12.5mm plaster board and skim finish.
U-value = 0.15 W/m²K

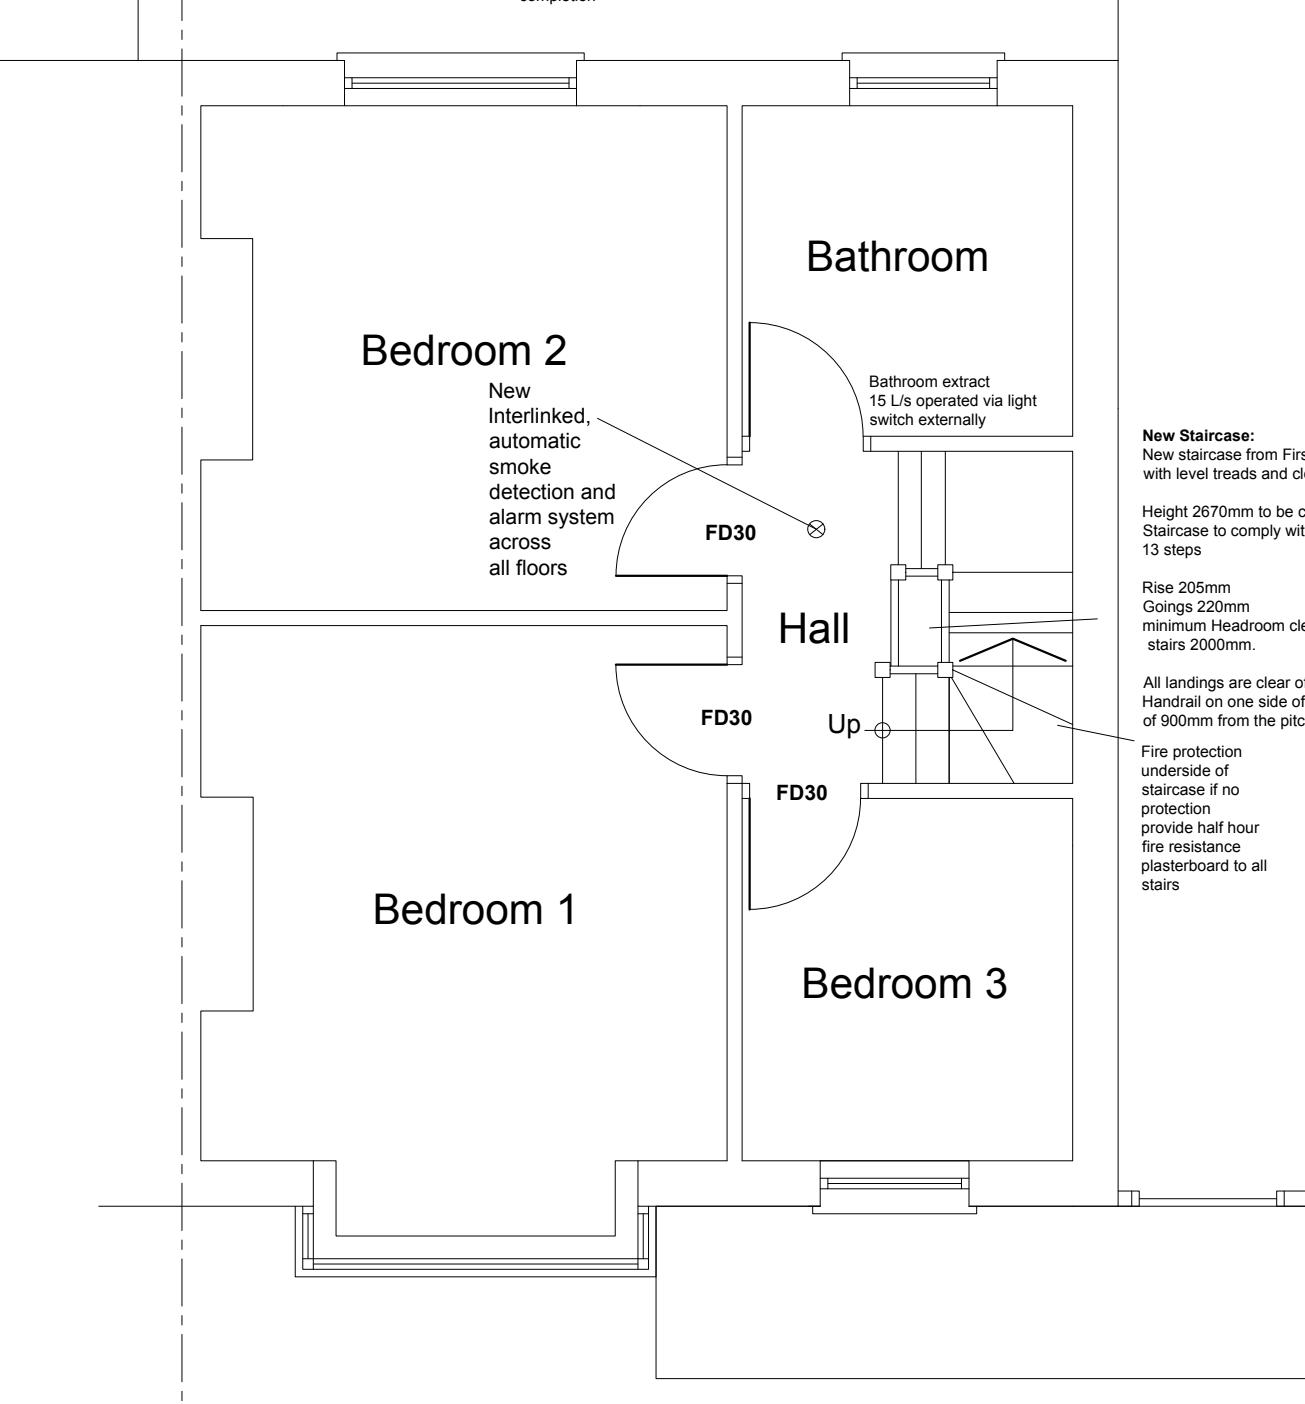

Proposed First Floor Plan (1:50)


This is a 'Scheme Level Drawing' and is intended to illustrate the general arrangement of the project proposals. As it stands this drawing does not include all of the detail necessary for a full plans building regulations application.

While this drawing can be used as a base drawing for construction purposes, your building contractor may require more information. It is therefore important to discuss, with your architect & builder together, where more detail would be appropriate.

- This drawing has been based upon a measured survey drawing by others. As a result, the precision of the dimensions indicated is dependent upon the information supplied.
- While this drawing can be used as a base drawing for construction purposes, it is **VERY IMPORTANT** that all dimensions are checked carefully before any work commences or any materials are ordered.
- This drawing can be used as part of a planning application, although your planning officer may ask for more specific information about some aspects of the design. Ask your architect for more information on planning applications.
- Where applicable, a suitable Structural Engineer and/or a Party Wall Surveyor should be consulted. Although as far as possible these instances have been indicated, this is not necessarily exhaustive and the whole scope of proposed works should be reviewed.

- Unless other arrangements have been specifically made, your building contractor should serve a Building Notice, as and where applicable, to your local authority to satisfy the requirements of the Building Regulations. Your building contractor should also liaise with the Building Control Officer regarding routine inspections of the work.
- You may need a Structural Engineer for this section.
- This symbol indicates that it may be beneficial to have more detailed design drawings prepared to illustrate elements of the proposal in more detail so that your building contractor can more fully understand the intention of the design.
- You may need to consult a Party Wall Surveyor for this section.

- This symbol indicates that structural calculations / structural design may be required, both of which should be undertaken by a suitable structural engineer. Your architect can help point you in the right direction.
- This symbol indicates that you may need to take action in order to comply with the Party Wall Act and it may be wise to consult a suitable Party Wall surveyor. Your architect can help point you in the right direction.
- Revisions: a. date.
- All dimensions are in millimetres
All dimensions to be checked on site

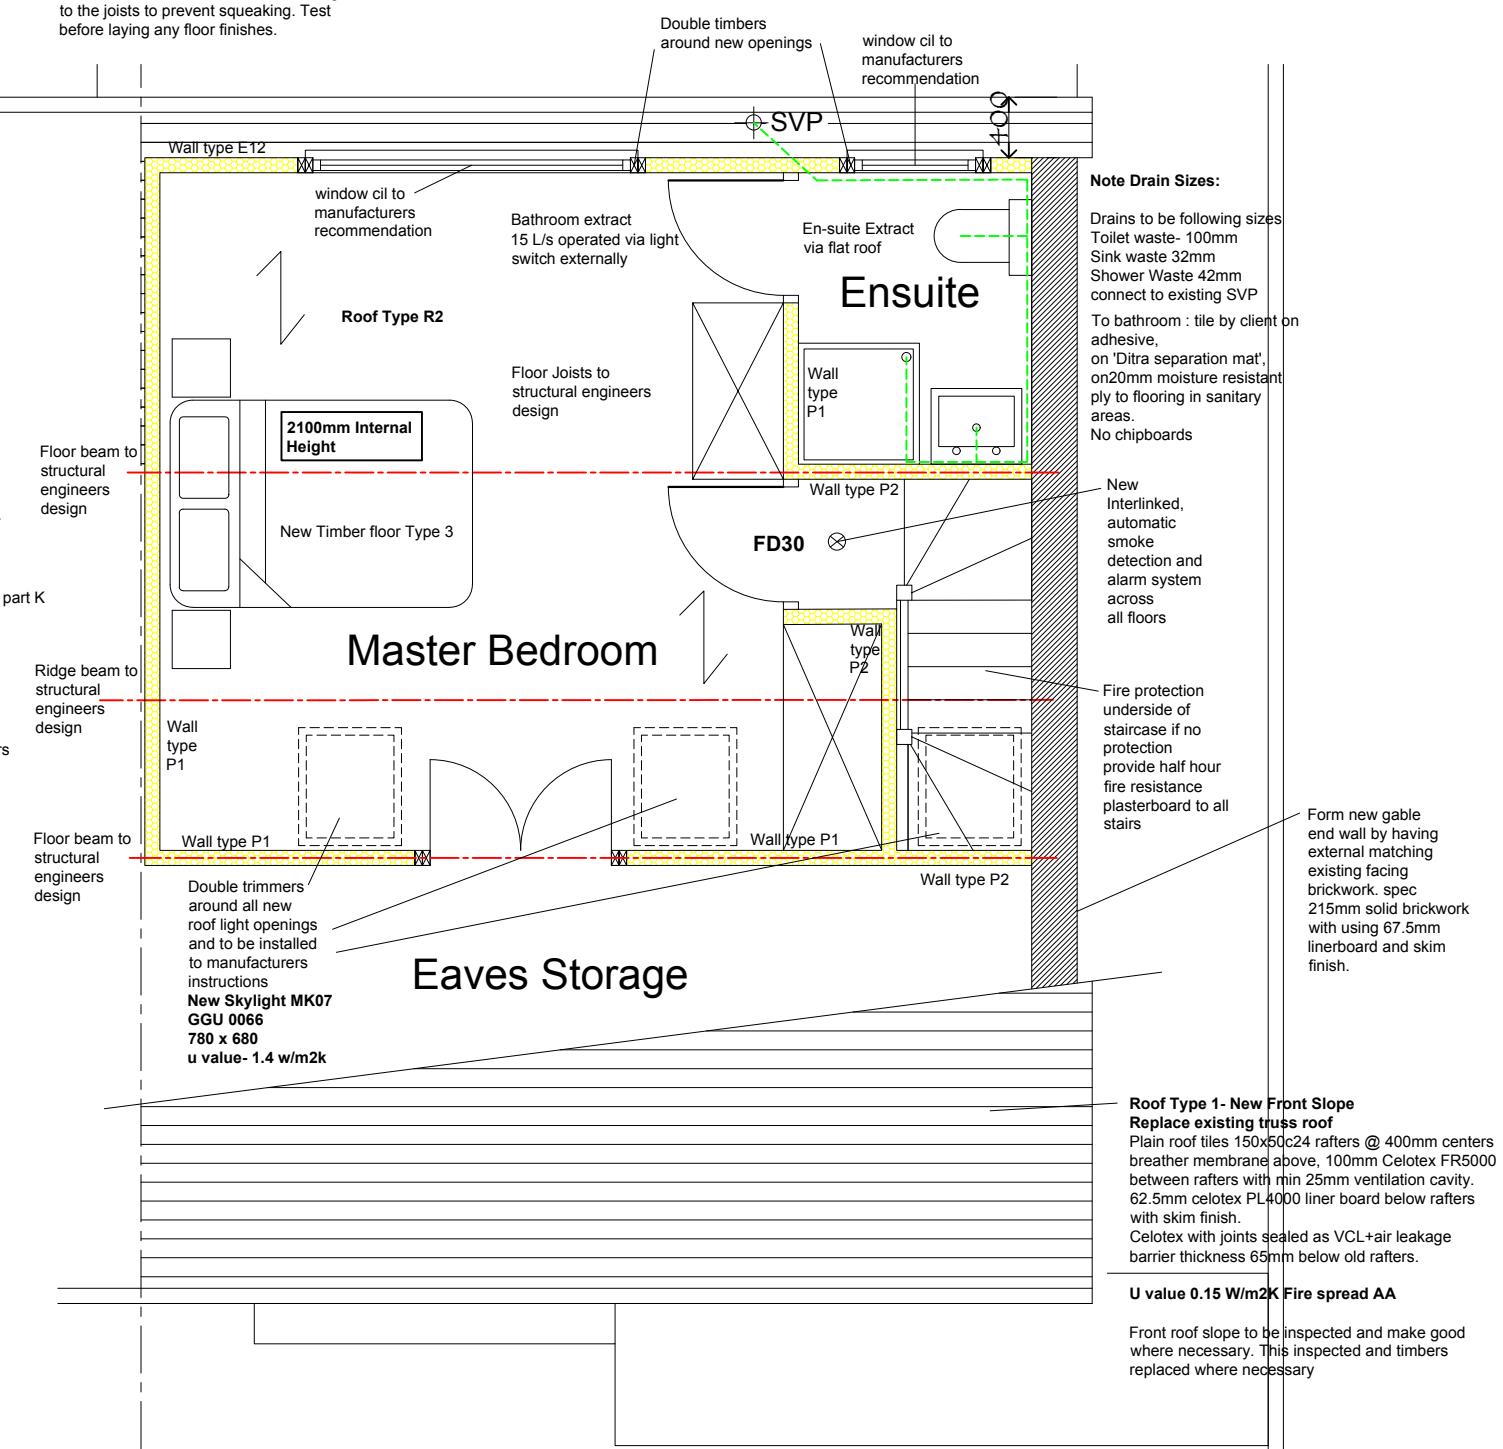


Proposed Second Floor Plan (1:50)

0 1 2 3 4 5m
SCALE: 1/50 @ A3


Project name:

Drawing name: Proposed Floor Plans		
Job no: AH 735	Drawing no: 03	Revision: -
Scale: 1/50 @ A3	Date: 29/08/2024	Drawn by: GG


Notes:
Contractors must verify all dimensions on site before commencing any work or shop drawings. This drawing must not be scaled. Use figured dimensions only. Subject to statutory approvals and survey.

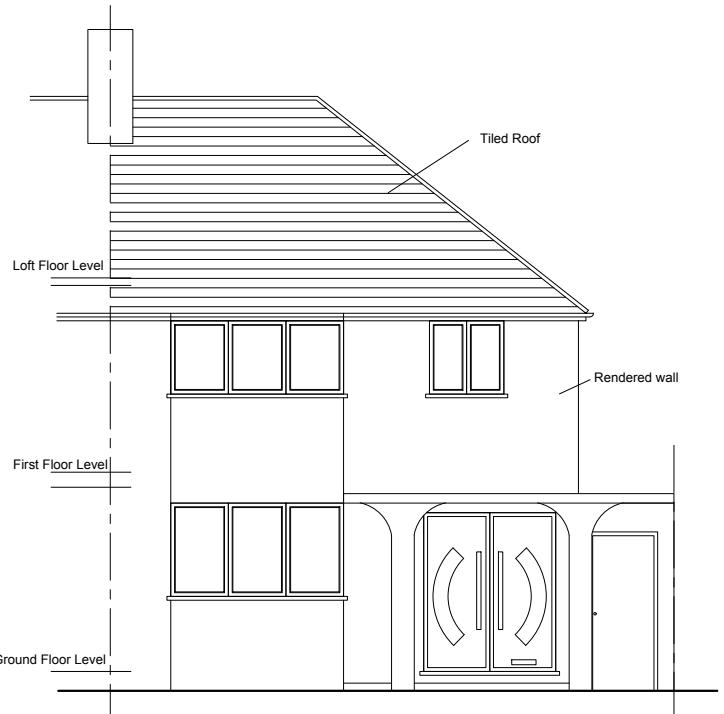


Existing Front Elevation

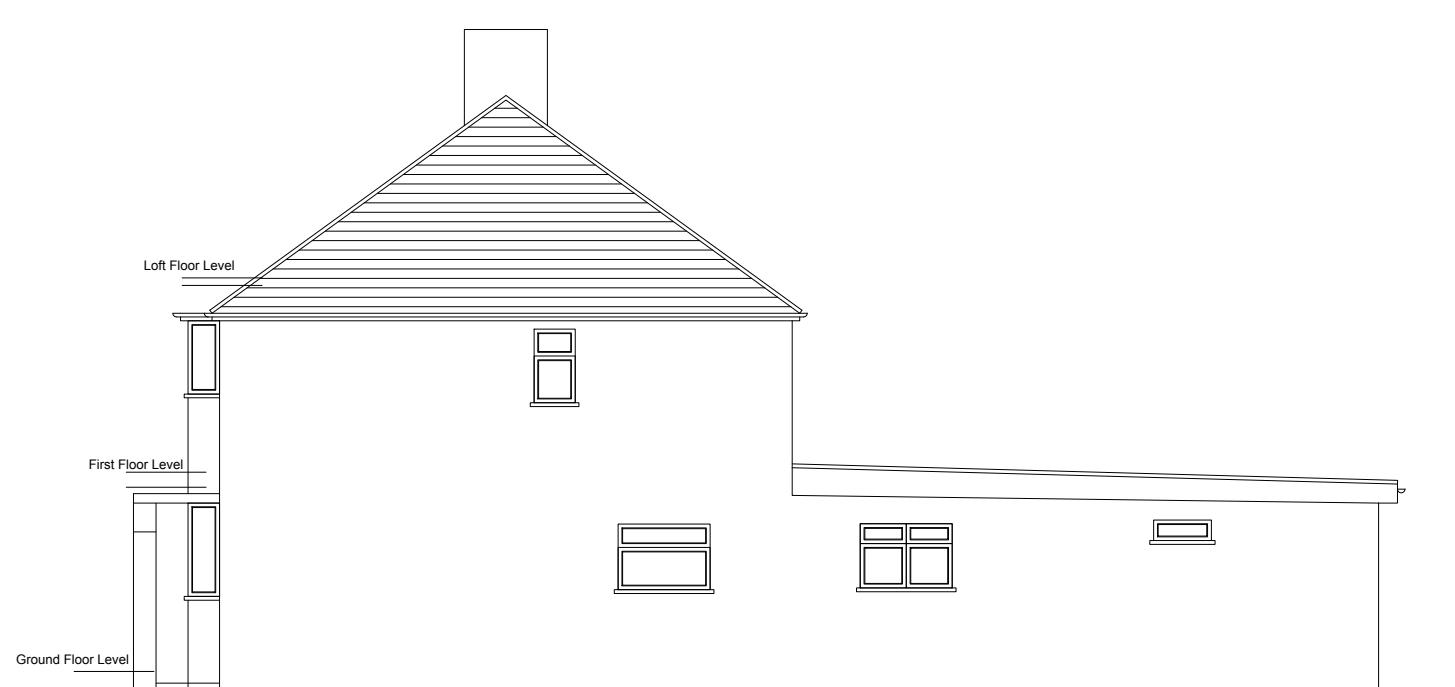


Existing Side Elevation

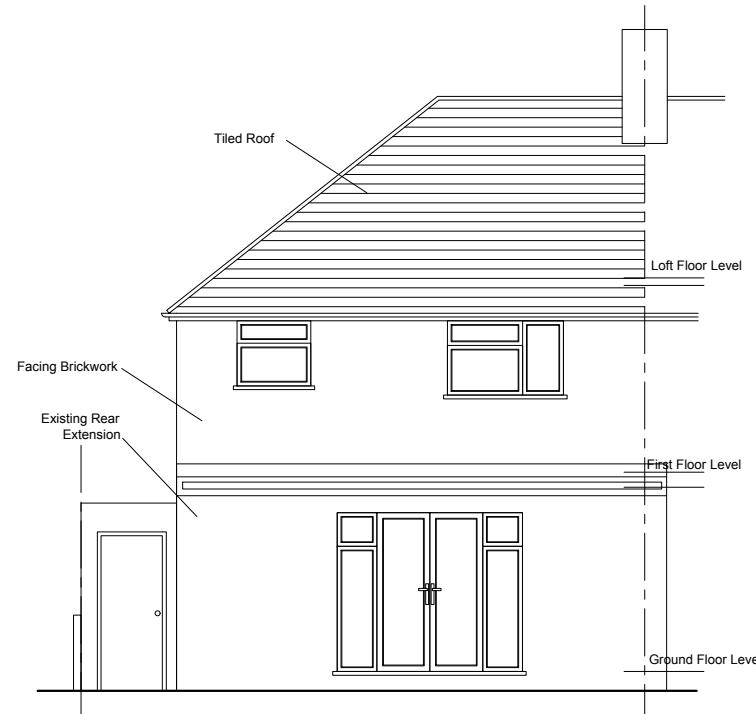


Existing Rear Elevation

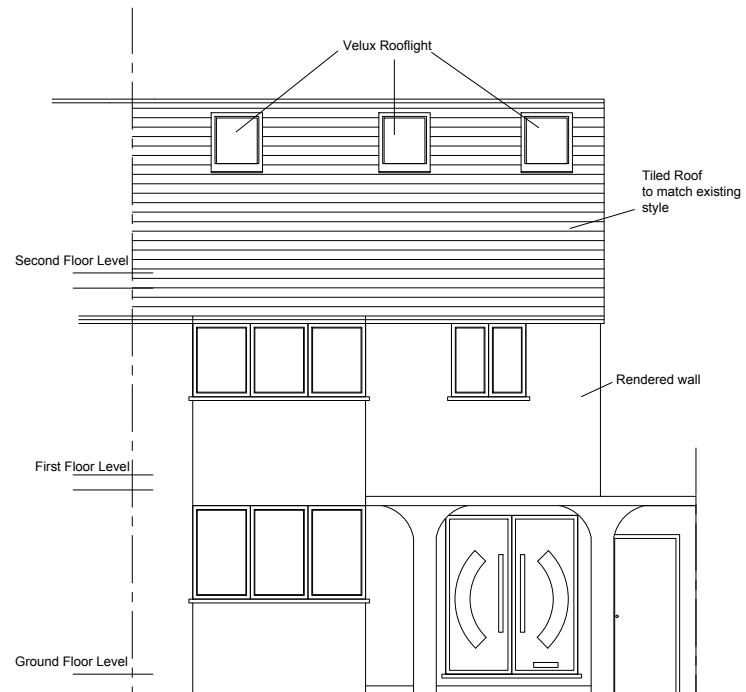

Proposed Front Elevation

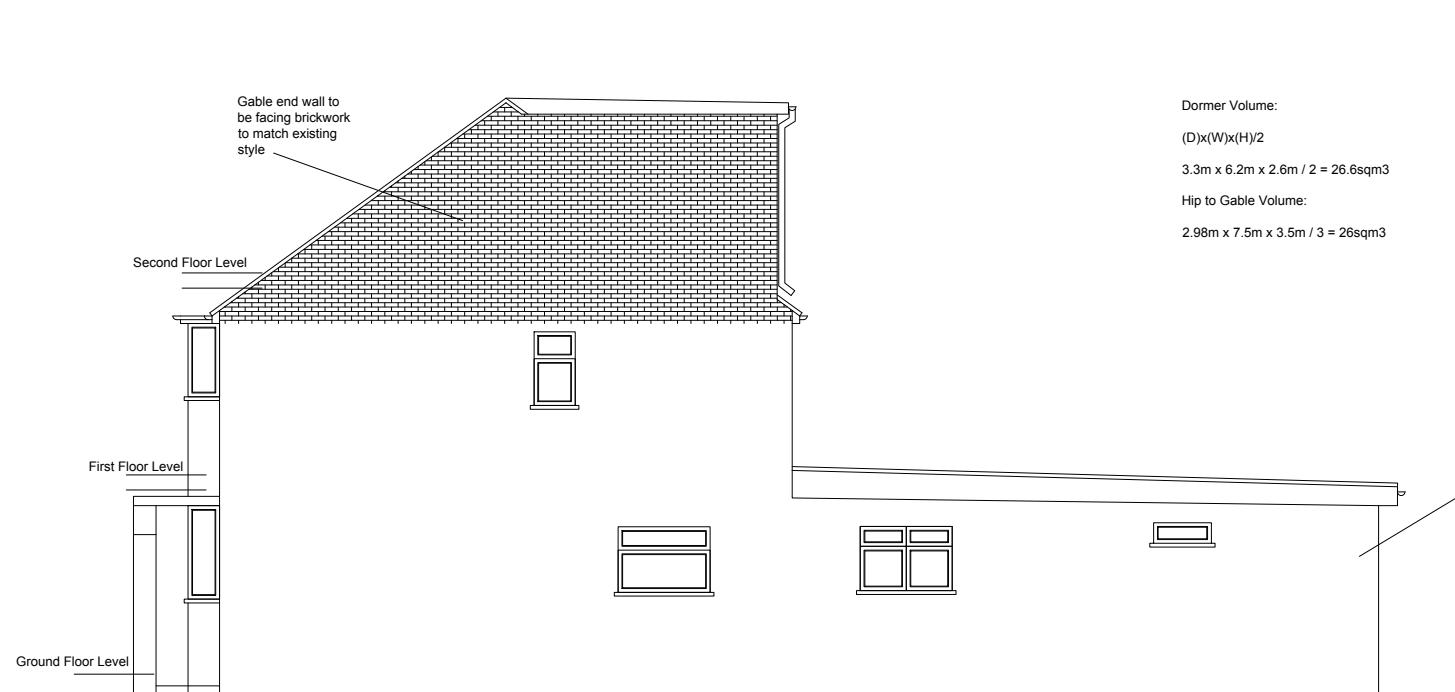

Proposed Side Elevation

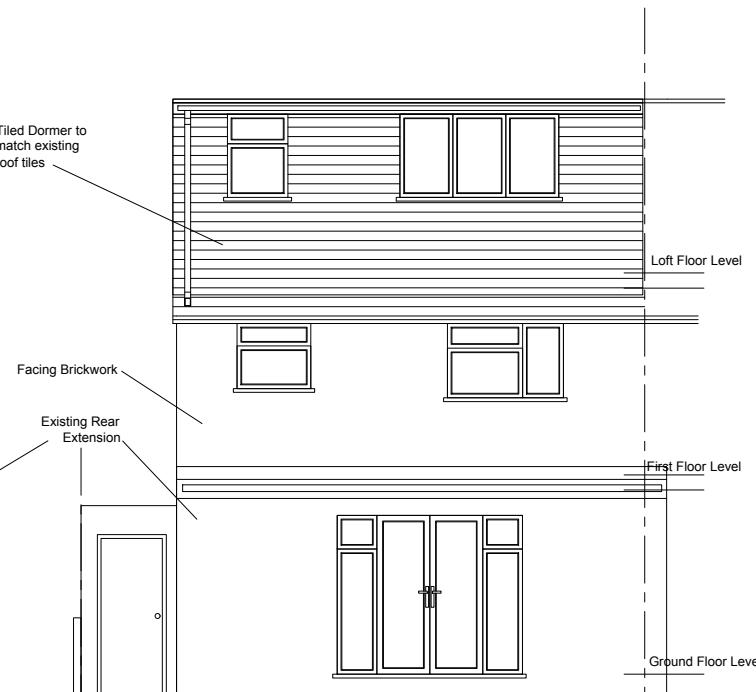

Proposed Rear Elevation

This is a 'Scheme Level Drawing' and is intended to illustrate the general arrangement of the project proposals. As it stands this drawing does not include all of the detail necessary for a full plans building regulations application.

While this drawing can be used as a base drawing for construction purposes, your building contractor may require more information. It is therefore important to discuss, with your architect & builder together, where more detail would be appropriate.

1. This drawing has been based upon a measured survey drawing by others. As a result, the precision of the dimensions indicated is dependent upon the information supplied.
2. While this drawing can be used as a base drawing for construction purposes, it is **VERY IMPORTANT** that all dimensions are checked carefully before any work commences or any materials are ordered.
3. This drawing can be used as part of a planning application, although your planning officer may ask for more specific information about some aspects of the design. Ask your architect for more information on planning applications.
4. Where applicable, a suitable Structural Engineer and/or a Party Wall Surveyor should be consulted. Although as far as possible these instances have been indicated, this is not necessarily exhaustive and the whole scope of proposed works should be reviewed.

5. Unless other arrangements have been specifically made, your building contractor should serve a Building Notice, as and where applicable, to your local authority to satisfy the requirements of the Building Regulations. Your building contractor should also liaise with the Building Control Officer regarding routine inspections of the work.

Further detailed design / dwgs may be needed for this section.

This symbol indicates that it may be beneficial to have more detailed design drawings prepared to illustrate elements of the proposal in more detail so that your building contractor can more fully understand the intention of the design.

You may need to consult a Party Wall Surveyor for this section.

This symbol indicates that you may need to take action in order to comply with the Party Wall Act and it may be wise to consult a suitable Party Wall surveyor. Your architect can help point you in the right direction.

You may need a Structural Engineer for this section.

This symbol indicates that structural calculations / structural design may be required, both of which should be undertaken by a suitable structural engineer. Your architect can help point you in the right direction.

Revisions:

a. date.

0 2 4 6 8 10m
SCALE: 1/100 @ A3

Project name:

47 Ashford Avenue,
Hayes, UB4 0LZ

Drawing name: Existing & Proposed Elevations		
Job no:	Drawing no:	Revision:
AH 735	04	-
Scale: 1/100 @ A3	Date: 29/08/2024	Drawn by: GG

All dimensions are in millimetres
All dimensions to be checked on site