




Hip to Gable	Volume	$8.02 \times 2.57/2 \times 3.96 / 3 = 13.6 \text{ m}^3$
Dormer	Volume	$3.96 \times 2.57 / 2 \times 6.05 = 30.78 \text{ m}^3$
Total Added Volume		44.38 $\text{m}^3$

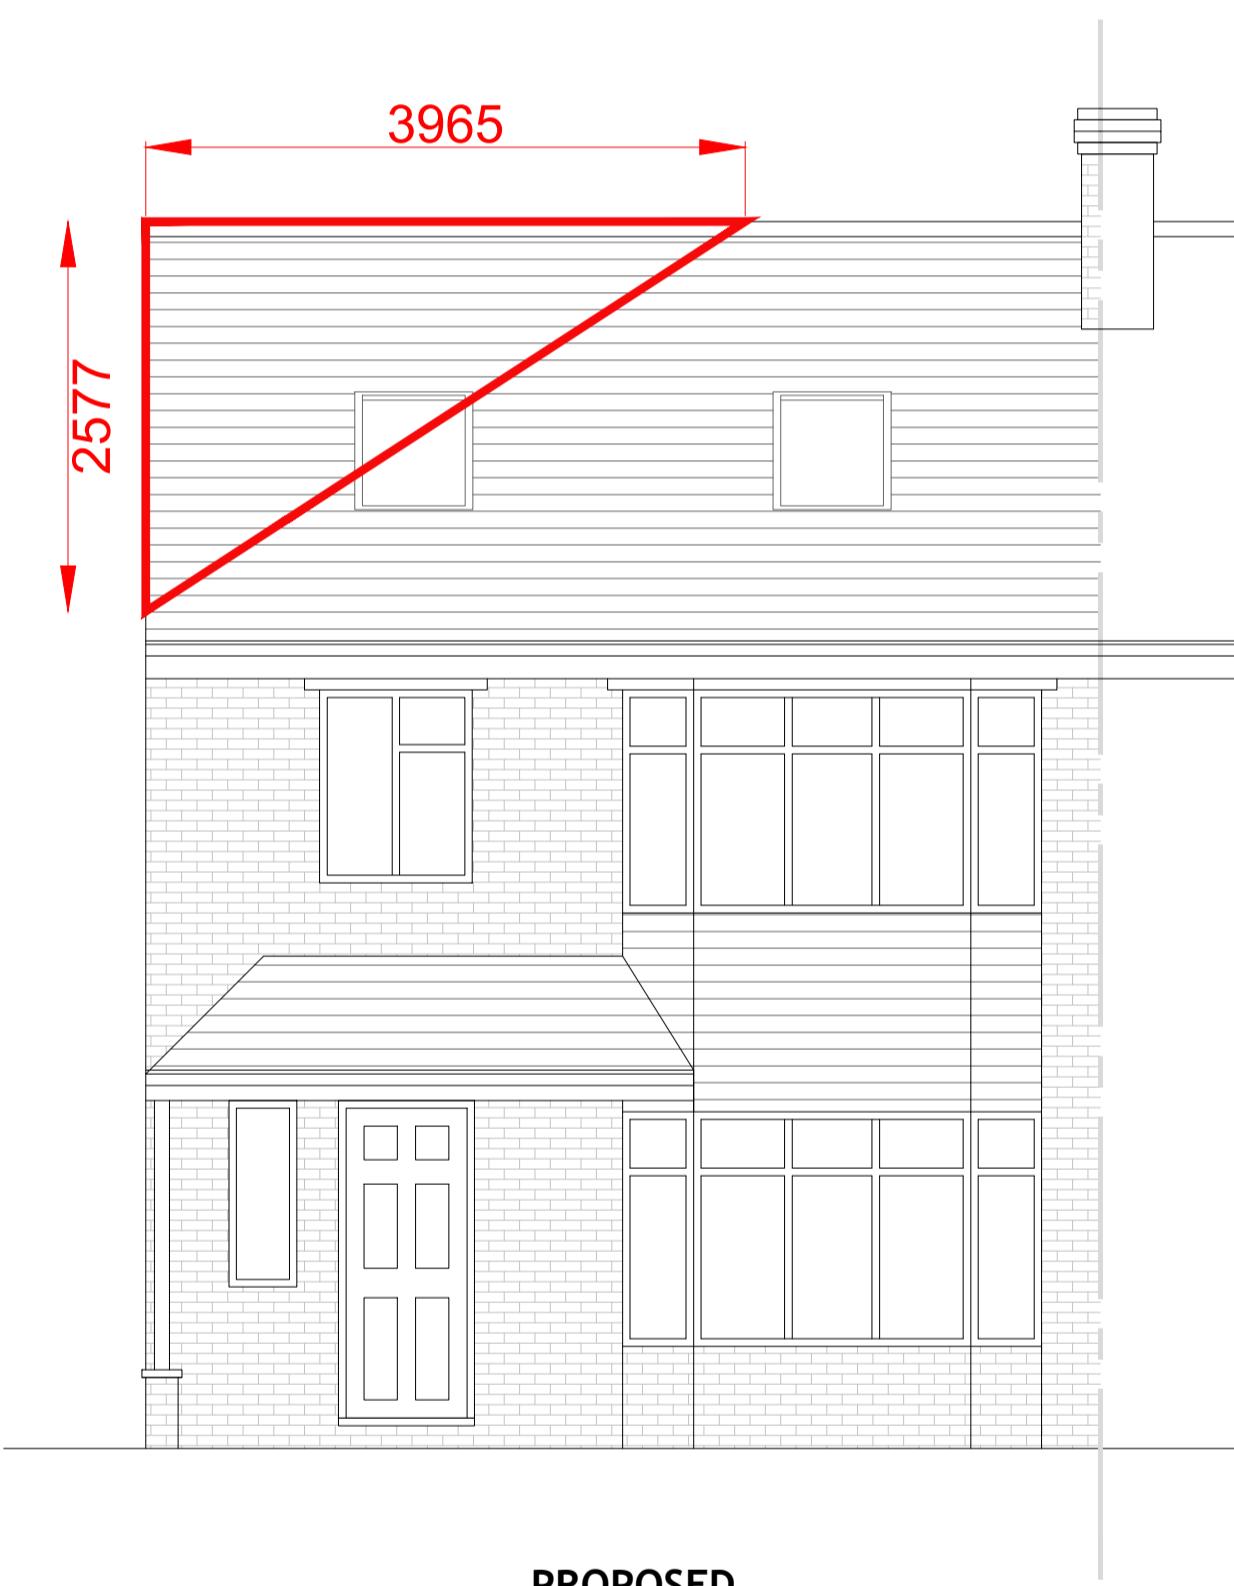


**PROPOSED**  
FRONT ELEVATION - VOLUME CALCULATIONS  
SCALE 1:50

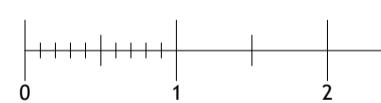

**PROPOSED**  
REAR ELEVATION - VOLUME CALCULATIONS  
SCALE 1:50

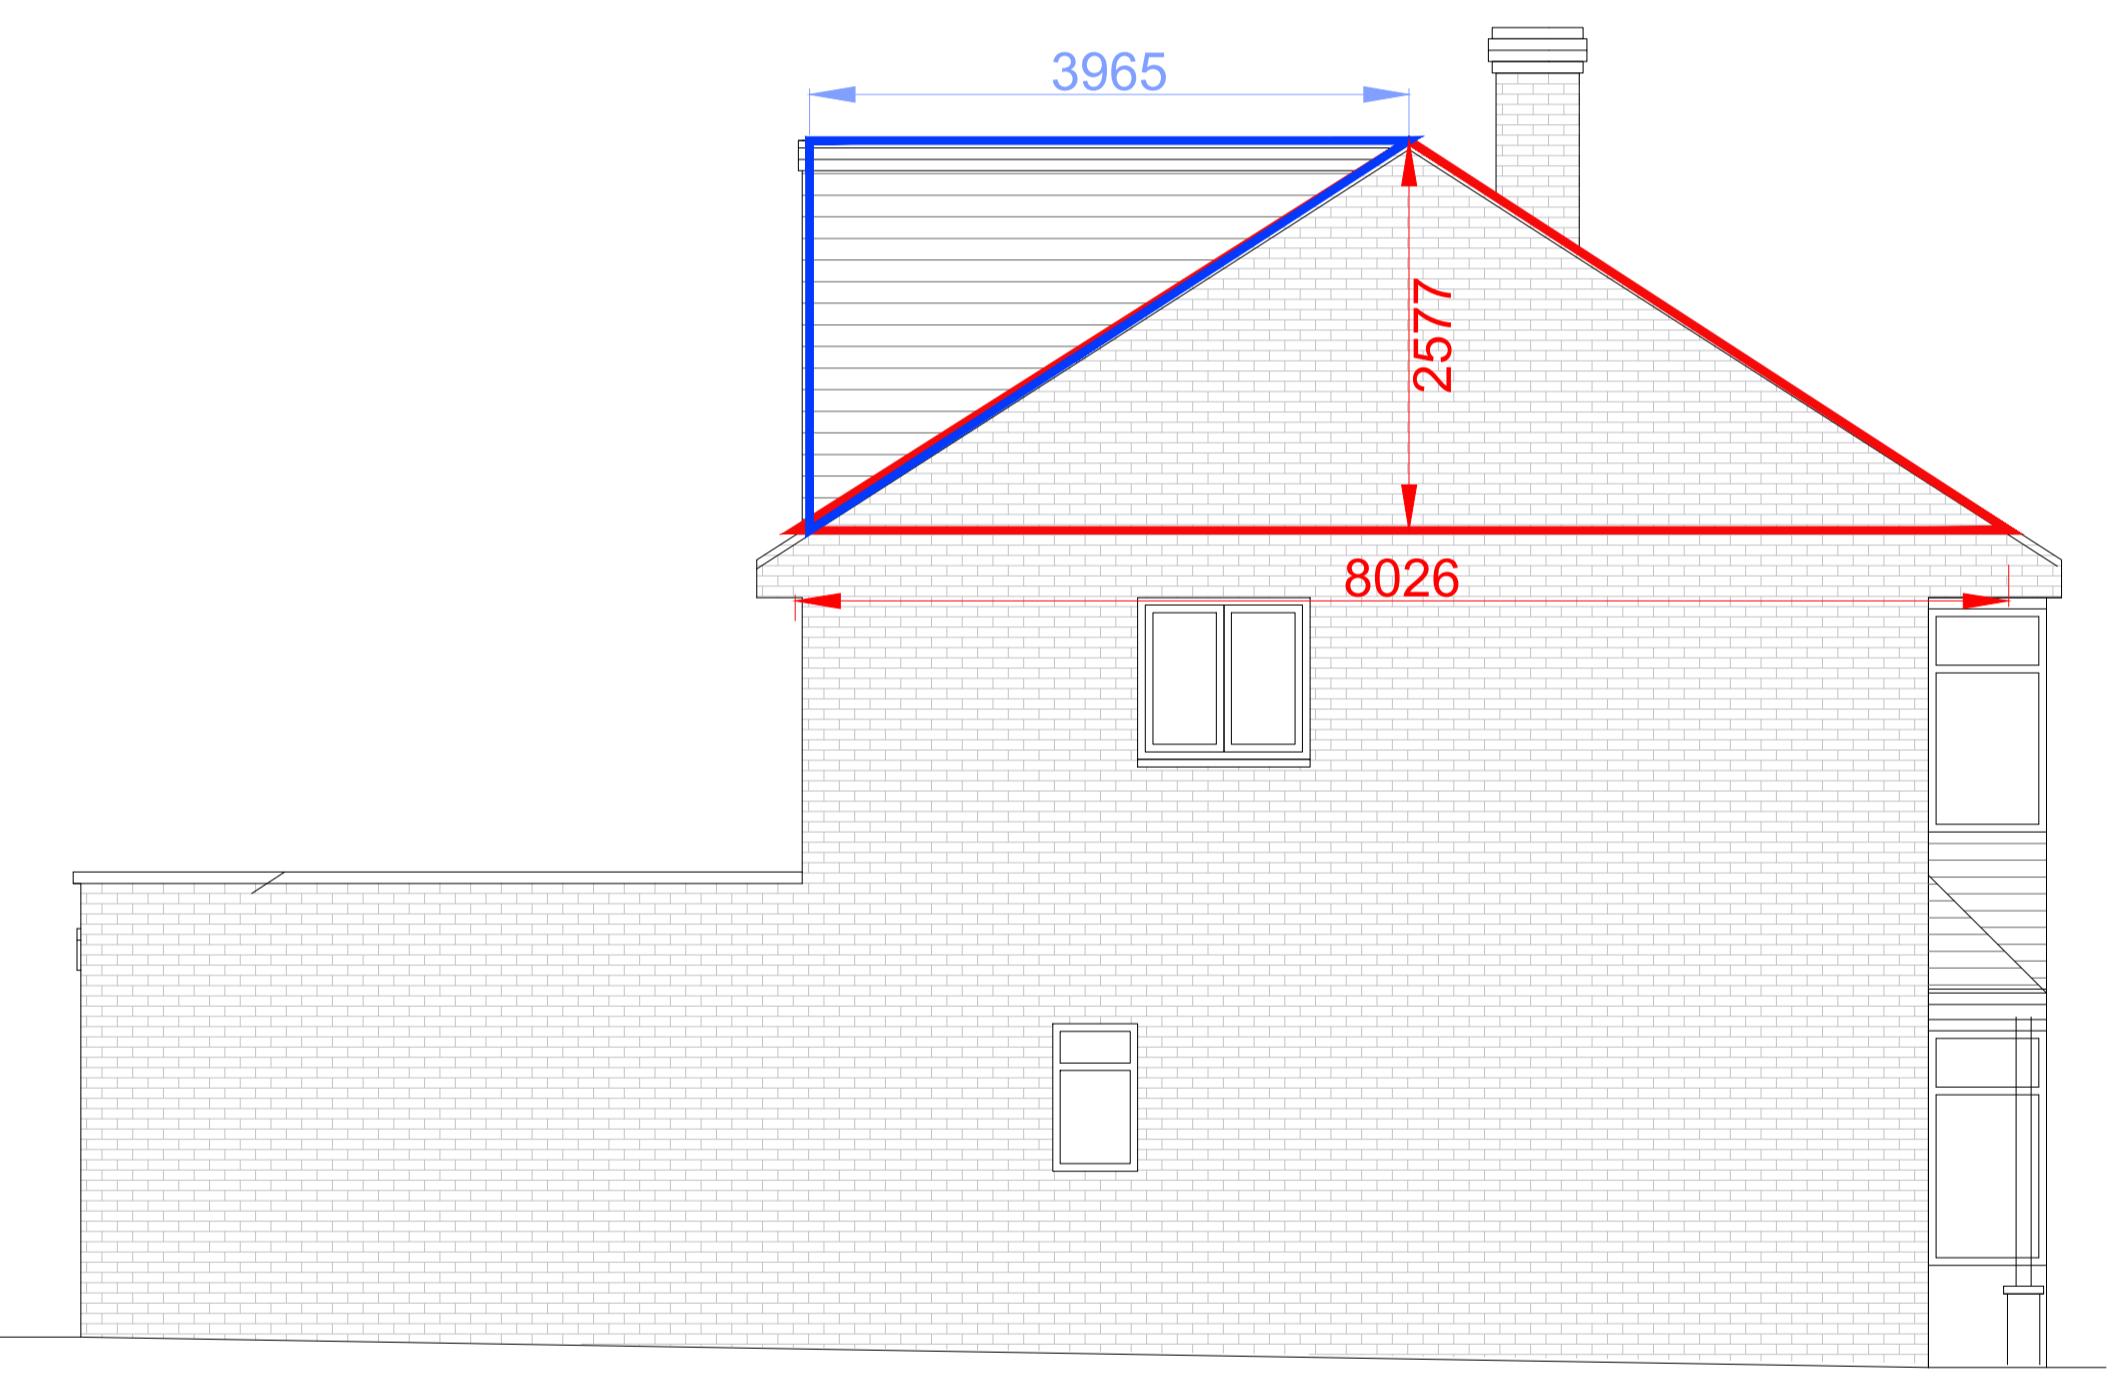

**PROPOSED**  
SIDE ELEVATION - VOLUME CALCULATIONS  
SCALE 1:50

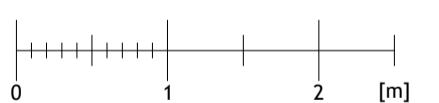

NO. DR. INFO  
DATE  
REVISION

PROJECT  
74. EDINBURGH DRIVE  
ICKENHAM, UXBRIDGE,  
UB10 8QZ

CLIENT

DRAWING TITLE  
VOLUME CALCULATIONS

SCALE 1:50 1:100  
SIZE A1 A3  
JOB NO. 202388  
STAGE PLANNING  
DWG NO. 202388.P.303  
REVISION  
DATE OCTOBER 2023  
DRAWN MB  
CHECKED MB