


Existing Ground Floor Plan


Scale 1:100



Existing Front Elevation
Scale 1:100

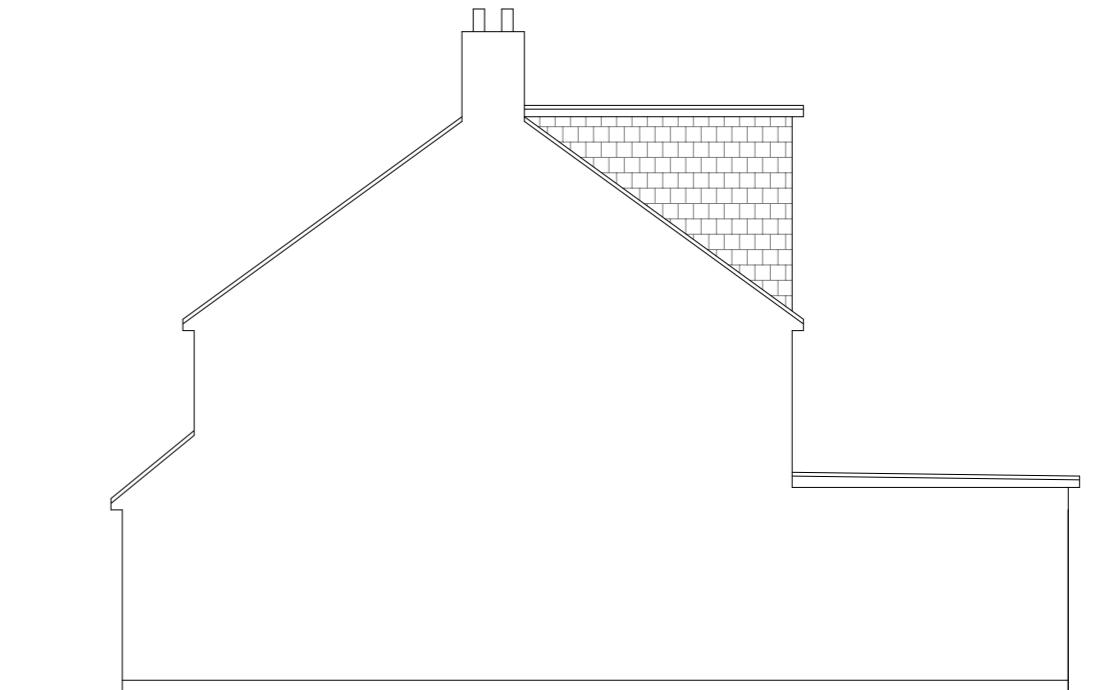

Existing Side Elevation
Scale 1:100

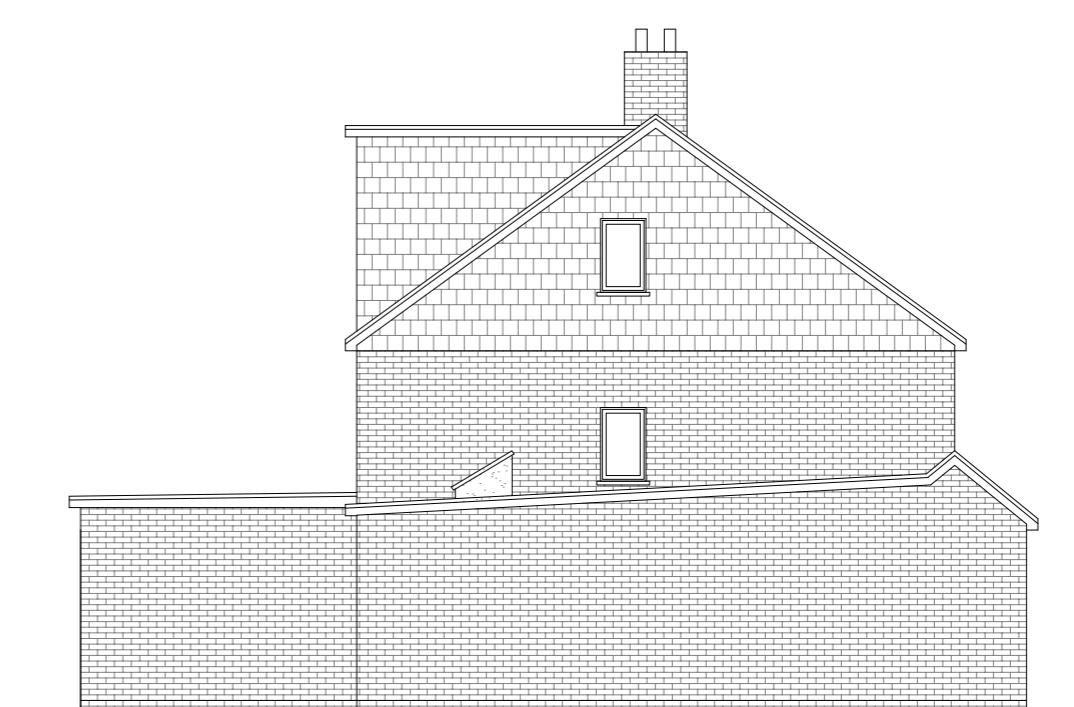

Existing Rear Elevation
Scale 1:100

Existing Side Elevation
Scale 1:100

10 Meter
5
2
1
0
1:100

GENERAL NOTES:
 1. ALL DIMENSIONS ARE IN MILLIMETER.
 2. VERIFY ALL DIMENSIONS AND CONDITIONS BEFORE BUILDING OR
 STARTING CONSTRUCTION. NOTIFY THE DESIGNER IMMEDIATELY OF ANY
 DISCREPANCY OR VARIATION.
 3. ALL WORK TO COMPLY WITH CURRENT BUILDING REGULATIONS
 AND CODES OF PRACTICE

Title:


Existing Ground Floor Plan & Elevations

Site Address
107 Grosvenor
Avenue, Hayes.
UB4 8NP

Scale: 1:100 @A3
Date: 28/08/2024
Drawing No.: 2024/123 -01
Drawn By:
RO

Revision Date:

e:mail -
faluckpatel@yahoo.com
(M) +44 (0) 7871 466 254

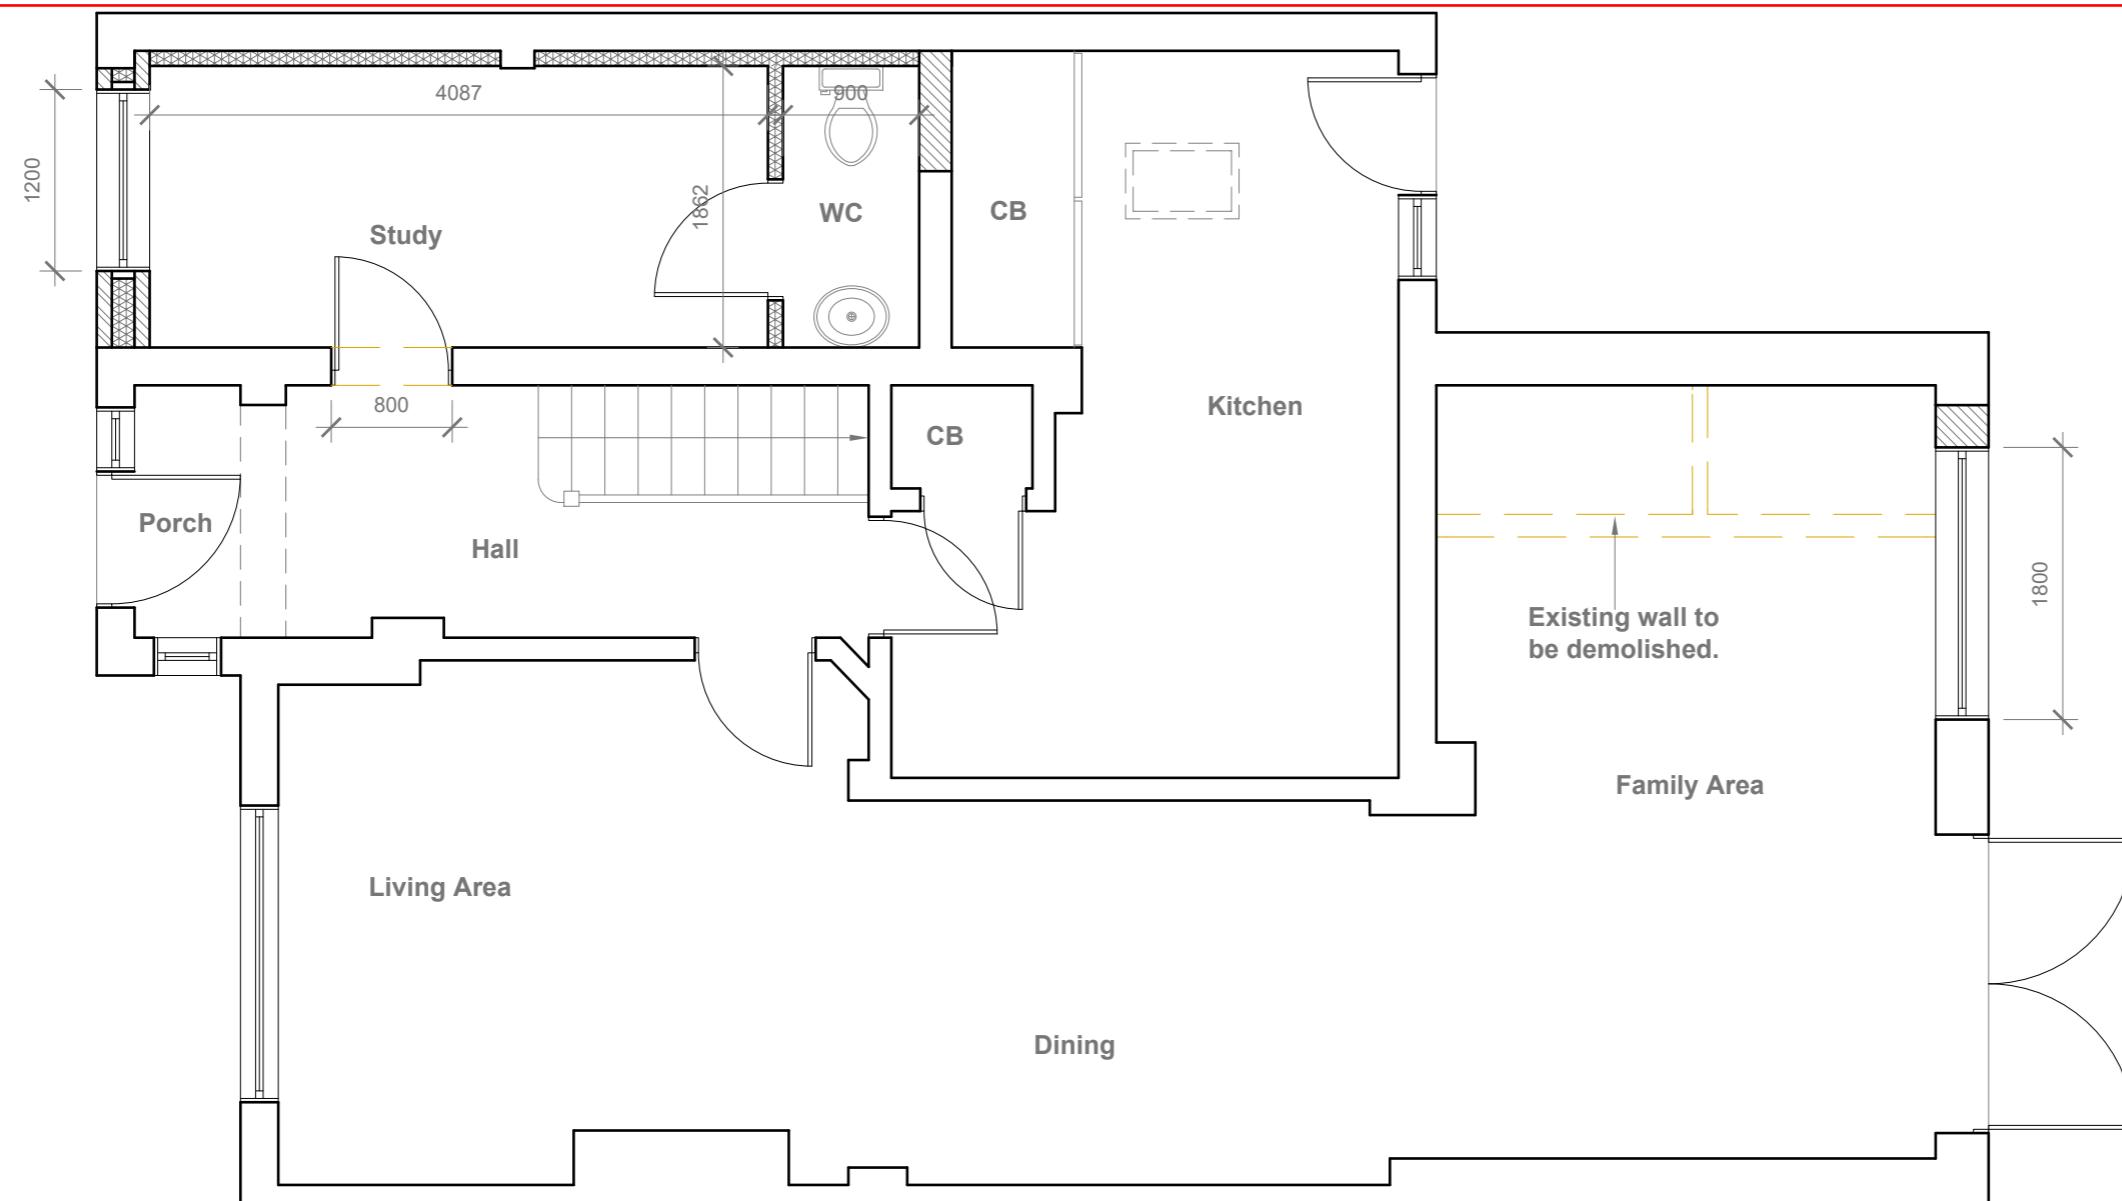

Proposed Ground Floor Plan

Scale 1:50

GENERAL NOTES:

1. ALL DIMENSIONS ARE IN MILLIMETER.
2. VERIFY ALL DIMENSIONS AND CONDITIONS
STARTING CONSTRUCTION. NOTIFY THE
DISCREPANCY OR VARIATION.
3. ALL WORK TO COMPLY WITH CURRENT
AND CODES OF PRACTICE

Title

Proposed Ground Floor Plan

Site Address
107 Grosvenor Avenue, Hayes. UB4 8NP


Scale: 1:50 @A3	R
Date: 28/08/2024	
Drawing No.: 2024/123 -02	

vision Date:

aluck ate



Proposed Front Elevation
Scale 1:100

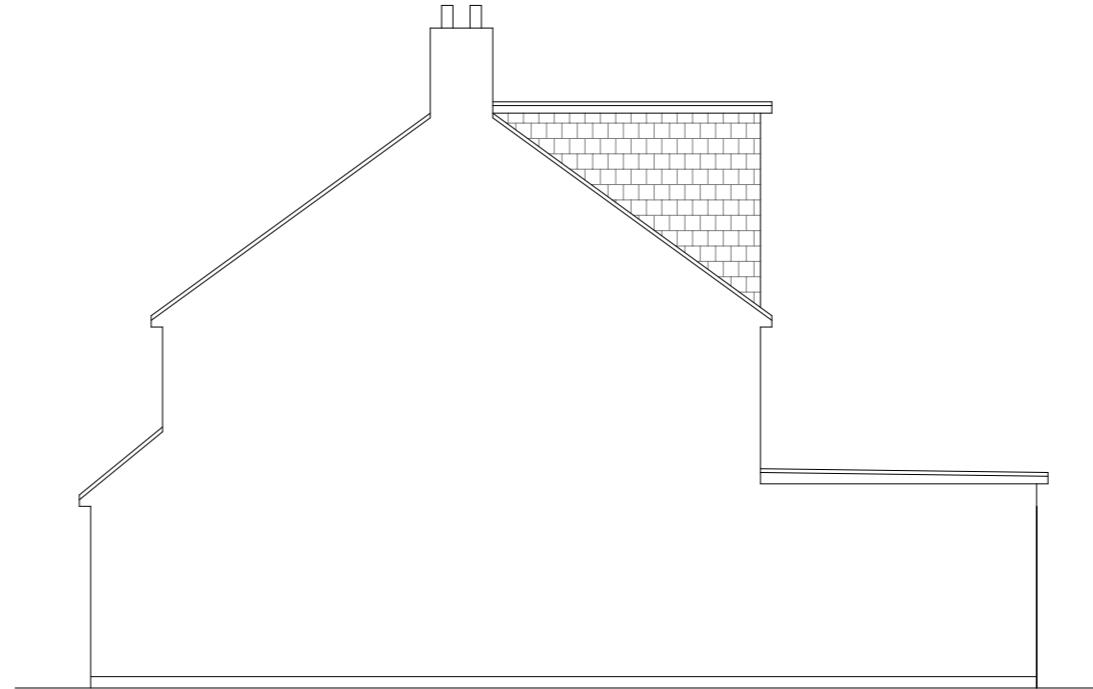


Proposed Side Elevation
Scale 1:100



Proposed Rear Elevation
Scale 1:100

Proposed External Finish Materials to Match Existing External Finish Materials

Proposed Flank Wall Window to be Obscure Glazed and Non Opening below 1.7m from FFL

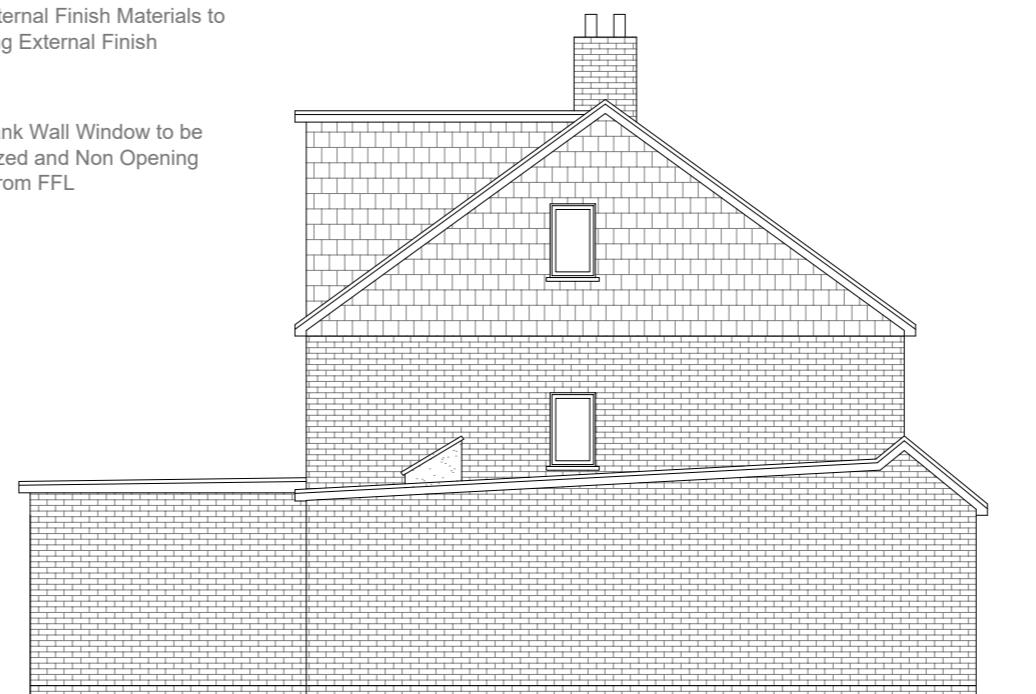

Proposed Side Elevation
Scale 1:100

10 Meter
5
2
1
0
1:100

GENERAL NOTES:
1. ALL DIMENSIONS ARE IN MILLIMETER.
2. VERIFY ALL DIMENSIONS AND CONDITIONS BEFORE BUILDING OR STARTING CONSTRUCTION. NOTIFY THE DESIGNER IMMEDIATELY OF ANY DISCREPANCY OR VARIATION.
3. ALL WORK TO COMPLY WITH CURRENT BUILDING REGULATIONS AND CODES OF PRACTICE

Title:

Proposed Elevations

Site Address
107 Grosvenor Avenue, Hayes. UB4 8NP

Scale: 1:100 @A3
Date: 28/08/2024
Drawing No.: 2024/123 -03
Drawn By: RO

Revision Date:

e:mail - faluckpatel@yahoo.com
(M) +44 (0) 7871 466 254