



Note: This Drawing is for planning purpose and should not be used for construction.
All dimensions should be confirmed on site and any deviation should be reported back to designer.

BW Brick Work

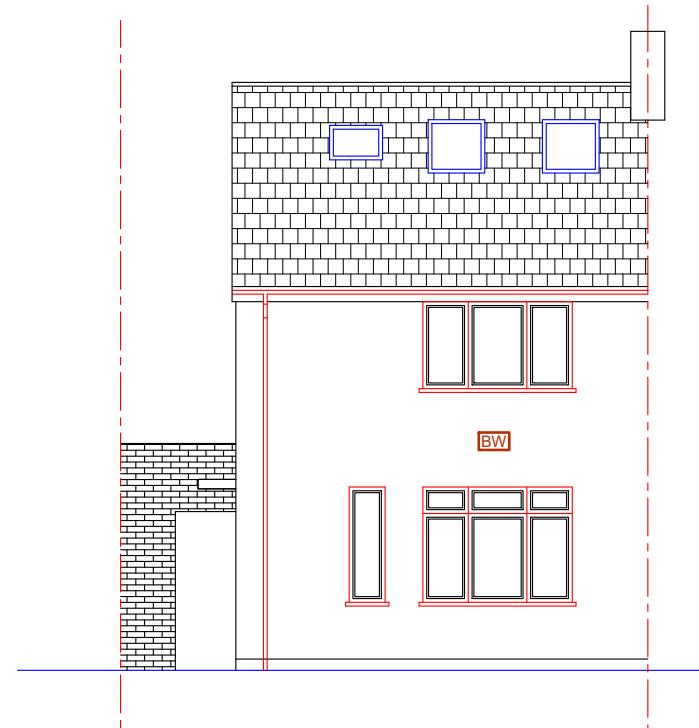

Proposed Front Elevation

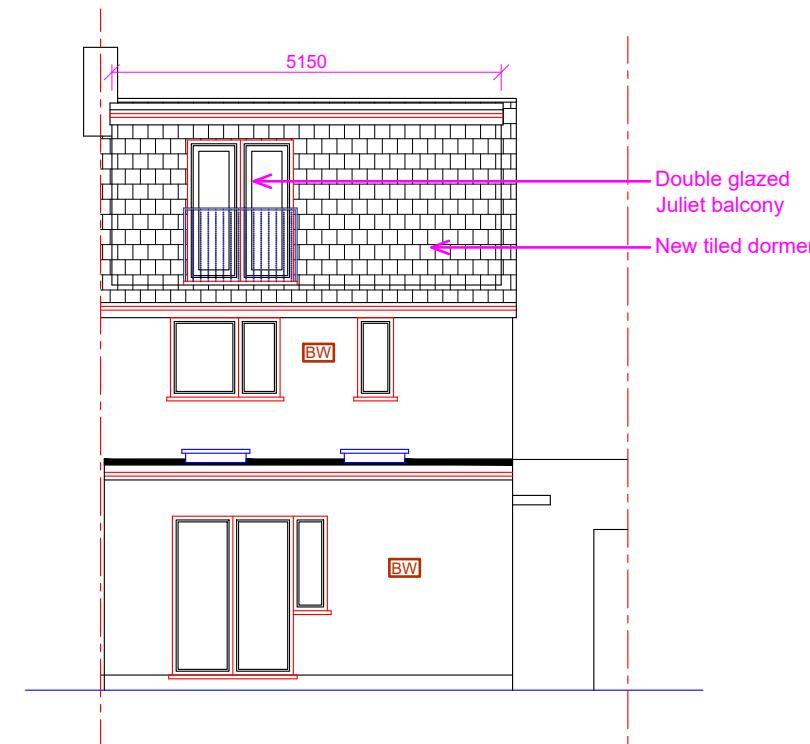


Proposed Rear Elevation

Dormer Volume
Height of Dormer (A): 2.405m
Projection of Dormer (B) : 3.72m
Width of Dormer (C) : 5.15m


Volume of dormer: $(A \times B \times C) / 2$
 $= (2.405 \times 3.72 \times 5.15) / 2$
 $= 46.08$
 $= 23.04 \text{m}^3 < 50.0 \text{m}^3$

Notes:

- Sky lights not to project more than 150mm above the roof slope.
- Dormer tiles to colour match with the tiles of main roof.
- Glazing to colour match with the glazing of main dwelling house.
- Side elevation window to be OBS and non-opening below 1.8m FFL.

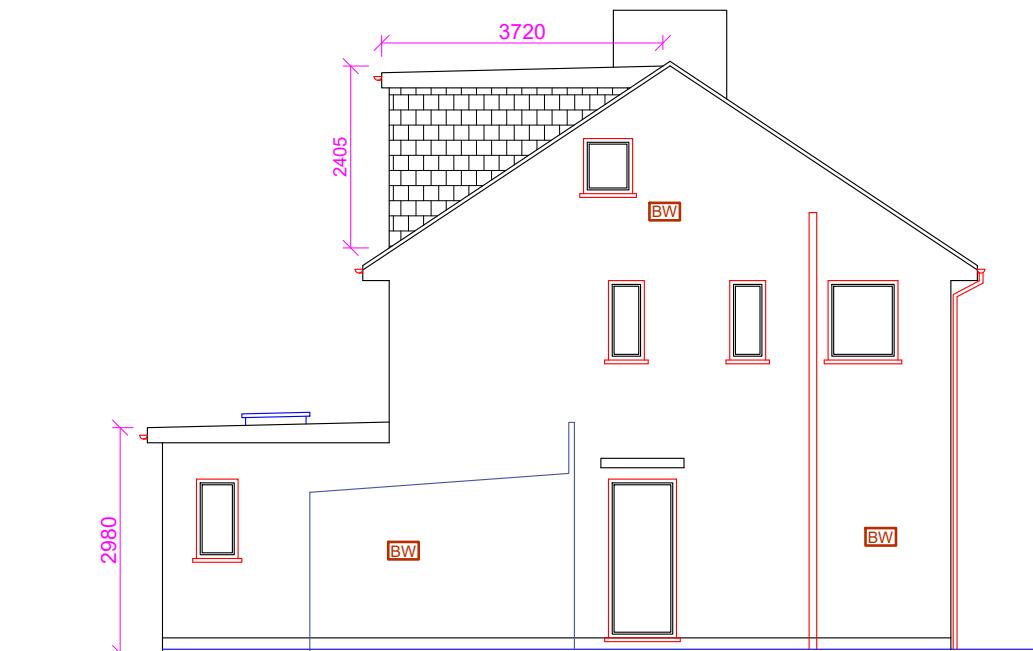

Proposed Side Elevation (LHS)

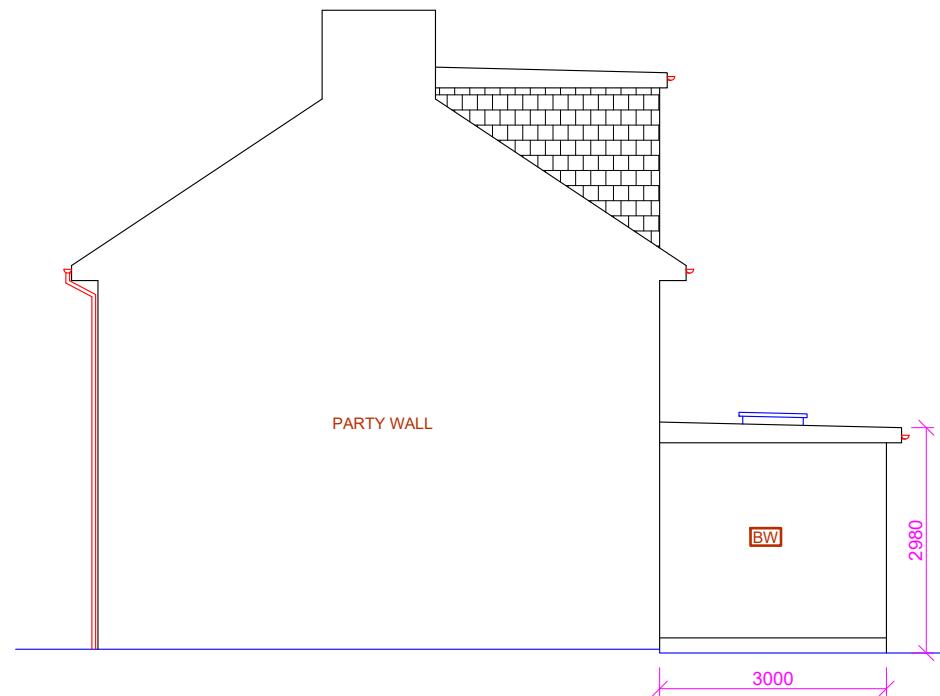

Proposed Side Elevation (RHS)

Proposed Development: Single Storey Rear & Loft Extensions
Site Address: 59 Ash Grove Harefield UB9 6EY

Revisions:		Description
Rev	Date	
A	20/06/2023	

Drawing Description:
Proposed Elevations

Drawing No:
ART/2023/PD59AG/PE

Scale: 1:100
Paper Size: A3
Sheet No: 4 of 6


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