


LOCATION PLAN 1/1250

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0 25 50 100

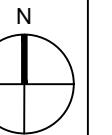

**GENERAL NOTES:**

- All dimensions are in mm, unc.
- The contractor shall check all dimensions on site prior to any construction and report any discrepancy to the client.
- The materials for new construction shall be generally similar to the PROPOSED so that the new work shall blend into the PROPOSED, unless noted otherwise.
4. All detailed specifications where given are generally for similar typical buildings and give some of the requirements for compliance to the current Building Regulations and good building practice. Some items may need modifications to suit site conditions. Not with standing this, the contractor shall be responsible to ensure that the works comply to the latest Building Regulations and will be responsible to obtain all the required Completion Certificates. The contractor, before commencement of any works, shall collect all relevant information, details of any Planning Permission and any conditions specific thereto, details of any Building Regulations Approvals and outstanding information and conditions, etc. The contractor shall propose all the planned variations from any details given here and get them approved before the building work commences. All work to be approved by the Local Authority Building Surveyor or similar appointed.
5. Any structural details provided in the drawings (eg: removal of wall sections, provision of new beams, columns, foundations, etc.) are based on limited information. The contractor shall ensure validity of all assumptions and adequacy of structural designs provided. The contractor shall be responsible for all temporary works and supports provided during construction. Other details of steel beams, supports, connections, etc. may be in a separate Structural Design Report.
6. The proposed building layout is only based on limited site inspection. The contractor shall investigate this further during construction and provide adequate system to cater for foul water and surface water from all facilities & appliances. Final details will be determined and confirmed on site.
7. The client is responsible in serving all the appropriate Party Wall Notices under the Party Wall Acts and obtains consents as required by the act.
8. Work shall commence until all approvals and agreements have been obtained. These include Planning, Building Regulations, Thames Water and Party Wall.

These drawings are only for local authority or statutory approvals (such as Planning Permission, etc.) and may not give complete or correct scope of building work and therefore should not be used as basis of any building contract unless specifically agreed otherwise.

9. If a detailed site investigation (trial pit, soil analysis, etc.) has been carried out, unless noted otherwise, any information on foundation type, depth, etc should be regarded as preliminary only. Any foundation depth indicated is from original virgin ground and any backfill or made-up ground is normally ignored. Exact details of Foundations to be verified and confirmed on site, based on exact location and type of trees, type of soil, presence of rock, etc. PROPOSAL is a rough drawing, other services, etc. and construction with the Building Control Surveyor.

10. The Design may be limited to basic structural and layout requirements, with very limited considerations on risk assessment and health and safety issues. The client and contractor shall be responsible to ensure that all measures are taken to avoid risks to health and safety or reduce risks at source if they cannot be avoided altogether. Where The Construction (Design and Management) Regulations 2007 (CDM) are applicable the client, in conjunction with CDM co-ordinator must ensure that the principal contractor plans, manages and co-ordinates health and safety while construction work is being undertaken.

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**CLIENT:**

Nimesh Mistry

**Project:**

Rear Extension

**Address:**

107 Shenley Avenue  
Ruislip  
HA4 6BT

**TITLE:**

BLOCK PLAN & LOCATION PLAN

**REVISION**

Date Initials Description  
A - 08/09/2020 - AA - 1st Draft

B -

C -

**PROJECT NUMBER:**

200703

**REV:** A


**SCALE:**

1:1250 & 1:500 @ A3

**DRAWING No:**

B-01

**DATE:** 30/11/2020

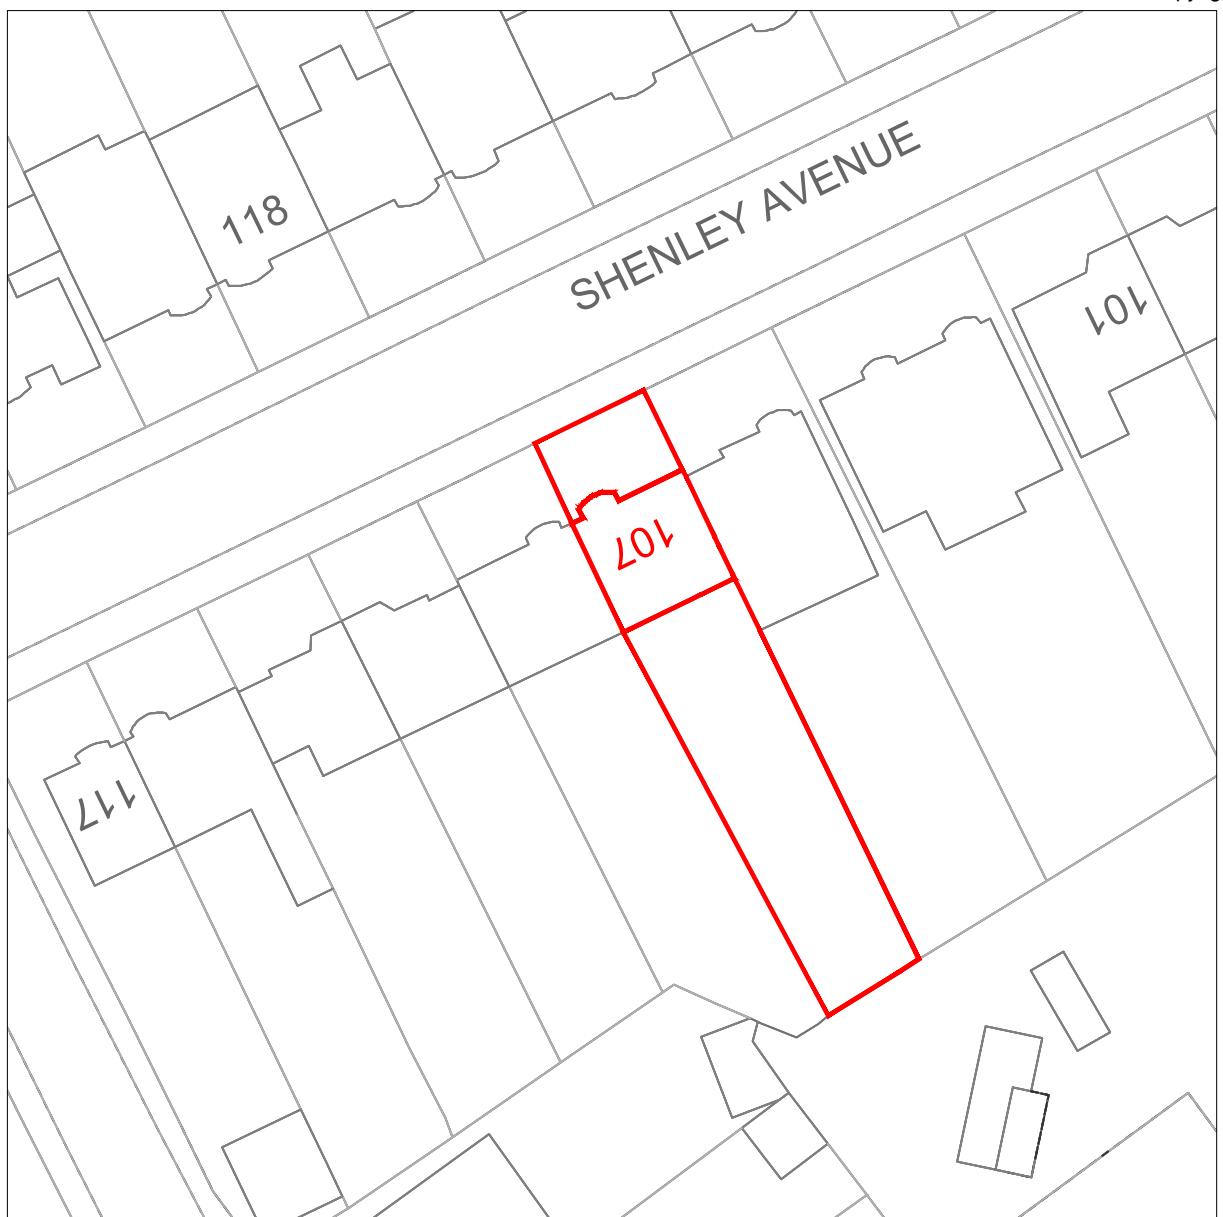

BLOCK PLAN EXISTING 1/500


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BLOCK PLAN PROPOSED 1/500

0 50

0 1 2 3 4 5m



GENERAL NOTES.

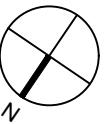1. All dimensions are in mm, unc.  
2. The contractor shall check all dimensions on site prior to any construction and report any discrepancy to the client.  
3. The materials for new construction shall be generally similar to the PROPOSED so that the new work shall blend into the PROPOSED, unless noted otherwise.  
4. All detailed specifications where given are generally for similar typical buildings and give some of the requirements for compliance to the current Building Regulations and good building practice. Some items may need modifications to suit site conditions. Not with standing this, the contractor shall be responsible to ensure that the works comply to the latest Building Regulations and will be responsible to obtain all the required Completion Certificates. The contractor, before commencement of any works, shall collect all relevant information and details of any Planning Permission and any conditions specific thereto, details of Building Regulations Approval, any outstanding information and conditions, etc. The contractor shall propose all the planned variations from any details given here and get them approved before the building work commences. All work to be approved by the Local Authority Building Surveyor or similar appointed.  
5. Any structural details provided in the drawings (eg: removal of wall sections, provision of new beams, columns, foundations, etc.) are based on limited information and are for guidance only. Before commencing any work and in particular any demolition, the contractor shall ensure validity of all assumptions and adequacy of structural designs provided. The contractor shall be responsible for all temporary works and supports provided during construction. Other details of steel beams, supports, connections, etc. may be in a separate Structural Report.  
6. The proposed design layout is only based on limited site inspection. The contractor shall investigate this further during construction and provide adequate system to cater for foul water and surface water from all facilities & appliances. Final details will be determined and confirmed on site.  
7. The client is responsible in serving all the appropriate Party Wall Notices under the Party Wall Acts and obtains consents as required by the act.  
8. Work shall commence until all approvals and agreements have been obtained. These include Planning, Building Regulations, Thames Water and Party Wall.  
These drawings are only for local authority or statutory approvals (such as Planning Permission, etc.) and may not give complete or correct scope of building work and therefore should not be used as basis of any building contract unless specifically agreed otherwise.  
9. Site investigation (soil test, trial pit, soil analysis, etc.) has been carried out, unless noted otherwise, and any information on foundation type, depth, etc should be regarded as preliminary only. Any foundation depth indicated is from original virgin ground and any backfill or made-up ground is normally ignored. Exact details of Foundations to be verified and confirmed on site, based on exact location and type of trees, type of soil, presence of rock, etc. PROPOSED drawings, other services, etc. and construction with the Building Control Surveyor.  
10. The Design may be limited to basic structural and layout requirements, with very limited considerations on risk assessment and health and safety issues. The client and/or contractor shall be responsible to ensure that all measures are taken to avoid risks to health and safety or reduce risks at source if they cannot be avoided altogether. Where The Construction (Design and Management) Regulations 2007 (CDM) are applicable the client, in conjunction with CDM co-ordinator must ensure that the principal contractor plans, manages and co-ordinates health and safety while construction work is being undertaken.

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CLIENT:  
Nimesh Mistry

Project:  
Rear Extension


Address:  
107 Shenley Avenue  
Ruislip  
HA4 6BT


TITLE:  
EXISTING GROUND FLOOR PLAN  
PROPOSED GROUND FLOOR PLAN

REVISION

Date	Initials	Description
A - 08/09/2020 - AA	-	1st Draft
B -	-	
C -	-	

PROJECT NUMBER: 200720	REV: A
SCALE: 1:100 @ A3	DRAWING No: A-01
DATE: 30/11/2020	

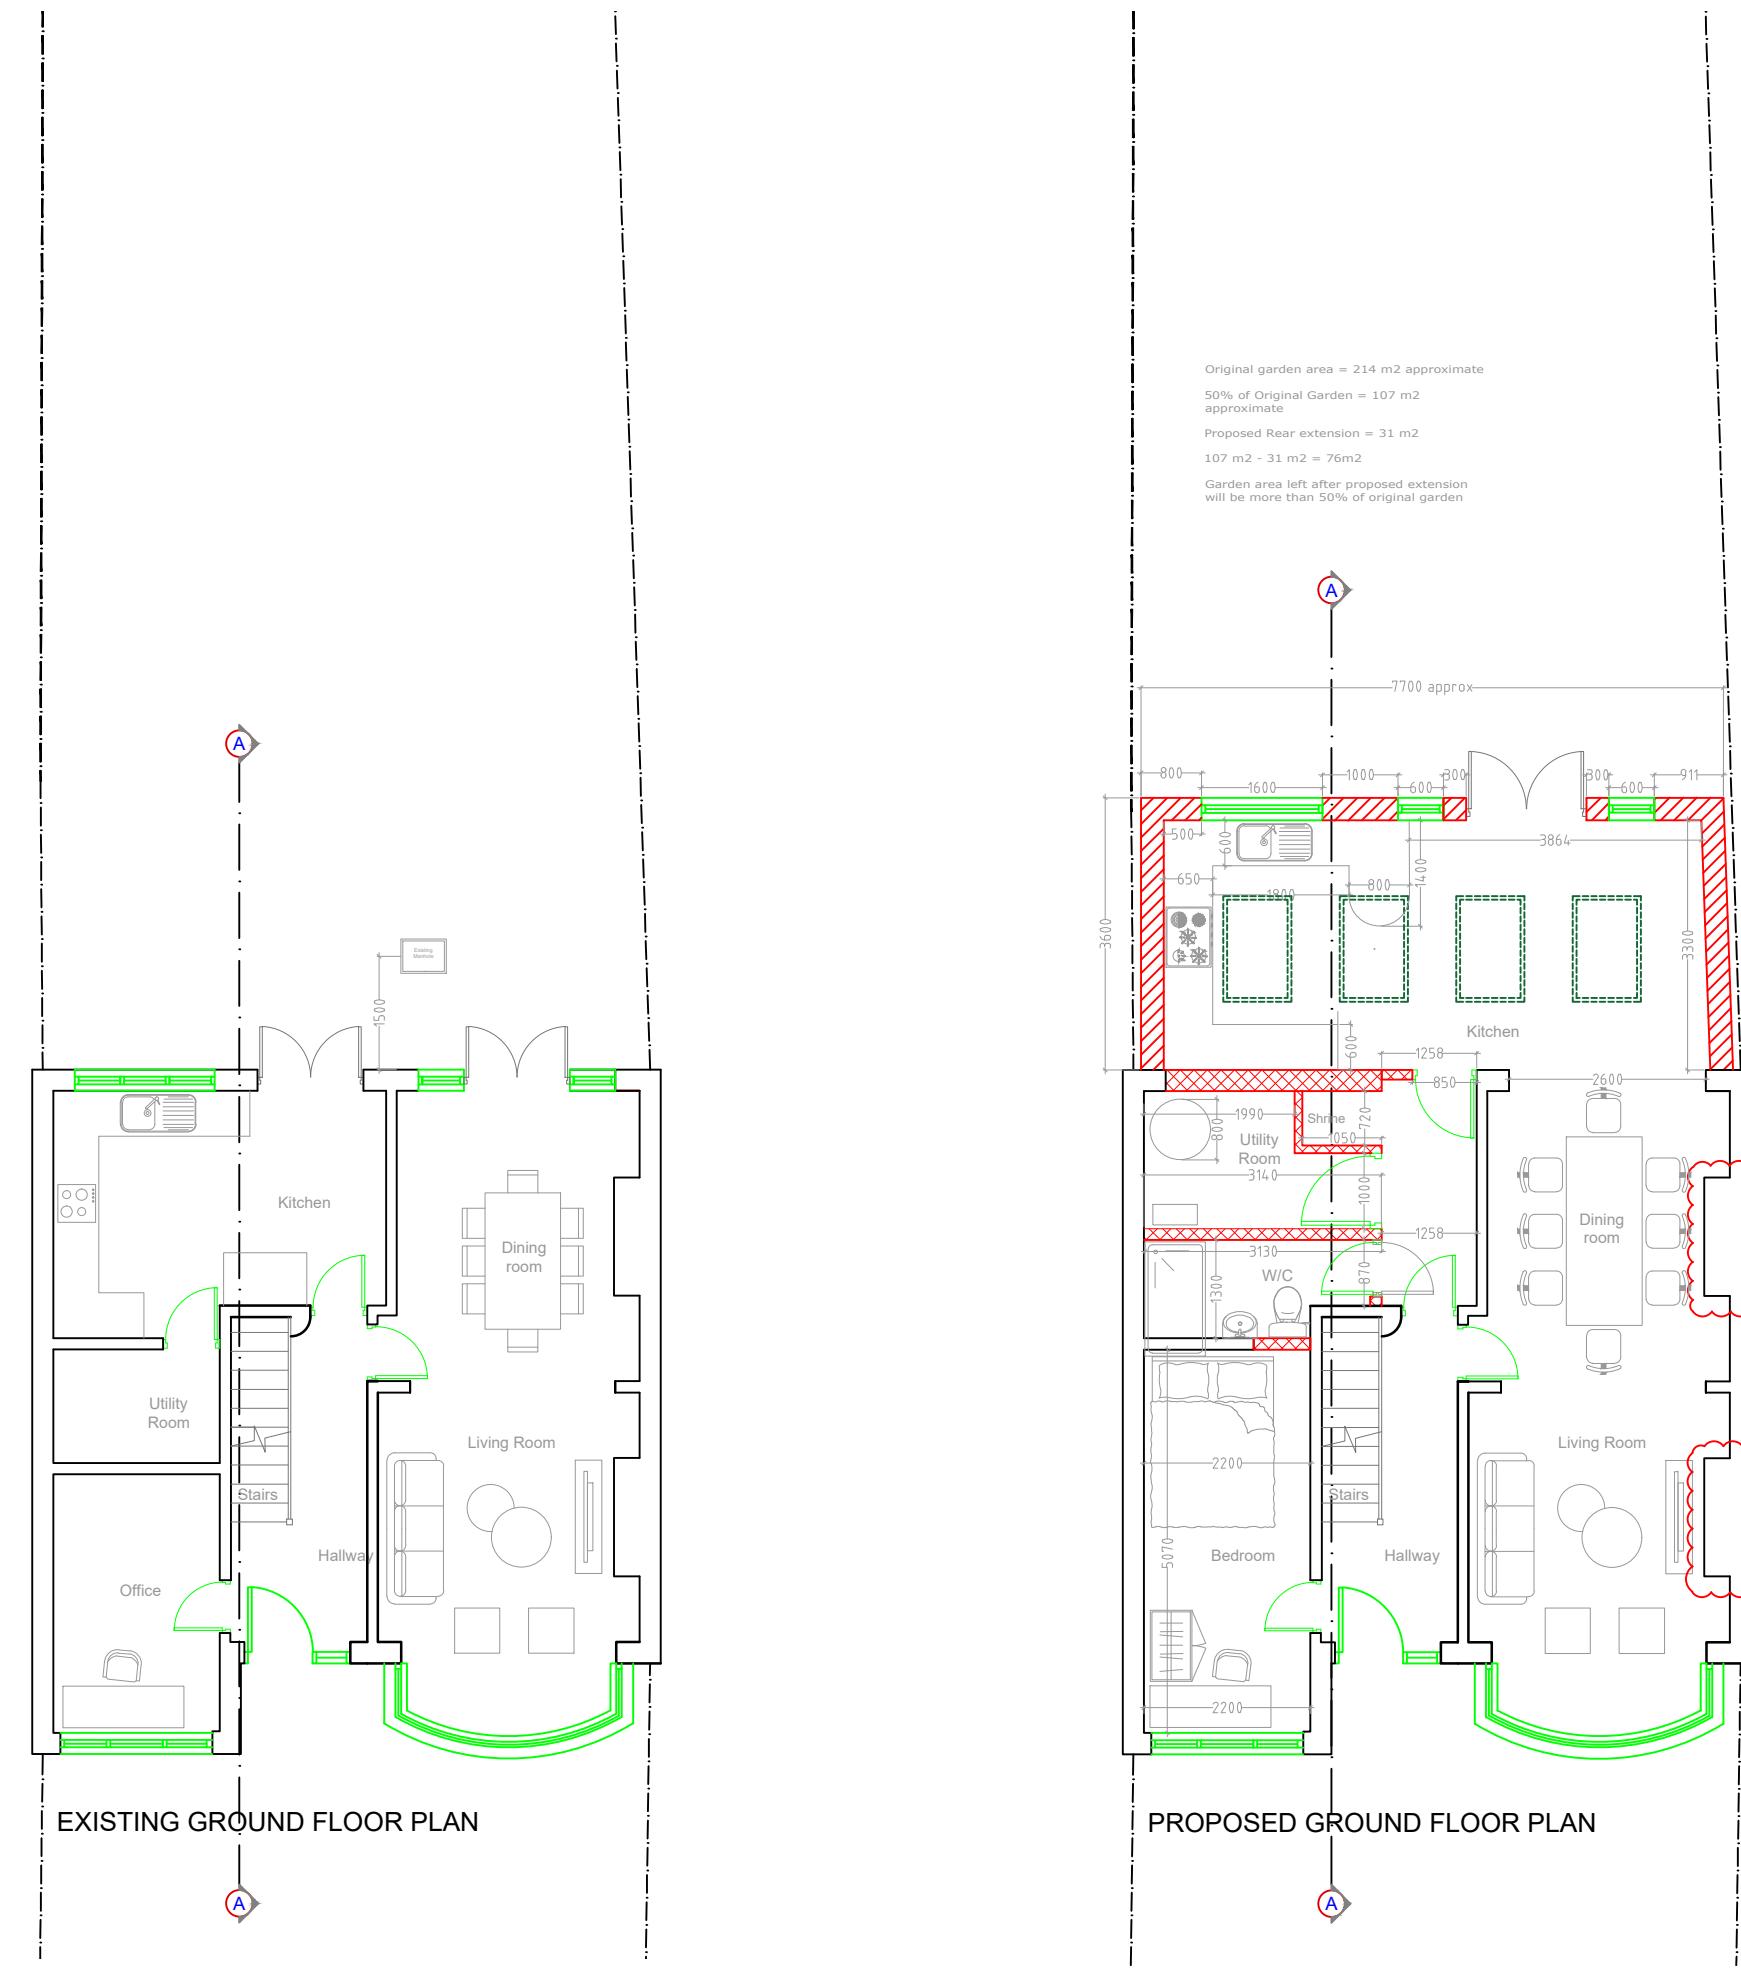

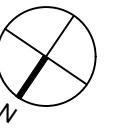

GENERAL NOTES.

- All dimensions are in mm, unc.
- The contractor shall check all dimensions on site prior to any construction and report any discrepancy to the client.
- The materials for new construction shall be generally similar to the PROPOSED so that the new work shall blend into the PROPOSED, unless noted otherwise.
- Dimension specifications where given are generally for similar typical buildings and give some of the requirements for compliance to the current Building Regulations and good building practice. Some items may need modifications to suit site conditions. Not with standing this, the contractor shall be responsible to ensure that the works comply to the latest Building Regulations and will be responsible to obtain all the required Completion Certificates. The contractor, before commencement of any works, shall collect all relevant information, details of any Planning Permission and any conditions specific thereto, details of Building Regulations Approval, any outstanding information and conditions, etc. The contractor shall propose all the planned variations from any details given here and get them approved before the building work commences. All work to be approved by the Local Authority Building Surveyor or similar appointed.
- Any structural details provided in the drawings (eg: removal of wall sections, provision of new beams, columns, foundations, etc.) are based on limited site information. Before commencing any structural work and in particular any demolition, the contractor shall ensure validity of all assumptions and adequacy of structural designs provided. The contractor shall be responsible for all temporary works and supports provided during construction. Other details of steel beams, supports, connections, etc. may be in a separate Structural Design Report.
- Site investigation. The contractor shall investigate this further during construction and provide adequate system to cater for foul water and surface water from all facilities & appliances. Final details will be determined and confirmed on site.
- The client is responsible in serving all the appropriate Party Wall Notices under the Party Wall Acts and obtains consents as required by the act.
- Building work shall commence until all approvals and agreements have been obtained. These include Planning, Building Regulations, Thames Water and Party Wall.
- These drawings are only for local authority or statutory approvals (such as Planning Permission, etc.) and may not give complete or correct scope of building work and therefore should not be used as basis of any building contract unless specifically agreed otherwise.
- Site investigation. The contractor shall be responsible to ensure that all measures are taken to avoid risks to health and safety or reduce risks at source if they cannot be avoided altogether. Where The Construction (Design and Management) Regulations 2007 (CDM) are applicable the client, in conjunction with CDM co-ordinator must ensure that the principal contractor plans, manages and co-ordinates health and safety while construction work is being undertaken.
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**CLIENT:**

Nimesh Mistry

**Project:**

Rear Extension

**Address:**

107 Shenley Avenue  
Ruislip  
HA4 6BT

**TITLE:**

EXISTING ROOF PLAN  
PROPOSED ROOF PLAN

**REVISION**

Date Initials Description

A - 08/09/2020 - AA - 1st Draft

B -

C -

PROJECT NUMBER:  
200720



REV: A

SCALE:  
1:100 @ A3

DRAWING No:  
A-02


DATE: 30/11/2020

0 1 2 3 4 5m

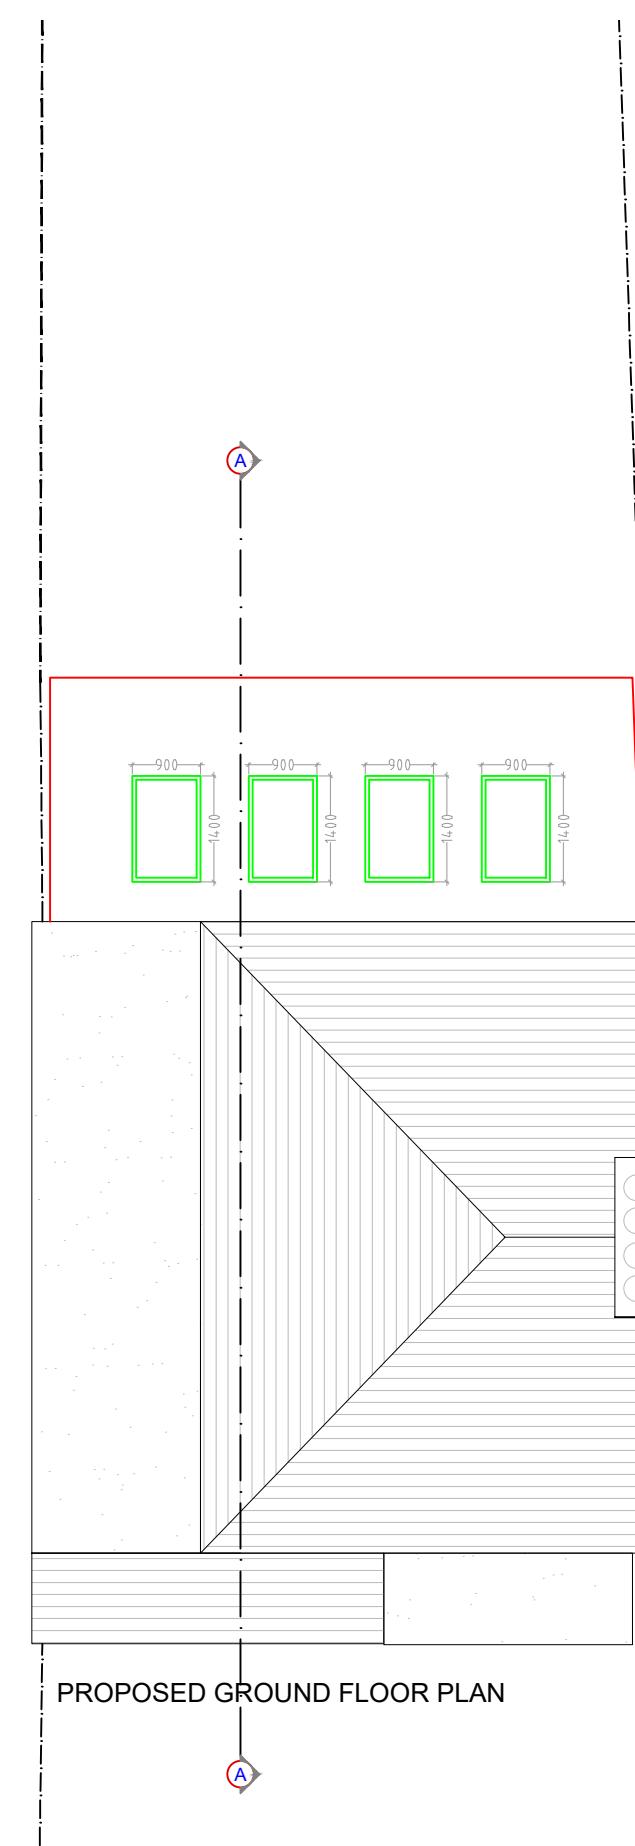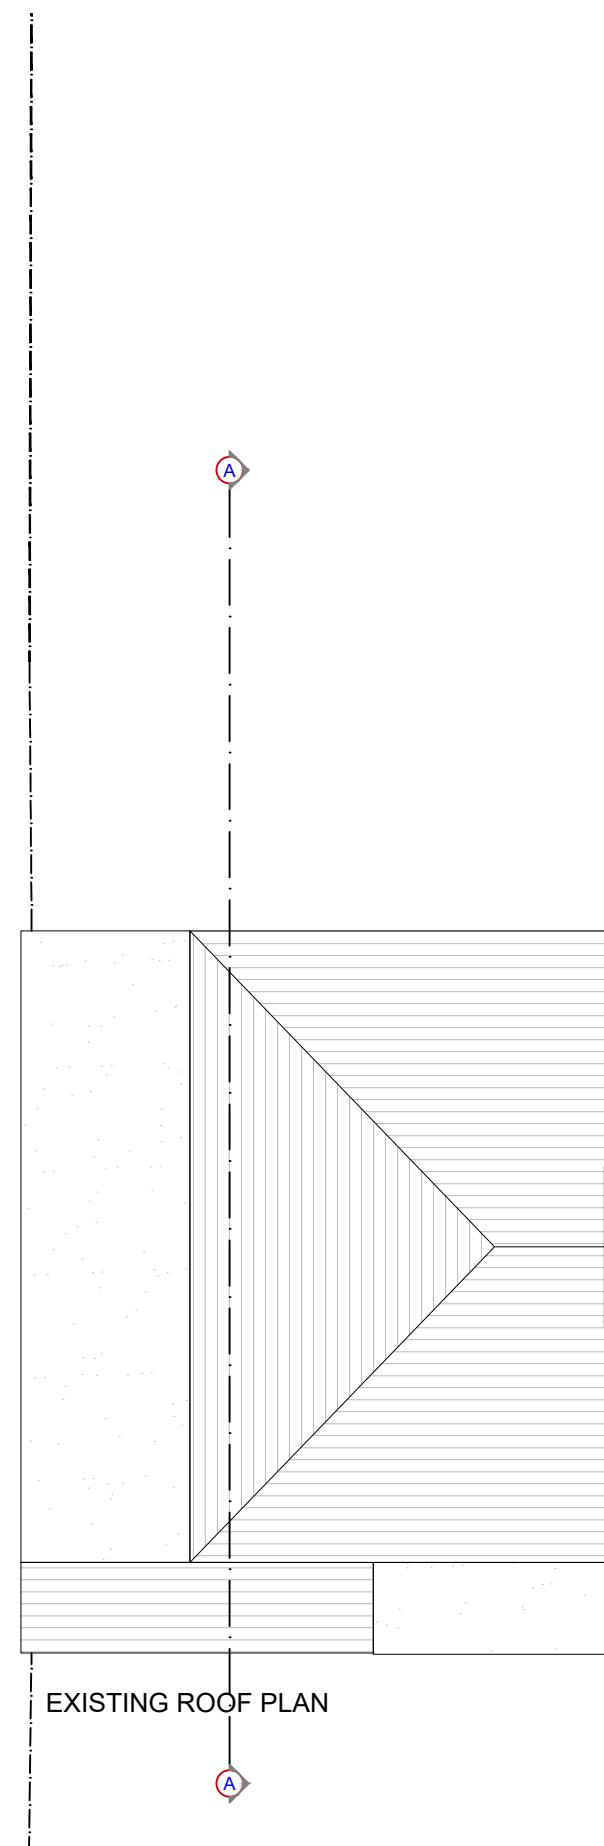




EXISTING SIDE (WEST) ELEVATION

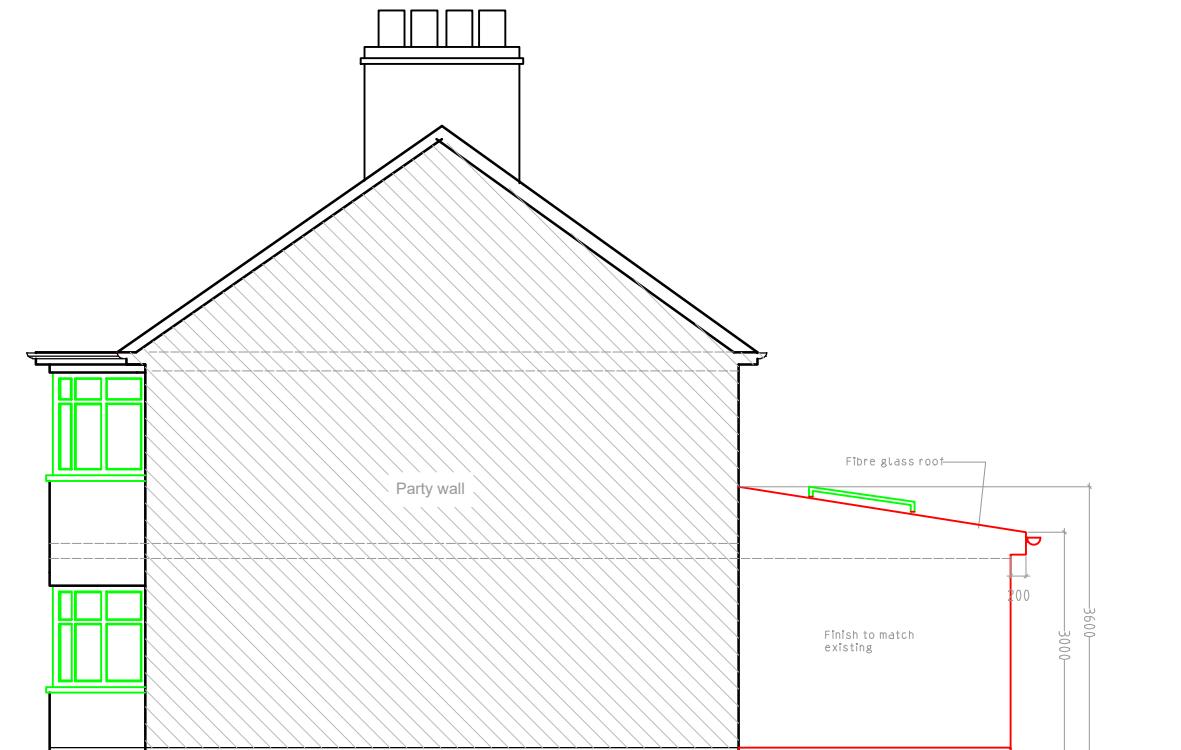

PROPOSED SIDE (WEST) ELEVATION



EXISTING SIDE (EAST) ELEVATION

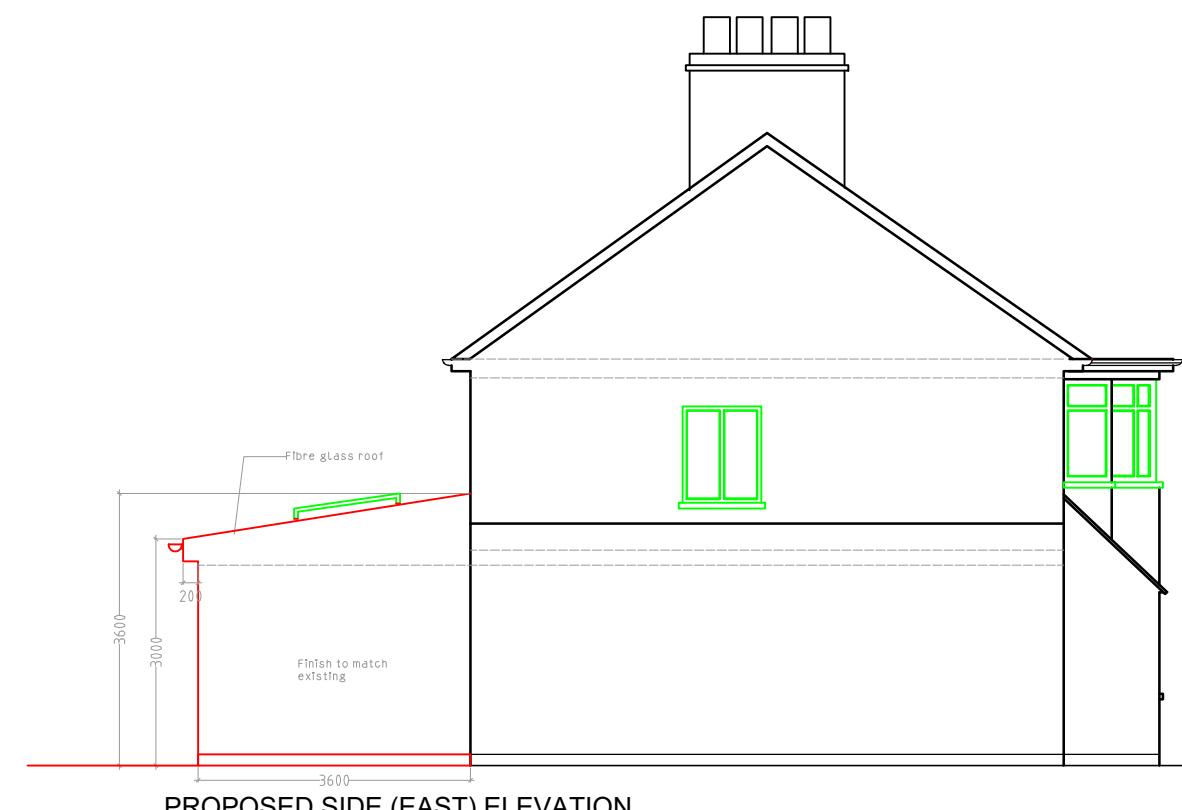

PROPOSED SIDE (EAST) ELEVATION



GENERAL NOTES.

- All dimensions are in mm, unc.
- The contractor shall check all dimensions on site prior to any construction and report any discrepancy to the client.
- The materials for new construction shall be generally similar to the PROPOSED so that the new work shall blend into the PROPOSED, unless noted otherwise.
- Any detailed specifications where given are generally for similar typical buildings and give some of the requirements for compliance to the current Building Regulations and good building practice. Some items may need modifications to suit site conditions. Not with standing this, the contractor shall be responsible to ensure that the works comply to the latest Building Regulations and will be responsible to obtain all the required Completion Certificates. The contractor, before commencement of any works, shall collect all relevant information, details of any Planning Permission and any conditions specific thereto, details of Building Regulations Approvals and any outstanding information and conditions, etc. The contractor shall propose all the planned variations from any details given here and get them approved before the building work commences. All work to be approved by the Local Authority Building Surveyor or similar appointed.
- Any Structural details provided in the drawings (eg: removal of wall sections, provision of new beams, columns, foundations, etc.) are based on limited information. Before carrying out any structural work and in particular any demolition, the contractor shall ensure validity of all assumptions and any adequacy of structural designs provided. The contractor shall be responsible for all temporary works and supports provided during construction. Other details of steel beams, supports, connections, etc. may be in a separate Structural Report.
- The contractor shall provide a detailed layout of the proposed building work and in particular the proposed drainage layout is only based on limited site inspection. The contractor shall investigate this further during construction and provide adequate system to cater for foul water and surface water from all facilities & appliances. Final details will be determined and confirmed on site.
- The client is responsible in serving all the appropriate Party Wall Notices under the Party Wall Acts and obtains consents as required by the act.
- Building work shall commence until all approvals and agreements have been obtained. These include Planning, Building Regulations, Thames Water and Party Wall.
- These drawings are only for local authority or statutory approvals (such as Planning Permission, etc.) and may not give complete or correct scope of building work and therefore should not be used as basis of any building contract unless specifically agreed otherwise.
- It is the responsibility of the contractor to ensure that any investigation (trial, pit, soil analysis, etc) has been carried out, unless noted otherwise, and any information on foundation type, depth, etc should be regarded as preliminary only. Any foundation depth indicated is from original virgin ground and any backfill or made-up ground is normally ignored. Exact details of Foundations to be verified and confirmed on site, based on exact location and type of trees, type of soil, presence of rock, etc. The PROPOSED drawing, other services, etc. and construction with the Building Control Surveyor.
- The Design may be limited to basic structural and layout requirements, with very limited considerations on risk assessment and health and safety issues. The client and/or contractor shall be responsible to ensure that all measures are taken to avoid risks to health and safety or reduce risks at source if they cannot be avoided altogether. Where The Construction (Design and Management) Regulations 2007 (CDM) are applicable the client, in conjunction with CDM co-ordinator must ensure that the principal contractor plans, manages and co-ordinates health and safety while construction work is being undertaken.
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CLIENT:

Nimesh Mistry

Project:

Rear Extension

Address:

107 Shenley Avenue  
Ruislip  
HA4 6BT

TITLE:

EXISTING & PROPOSED (WEST) SIDE ELEVATION  
EXISTING & PROPOSED (EAST) SIDE ELEVATION

REVISION

Date Initials Description

A - 08/09/2020 - AA - 1st Draft

B -

C -

PROJECT NUMBER:  
200720

REV: A

SCALE:  
1:100 @ A3

DRAWING No:  
A-03

DATE: 30/11/2020



EXISTING FRONT ELEVATION



EXISTING REAR ELEVATION



PROPOSED FRONT ELEVATION



PROPOSED REAR ELEVATION

**GENERAL NOTES:**

- All dimensions are in mm, unc.
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- The materials for new construction shall be generally similar to the PROPOSED so that the new work shall blend into the PROPOSED, unless noted otherwise.
4. All detailed specifications where given are generally for similar typical buildings and give some of the requirements for compliance to the current Building Regulations and good building practice. Some items may need modifications to suit site conditions. Not with standing this, the contractor shall be responsible to ensure that the works comply to the latest Building Regulations and will be responsible to obtain all the required Completion Certificates. The contractor, before commencement of any works, shall collect all relevant information, details of any Planning Permission and any conditions specific thereto, details of Building Regulations and any other outstanding information and conditions, etc. The contractor shall propose all the planned variations from any details given here and get them approved before the building work commences. All work to be approved by the Local Authority Building Surveyor or similar appointed.
5. Any structural details provided in the drawings (eg: removal of wall sections, provision of new beams, columns, foundations, etc.) are based on limited information. Before commencing any demolition or structural work and in particular any demolition, the contractor shall ensure validity of all assumptions and adequacy of structural designs provided. The contractor shall be responsible for all temporary works and supports provided during construction. Other details of steel beams, supports, connections, etc. may be in a separate Structural Design Report.
6. The proposed layout is only based on limited site inspection. The contractor shall investigate this further during construction and provide adequate system to cater for foul water and surface water from all facilities & appliances. Final details will be determined and confirmed on site.
7. The client is responsible in serving all the appropriate Party Wall Notices under the Party Wall Acts and obtains consents as required by the act.
8. Work shall commence until all approvals and agreements have been obtained. These include Planning, Building Regulations, Thames Water and Party Wall.
- These drawings are only for local authority or statutory approvals (such as Planning Permission, etc.) and may not give complete or correct scope of building work and therefore should not be used as basis of any building contract unless specifically agreed otherwise.
9. Any investigation work (soil test, pit, soil analysis, etc.) has been carried out, unless noted otherwise, and any information provided is regarded as preliminary only. Any foundation depth indicated is from original virgin ground and any backfill or made-up ground is normally ignored. Exact details of Foundations to be verified and confirmed on site, based on exact location and type of trees, type of soil, presence of rock, etc. PROPOSED is the main drawing, other services, etc. and construction with the Building Control Surveyor.
10. The Design may be limited to basic structural and layout requirements, with very limited considerations on risk assessment and health and safety issues. The client and/or contractor shall be responsible to ensure that all measures are taken to avoid risks to health and safety or reduce risks at source if they cannot be avoided altogether. Where The Construction (Design and Management) Regulations 2007 (CDM) are applicable the client, in conjunction with CDM co-ordinator must ensure that the principal contractor plans, manages and co-ordinates health and safety while construction work is being undertaken.
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**CLIENT:**  
Nimesh Mistry

**Project:**  
Rear Extension

**Address:**  
107 Shenley Avenue  
Ruislip  
HA4 6BT


**TITLE:**  
EXISTING FRONT & REAR ELEVATION  
PROPOSED FRONT & REAR ELEVATION

**REVISION**

Date	Initials	Description
A - 08/09/2020 - AA	-	1st Draft
B -	-	
C -	-	

<b>PROJECT NUMBER:</b> 200720	<b>REV:</b> <b>A</b>
<b>SCALE:</b> 1:100 @ A3	<b>DRAWING No:</b> A-04
<b>DATE:</b> 30/11/2020	

0 1 2 3 4 5m

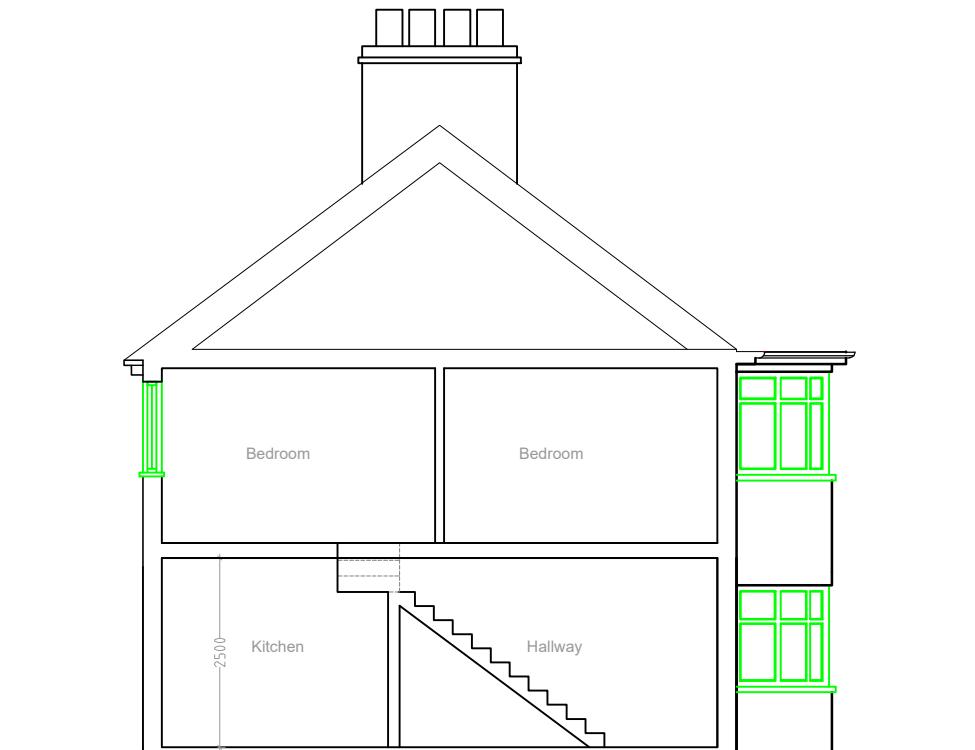

EXISTING SECTION A - A

**GENERAL NOTES:**

- All dimensions are in mm, unc.
- The contractor shall check all dimensions on site prior to any construction and report any discrepancy to the client.
- The materials for new construction shall be generally similar to the PROPOSED so that the new work shall blend into the PROPOSED, unless noted otherwise.
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5. Any structural details provided in the drawings (eg: removal of wall sections, provision of new beams, columns, foundations, etc.) are based on limited information available to the contractor. Before commencing any work and in particular any demolition, the contractor shall ensure validity of all assumptions and adequacy of structural designs provided. The contractor shall be responsible for all temporary works and supports provided during construction. Other details of steel beams, supports, connections, etc. may be in a separate Structural Report.
6. The proposed design layout is only based on limited site inspection. The contractor shall investigate this further during construction and provide adequate system to cater for foul water and surface water from all facilities & appliances. Final details will be determined and confirmed on site.
7. The client is responsible in serving all the appropriate Party Wall Notices under the Party Wall Acts and obtains consents as required by the act.
8. Work shall commence until all approvals and agreements have been obtained. These include Planning, Building Regulations, Thames Water and Party Wall.
- These drawings are only for local authority or statutory approvals (such as Planning Permission, etc.) and may not give complete or correct scope of building work and therefore should not be used as basis of any building contract unless specifically agreed otherwise.
9. A detailed site investigation (trial pit, soil analysis, etc.) has been carried out, unless noted otherwise, and any information on foundation type, depth, etc should be regarded as preliminary only. Any foundation depth indicated is from original virgin ground and any backfill or made-up ground is normally ignored. Exact details of Foundations to be verified and confirmed on site, based on exact location and type of trees, type of soil, presence of rock, etc. PROPOSED drawings, other services, etc. and construction with the Building Control Surveyor.
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**CLIENT:**  
Nimesh Mistry

**Project:**  
Rear Extension

**Address:**  
107 Shenley Avenue  
Ruislip  
HA4 6BT

**TITLE:**  
EXISTING & PROPOSED SECTION A - A


**REVISION**

Date	Initials	Description
A - 08/09/2020 - AA	-	1st Draft
B -	-	
C -	-	
	-	
	-	
	-	

**PROJECT NUMBER:**  
200720      **REV:** A

**SCALE:** 1:100 @ A3      **DRAWING No:** A-05

**DATE:** 30/11/2020

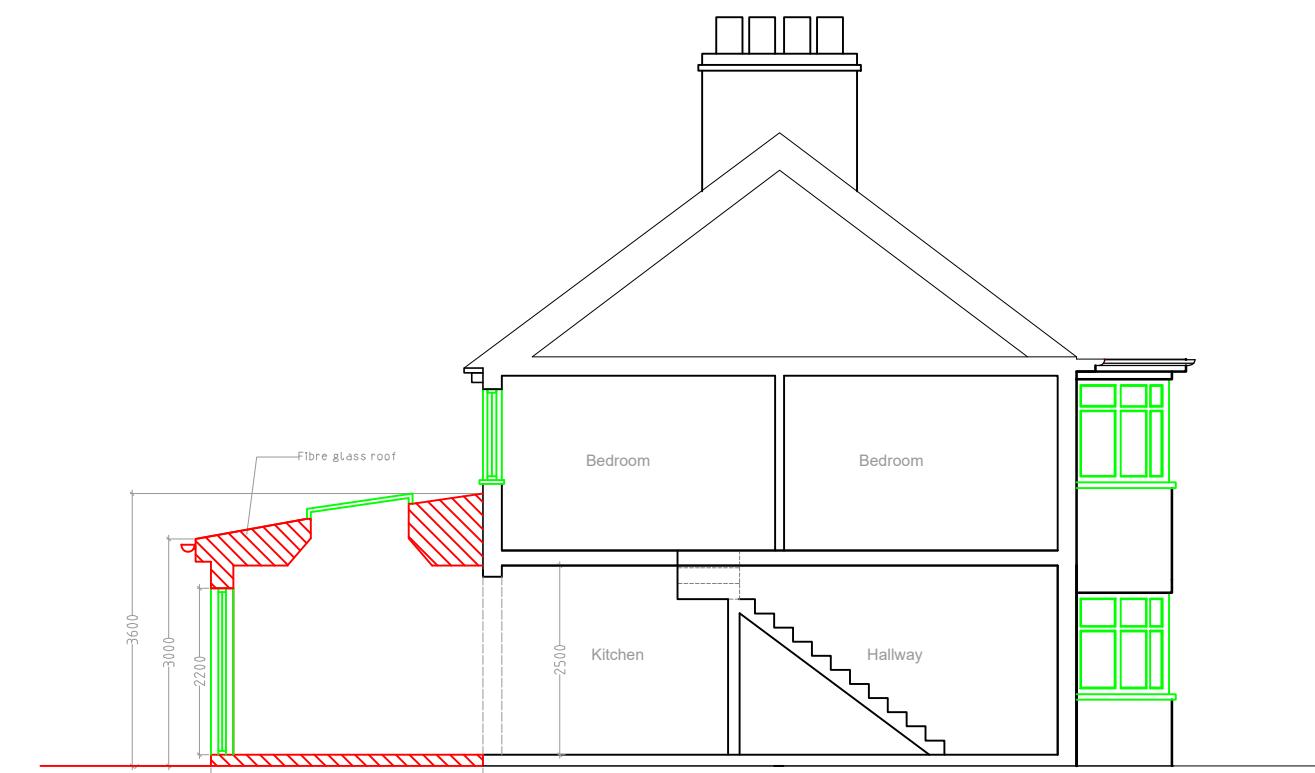

PROPOSED SECTION A - A