


Existing First Floor Plan
Scale 1:100

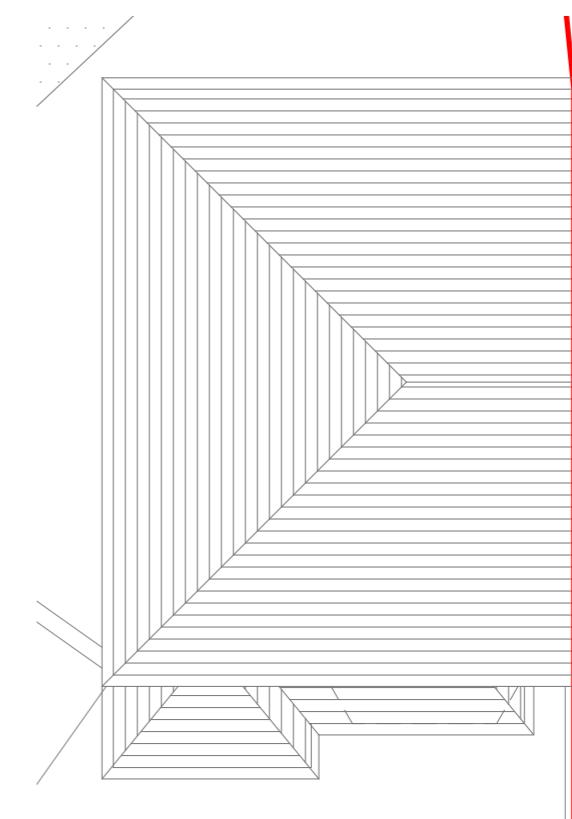

Existing Loft Floor Plan
Scale 1:100

10 Meter
5
2
1
0
1:100

GENERAL NOTES:
 1. ALL DIMENSIONS ARE IN MILLIMETER.
 2. VERIFY ALL DIMENSIONS AND CONDITIONS BEFORE BUILDING OR
 STARTING CONSTRUCTION. NOTIFY THE DESIGNER IMMEDIATELY OF ANY
 DISCREPANCY OR VARIATION.
 3. ALL WORK TO COMPLY WITH CURRENT BUILDING REGULATIONS
 AND CODES OF PRACTICE

Title:

Existing Floor Plans

Site Address
91 Raeburn Road,
Hayes.
UB4 8PN

Scale: 1:100 @A3
Date: 23/01/2024
Drawing No.:
2024/010 -01
Drawn By:
RO


Revision Date:

e:mail -
faluckpatel@yahoo.com
(M) +44 (0) 7871 466 254

Faluck Patel



Existing Front Elevation
Scale 1:100

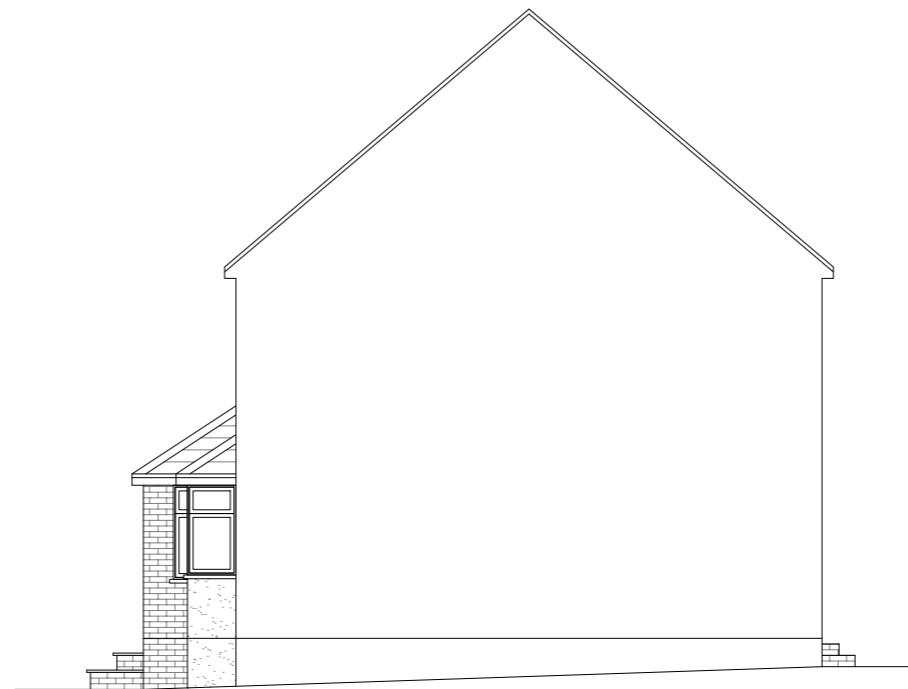

Existing Side Elevation
Scale 1:100



Existing Rear Elevation
Scale 1:100



Existing Side Elevation
Scale 1:100

10 Meter
5
2
1
0
1:100

GENERAL NOTES:
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AND CODES OF PRACTICE

Title:


Existing Elevations

Site Address
91 Raeburn Road,
Hayes,
UB4 8PN

Scale: 1:100 @A3
Date: 23/01/2024
Drawing No.:
2024/010 -02

Revision Date:
Drawn By:
RO
e:mail -
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Faluck Patel

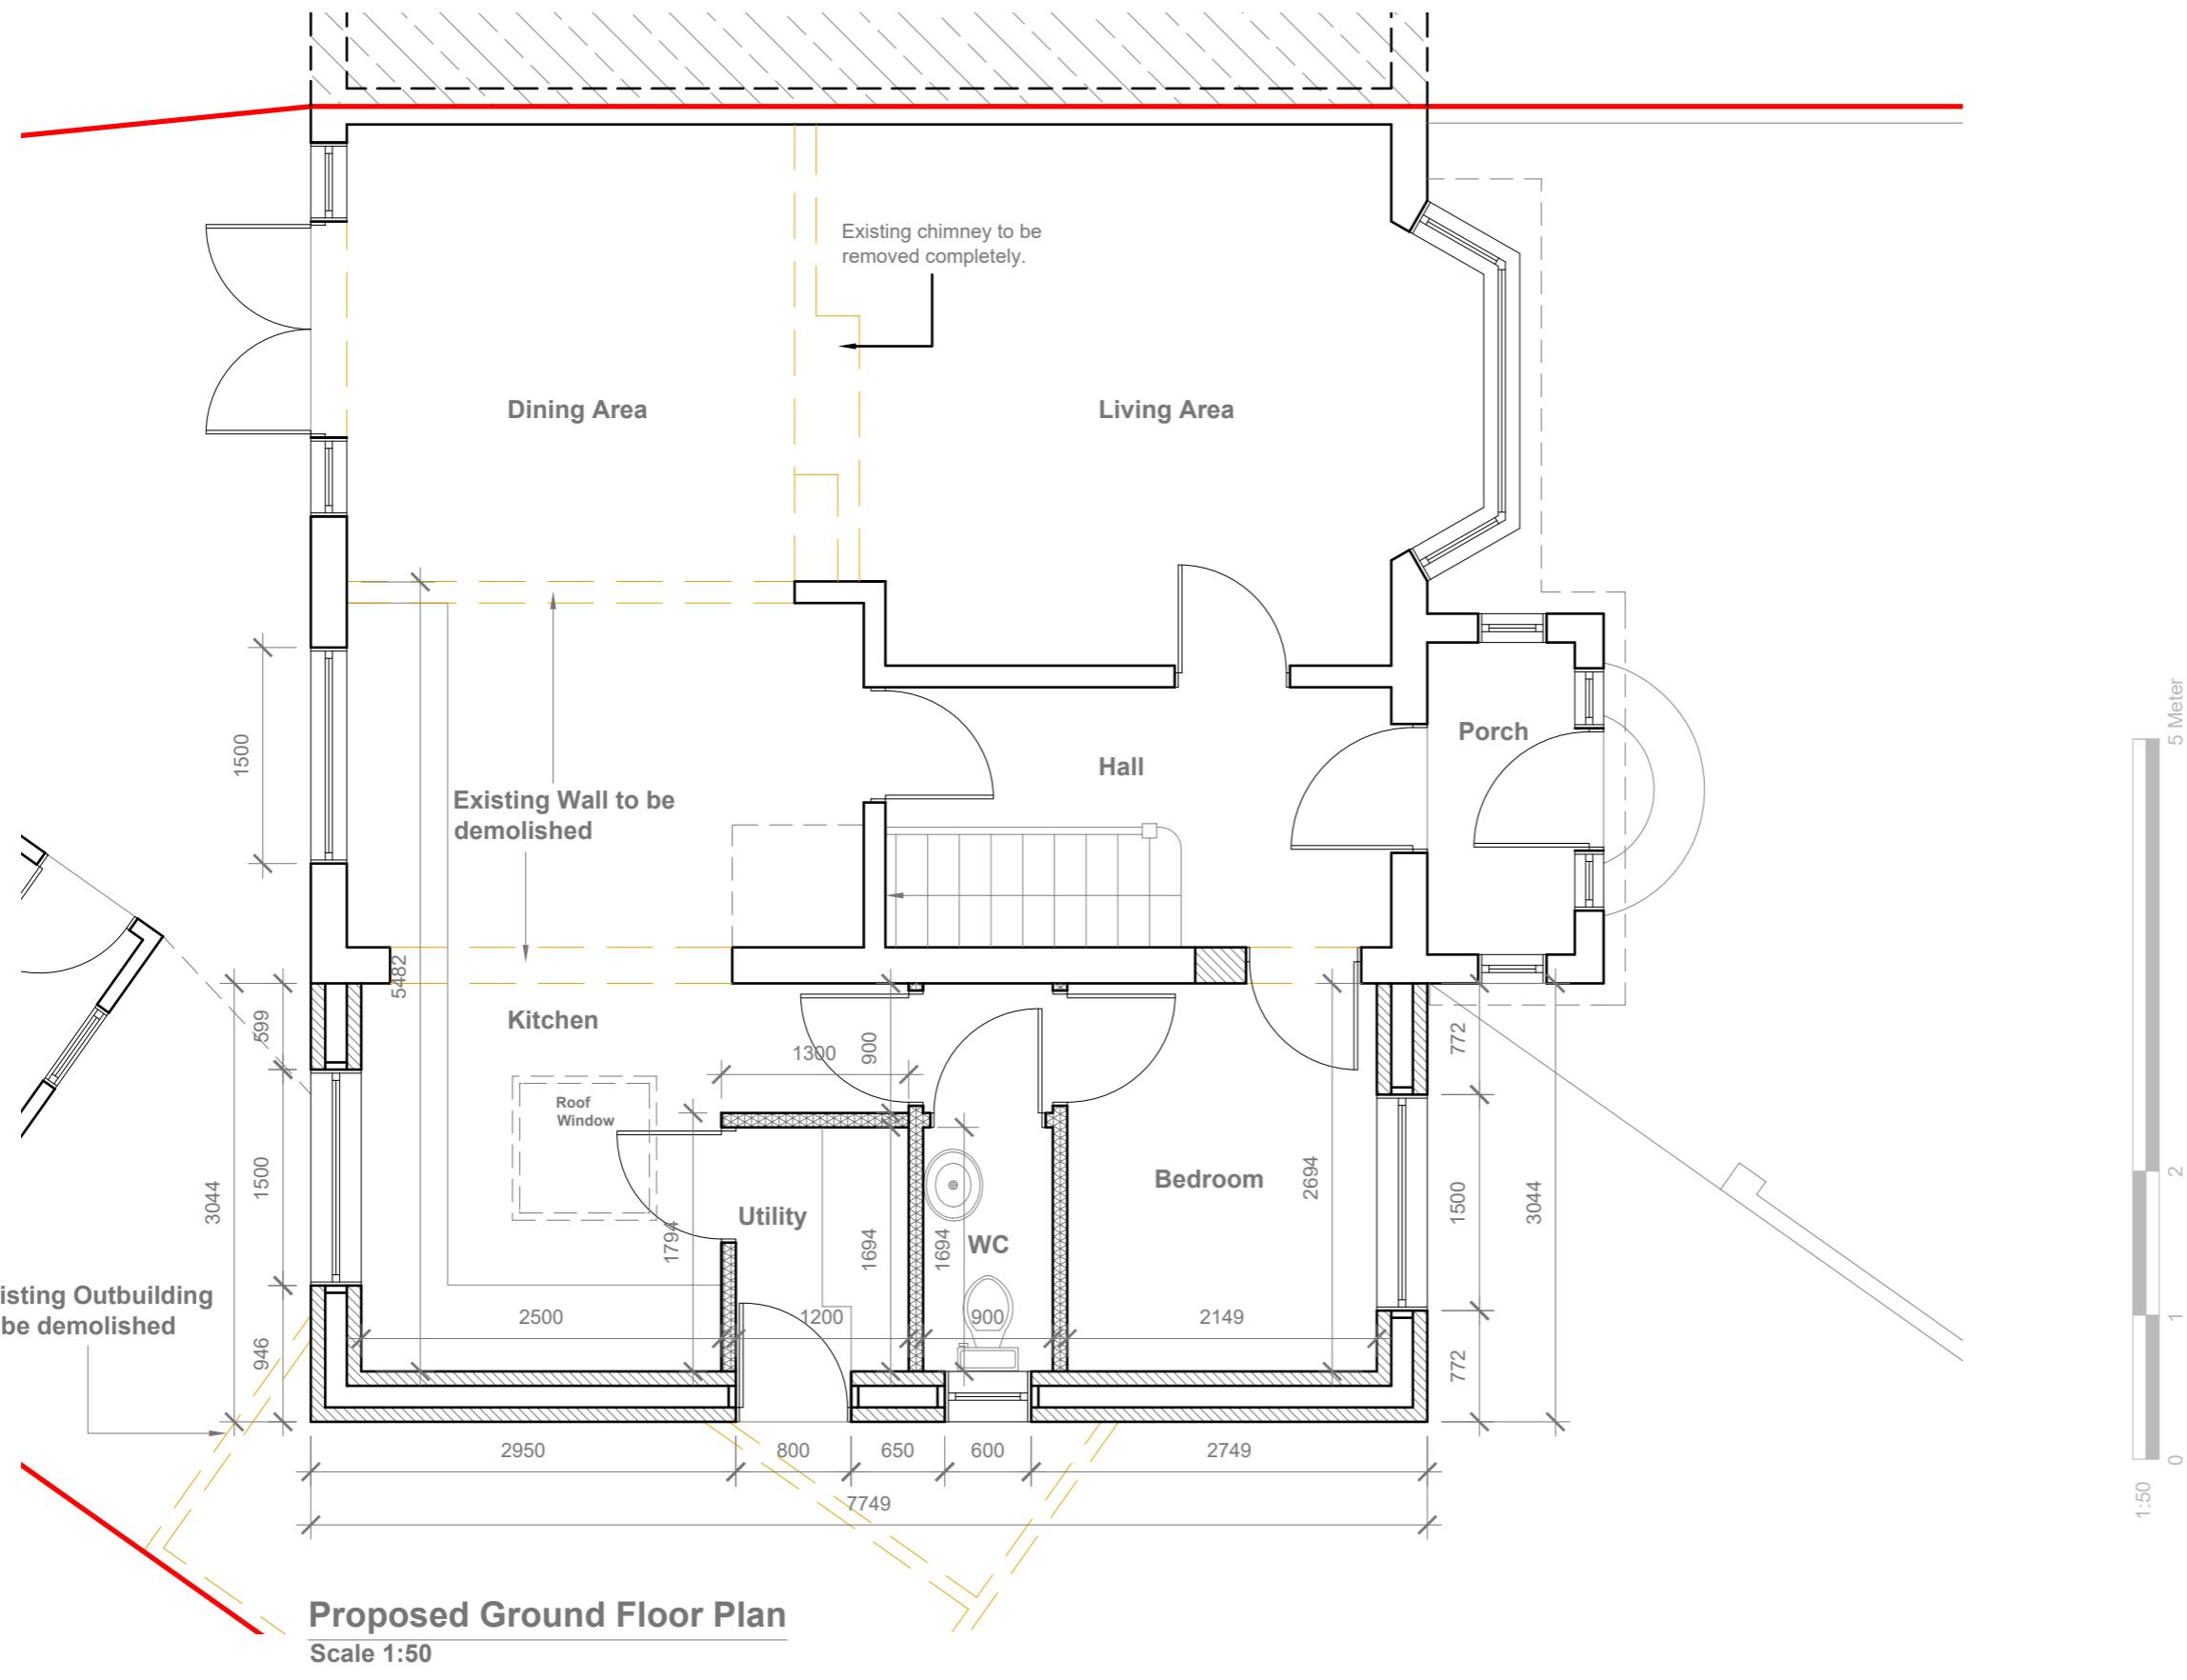

GENERAL NOTES:

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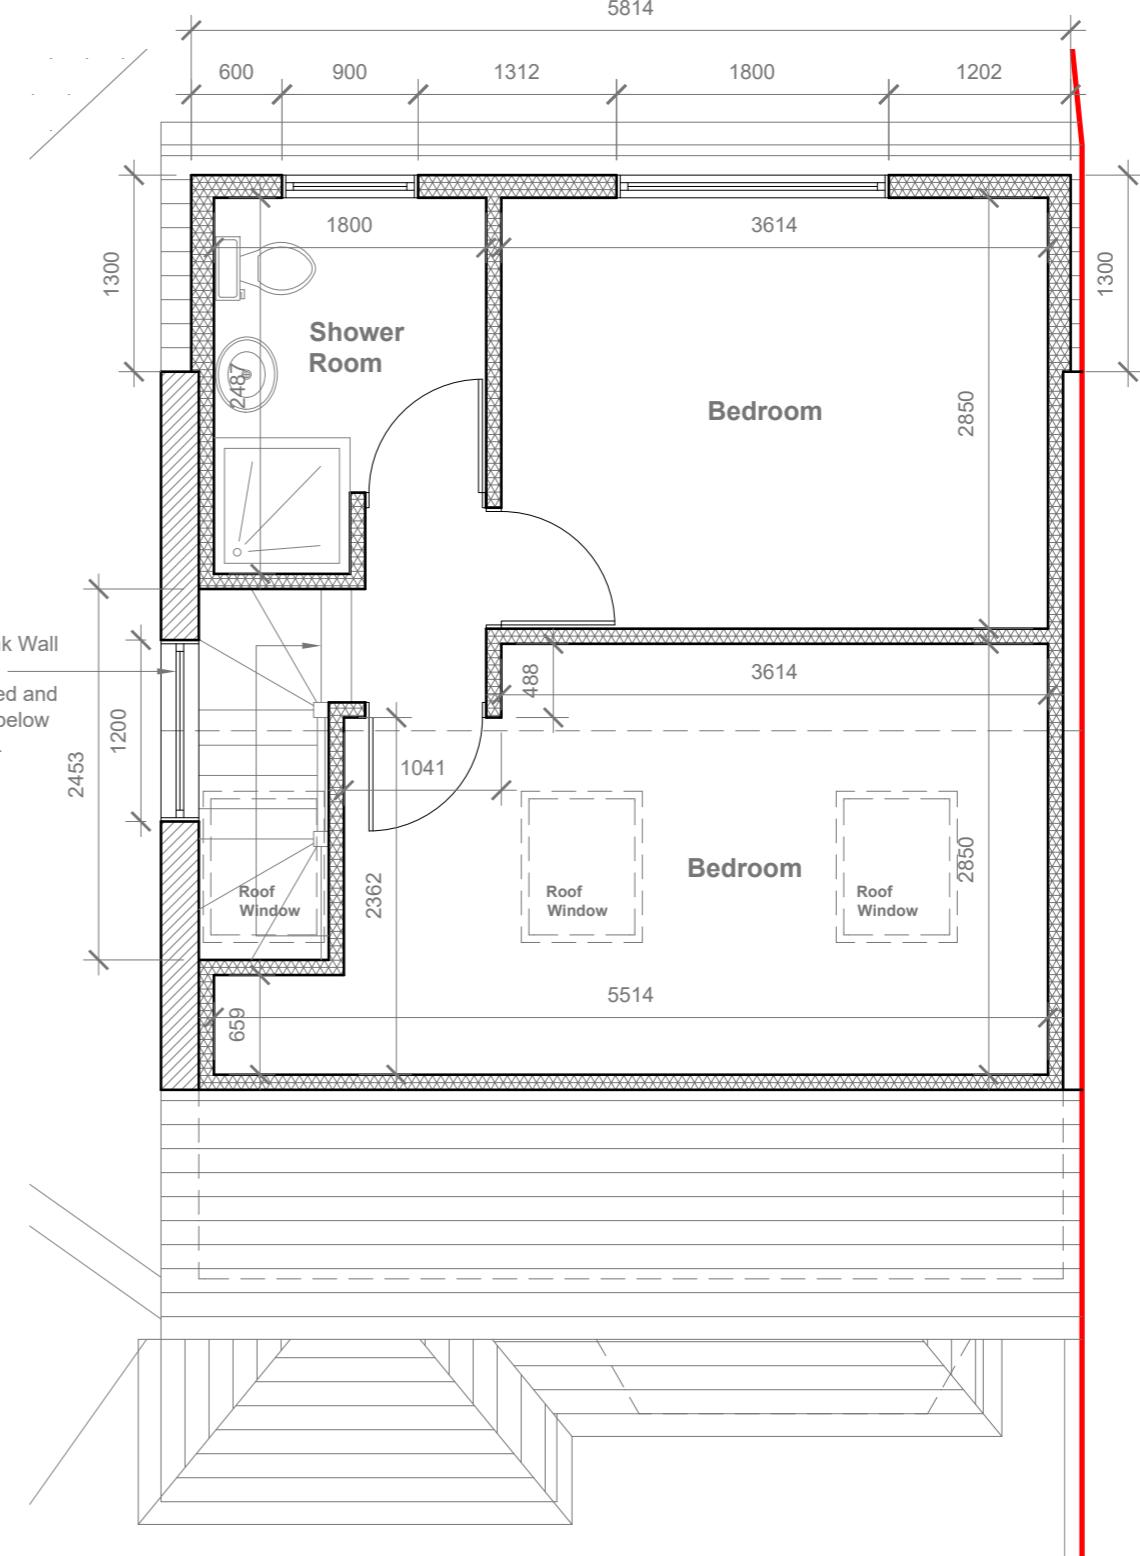
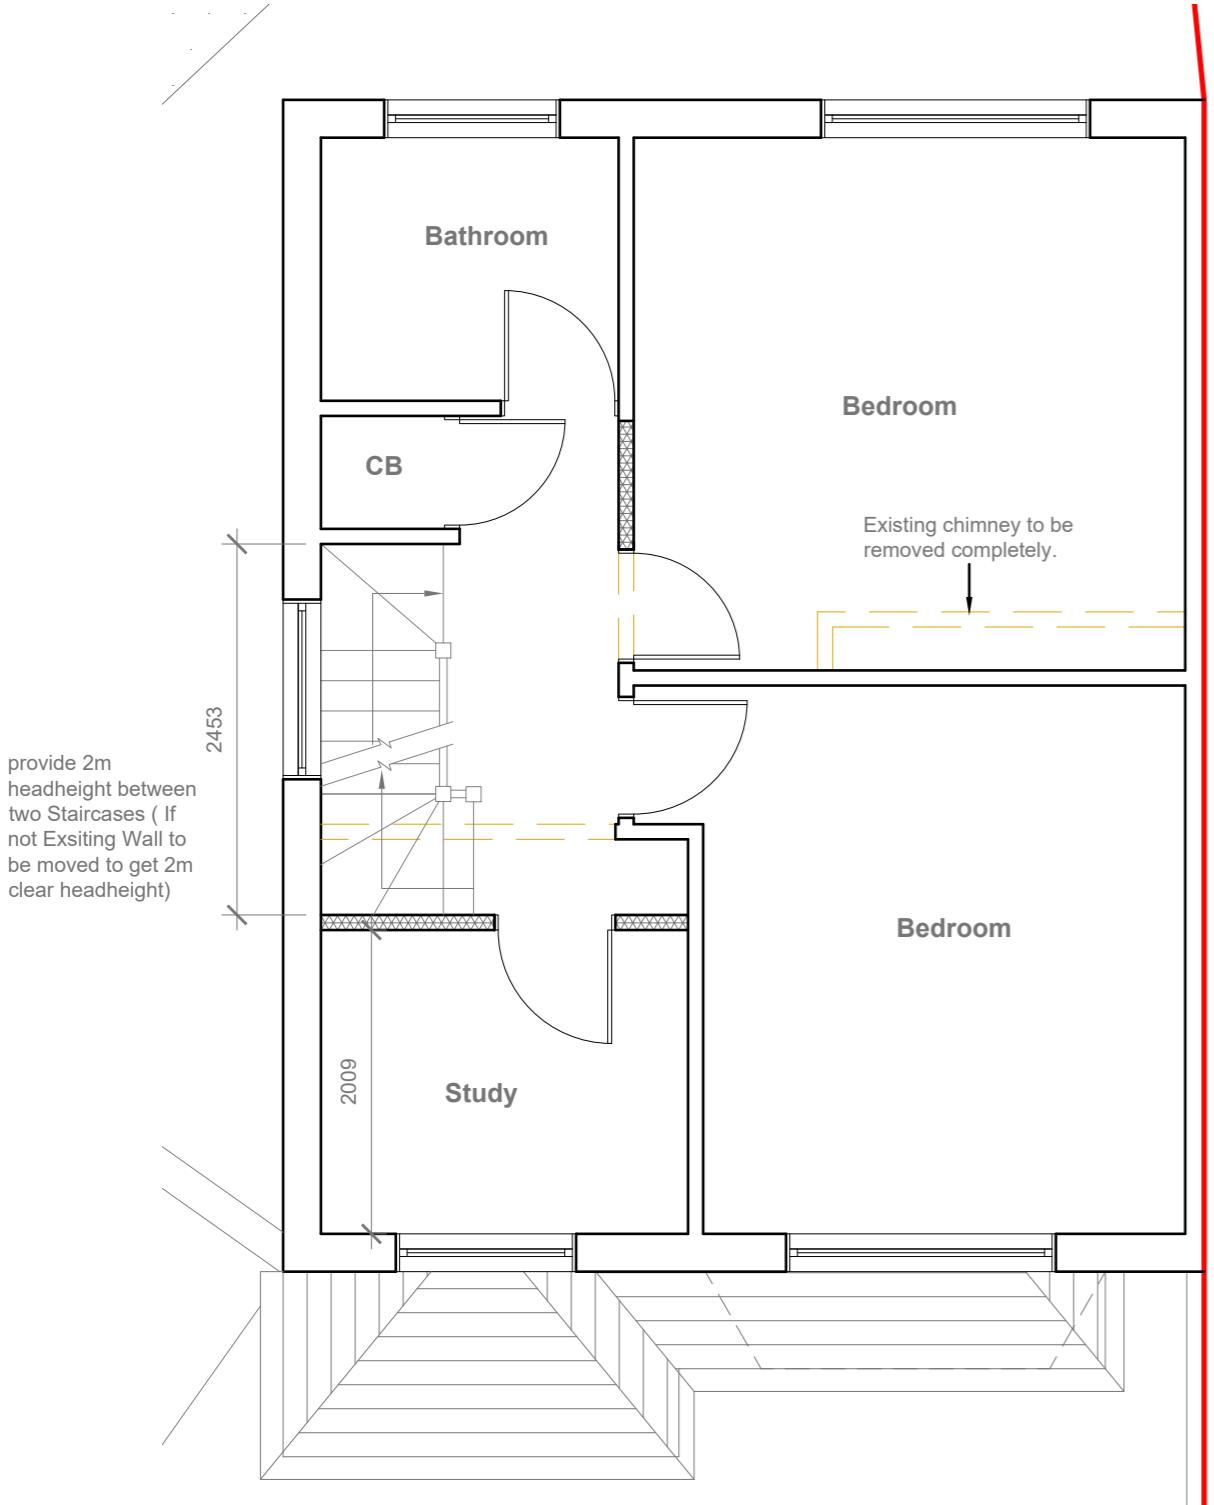
Title:

Proposed Ground Floor Plan

Site Address 91 Raeburn Road, Hayes. UB4 8PN	Scale: 1:50 @A3 Date: 23/01/2024 Drawing No.: 2024/010 -03 Drawn By: RO
Revision Date: <hr/> <hr/> <hr/> <hr/>	e:mail - faluckpatel@yahoo.com (M) +44 (0) 7871 466 254

Faluck Patel

Velux Window to be installed as per manufacturer specification, not projected more than 150mm from the plane of roof slope




GENERAL NOTES:	Title:
1. ALL DIMENSIONS ARE IN MILLIMETER.	
2. VERIFY ALL DIMENSIONS AND CONDITIONS BEFORE BUILDING OR STARTING CONSTRUCTION. NOTIFY THE DESIGNER IMMEDIATELY OF ANY DISCREPANCY OR VARIATION.	
3. ALL WORK TO COMPLY WITH CURRENT BUILDING REGULATIONS AND CODES OF PRACTICE	

Proposed First Floor & Loft Plans

Site Address	Scale: 1:50 @A3	Revision Date:
91 Raeburn Road, Hayes. UB4 8PN	Date: 23/01/2024	
	Drawing No.: 2024/010 -04	
	Drawn By:	
	RO	e:mail - faluckpatel@yahoo.com (M) +44 (0) 7871 466 254



Proposed Front Elevation
Scale 1:100

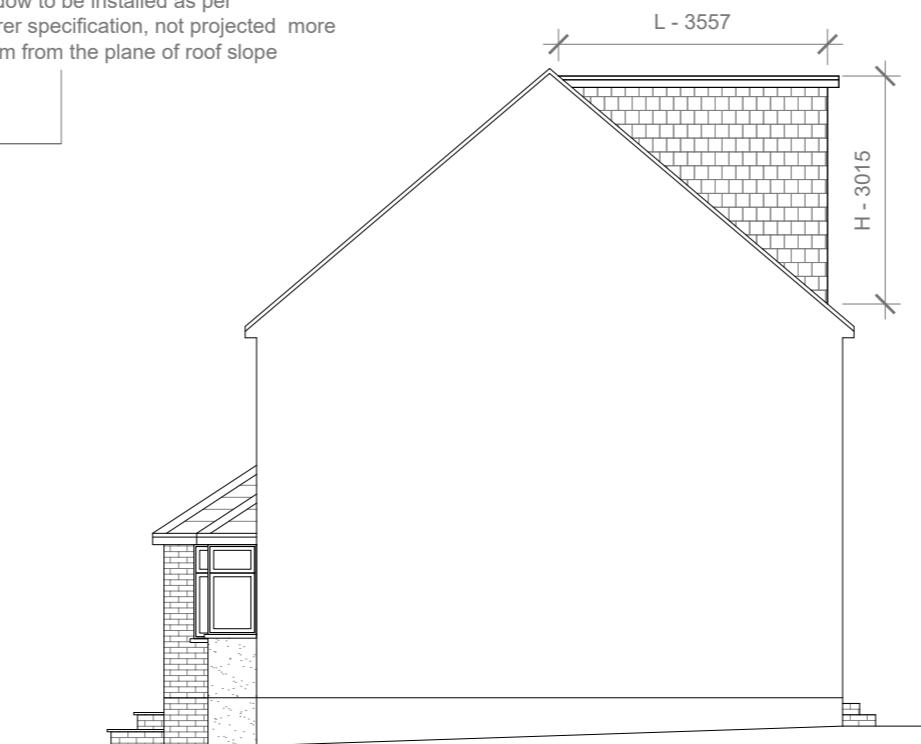

HIP TO GABLE ROOF VOLUME = $W1 \times H1 \times L1 / 6$
 $8.049 \times 3.285 \times 3.875 / 6$
 $102.45 / 6$
 17.07 CU.MT.

V1 =

V2 =

TOTAL ROOF VOLUME =

Proposed External Finish Materials to Match Existing External Finish Materials

W X H X L / 2
 $5.814 \times 3.015 \times 3.557 / 2$
 $62.35 / 2$
 31.17 CU.MT.

W1 X H1 X L1 / 6
 $8.049 \times 3.285 \times 3.875 / 6$
 $102.45 / 6$
 17.07 CU.MT.

V1 + V2
 $31.17 + 17.07$
 $48.24 \text{ CU.MT.} < 50.00 \text{ CU.MT.}$



Proposed Rear Elevation
Scale 1:100



Proposed Side Elevation
Scale 1:100

10 Meter
5
2
1
0

1:100

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Title:

Proposed Elevations

Site Address
91 Raeburn Road,
Hayes,
UB4 8PN

Scale: 1:100 @A3
Date: 23/01/2024
Drawing No.: 2024/010 -05
Drawn By:
RO

Revision Date:

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