

GENERAL NOTES:
 1. ALL DIMENSIONS ARE IN MILLIMETER.
 2. VERIFY ALL DIMENSIONS AND CONDITIONS BEFORE BUILDING OR
 STARTING CONSTRUCTION. NOTIFY THE DESIGNER IMMEDIATELY OF ANY
 DISCREPANCY OR VARIATION.
 3. ALL WORK TO COMPLY WITH CURRENT BUILDING REGULATIONS
 AND CODES OF PRACTICE

Title:


Existing Floor Plans & Elevations

Site Address
64 Raynton Drive,
Hayes.
Middx.
UB4 8BE

Scale: 1:100 @A3
Date: 08/12/2023
Drawing No.: 2023/160 -01PD
Drawn By:
RO

Revision Date:
e:mail -
faluckpatel@yahoo.com
(M) +44 (0) 7871 466 254

Faluck Patel

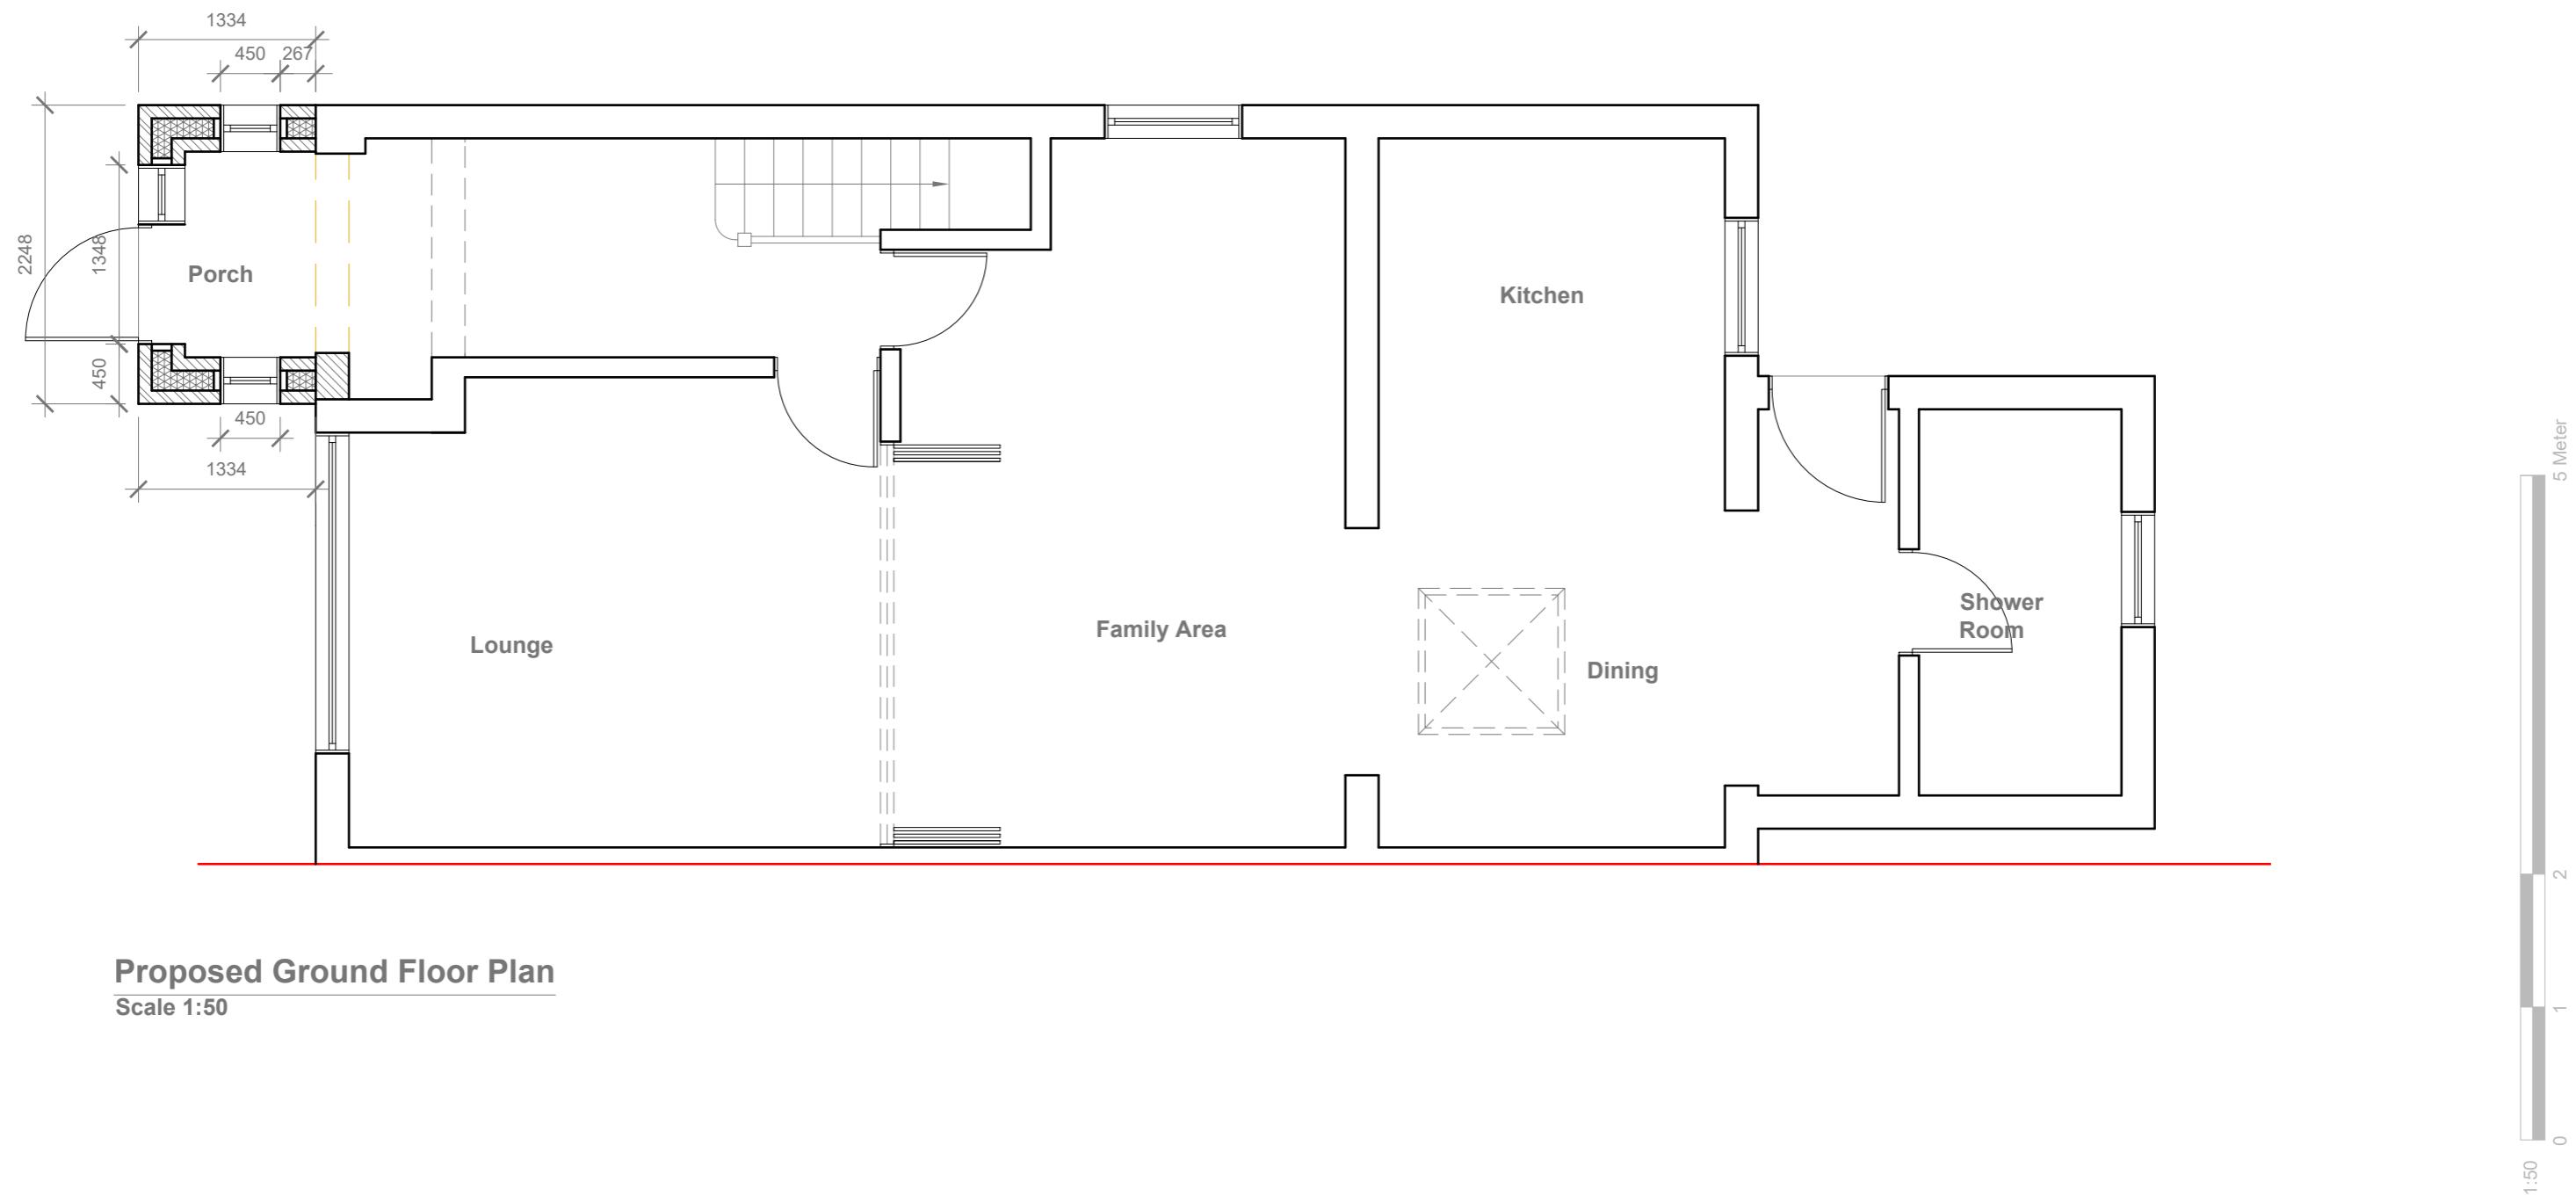

Proposed Ground Floor Plan

Scale 1:50

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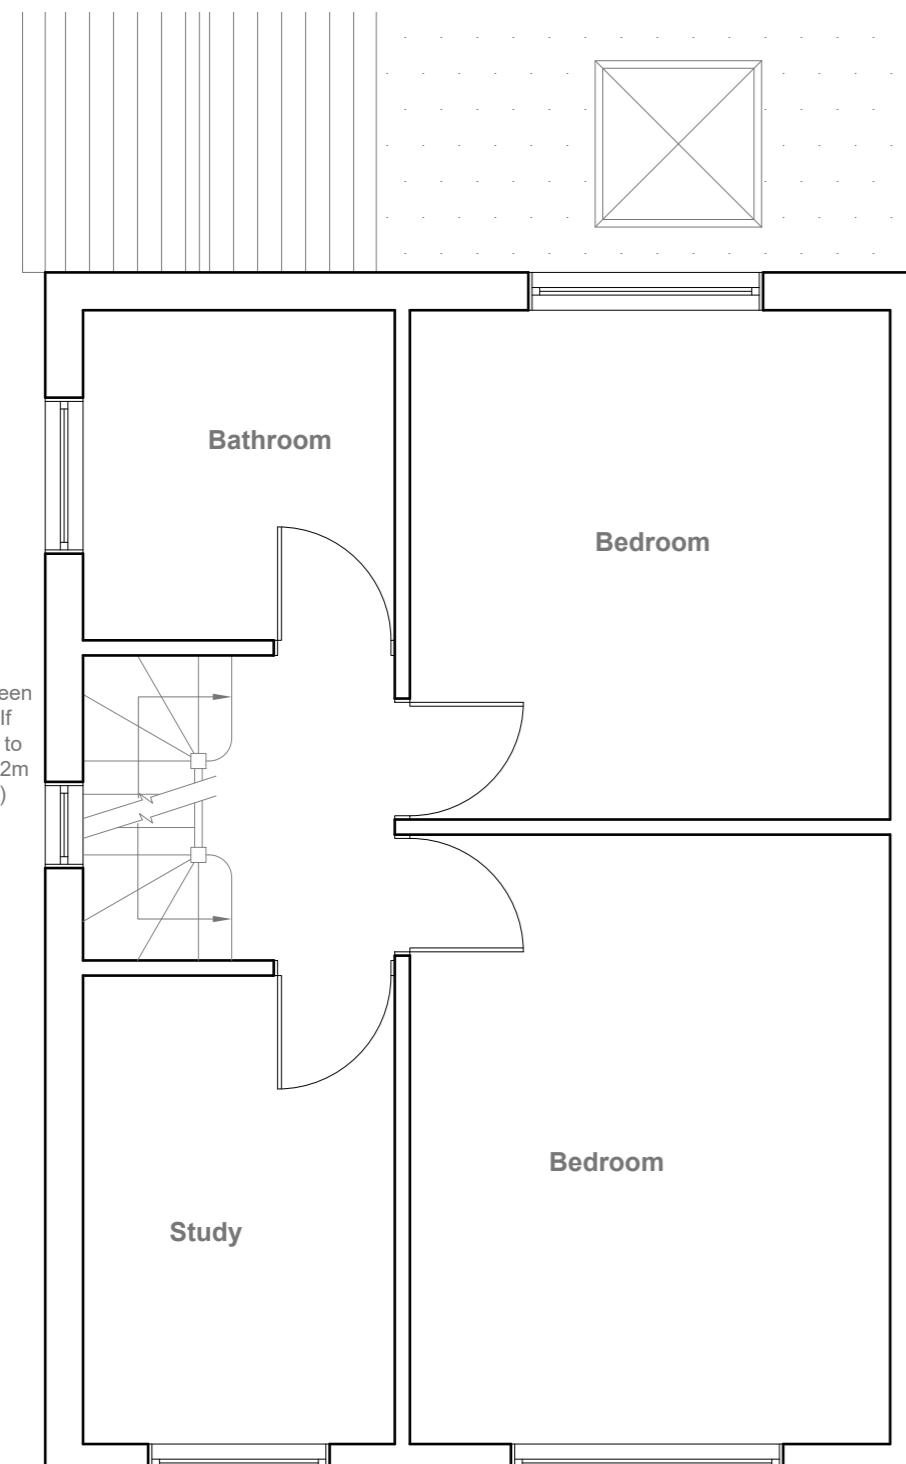
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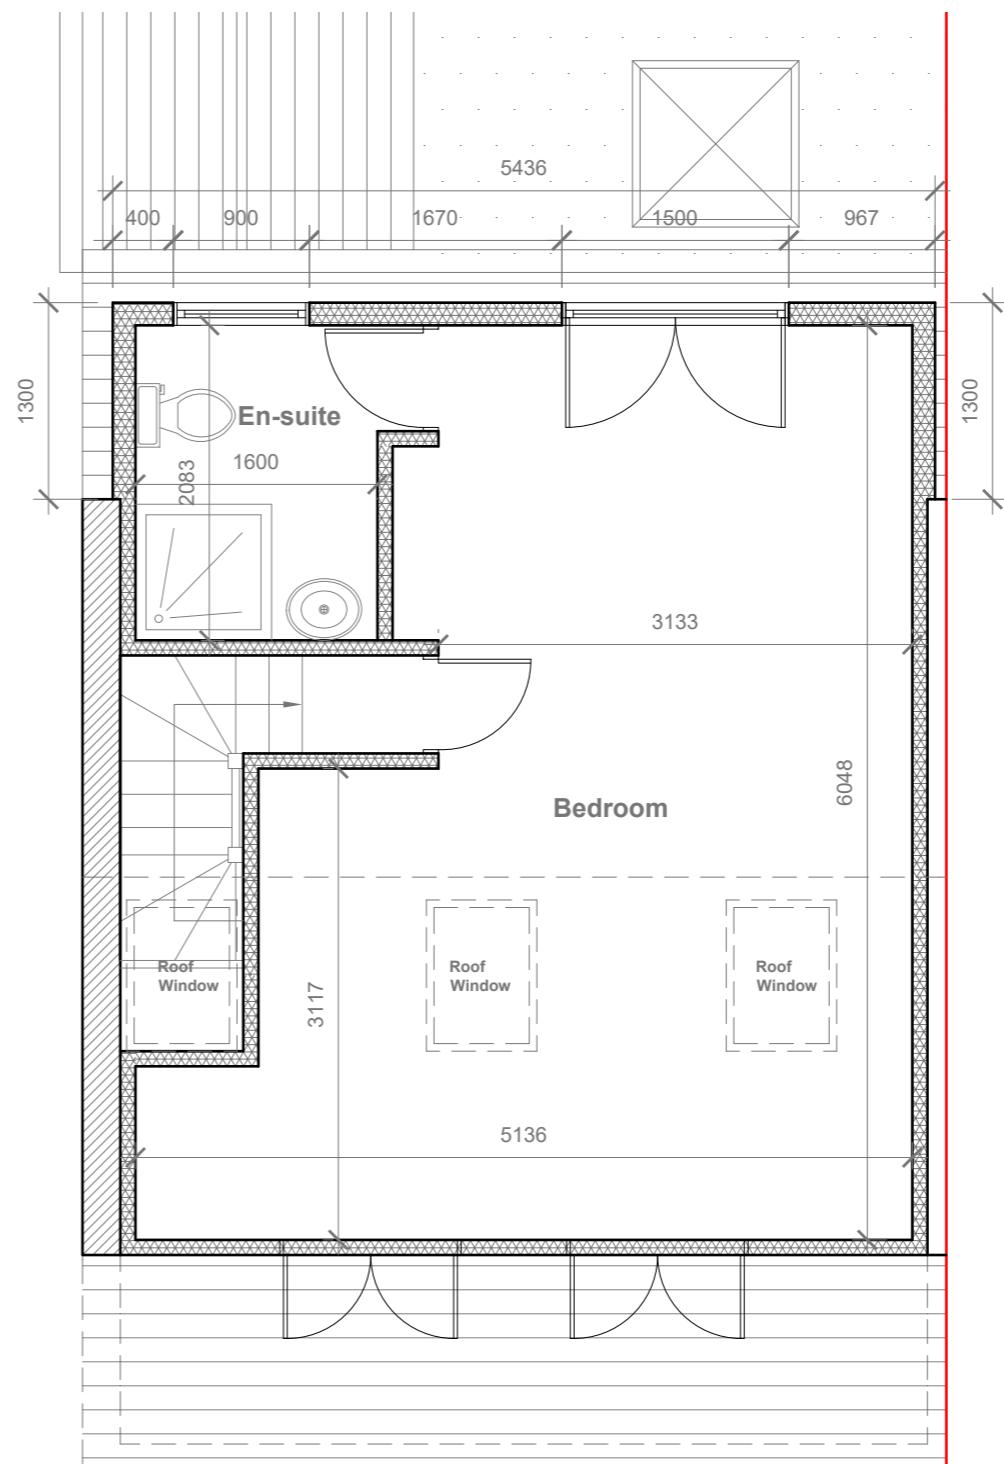
Revision Date:

Velux Window to be installed as per manufacturer specification, not projected more than 150mm from the plane of roof slope



Proposed First Floor Plan

Scale 1:50



Proposed Loft Floor Plan

Scale 1:50

1:50
0 1 2 5 Meter

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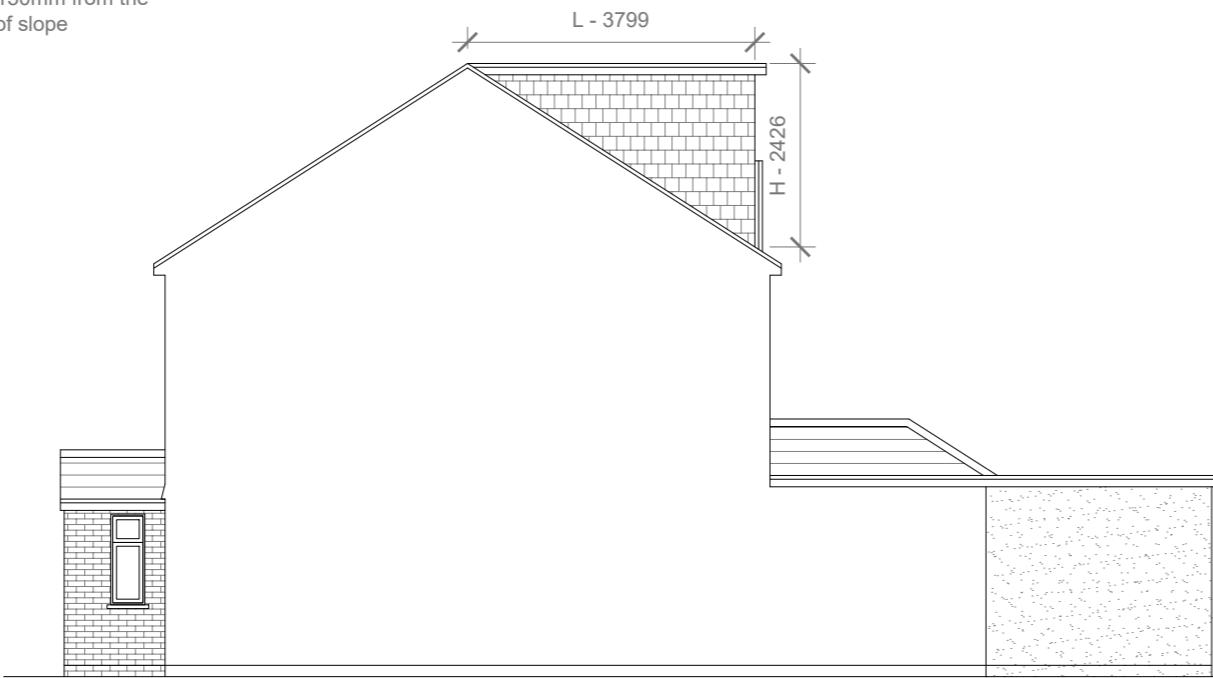
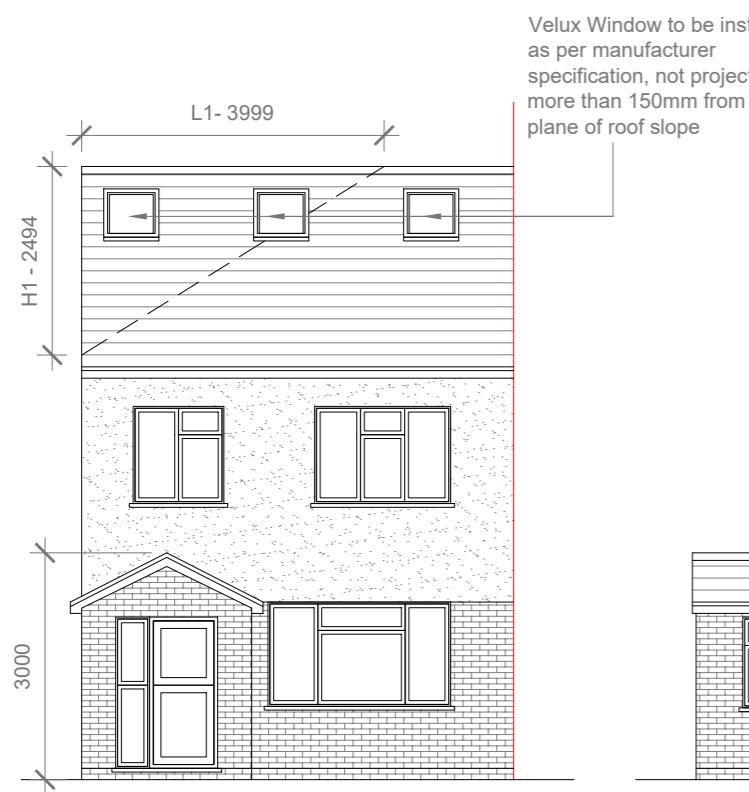
Proposed First Floor & Loft Plans

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REAR DORMER VOLUME = $W \times H \times L / 2$
 $5.436 \times 2.426 \times 3.799 / 2$
 $50.10 / 2$
 25.05 CU.MT.

HIP TO GABLE ROOF VOLUME = $W1 \times H1 \times L1 / 6$
 $8.298 \times 2.494 \times 3.999 / 6$
 $82.27 / 6$
 13.79 CU.MT.

TOTAL ROOF VOLUME = $V1 + V2$
 $25.05 + 13.79$
 $38.84 \text{ CU.MT.} < 50.00 \text{ CU.MT.}$

Proposed Front Elevation

Scale 1:100



Proposed Side Elevation

Scale 1:100



Proposed Rear Elevation

Scale 1:100

Proposed Side Elevation

Scale 1:100

10 Meter
5
2
1
0
1:100

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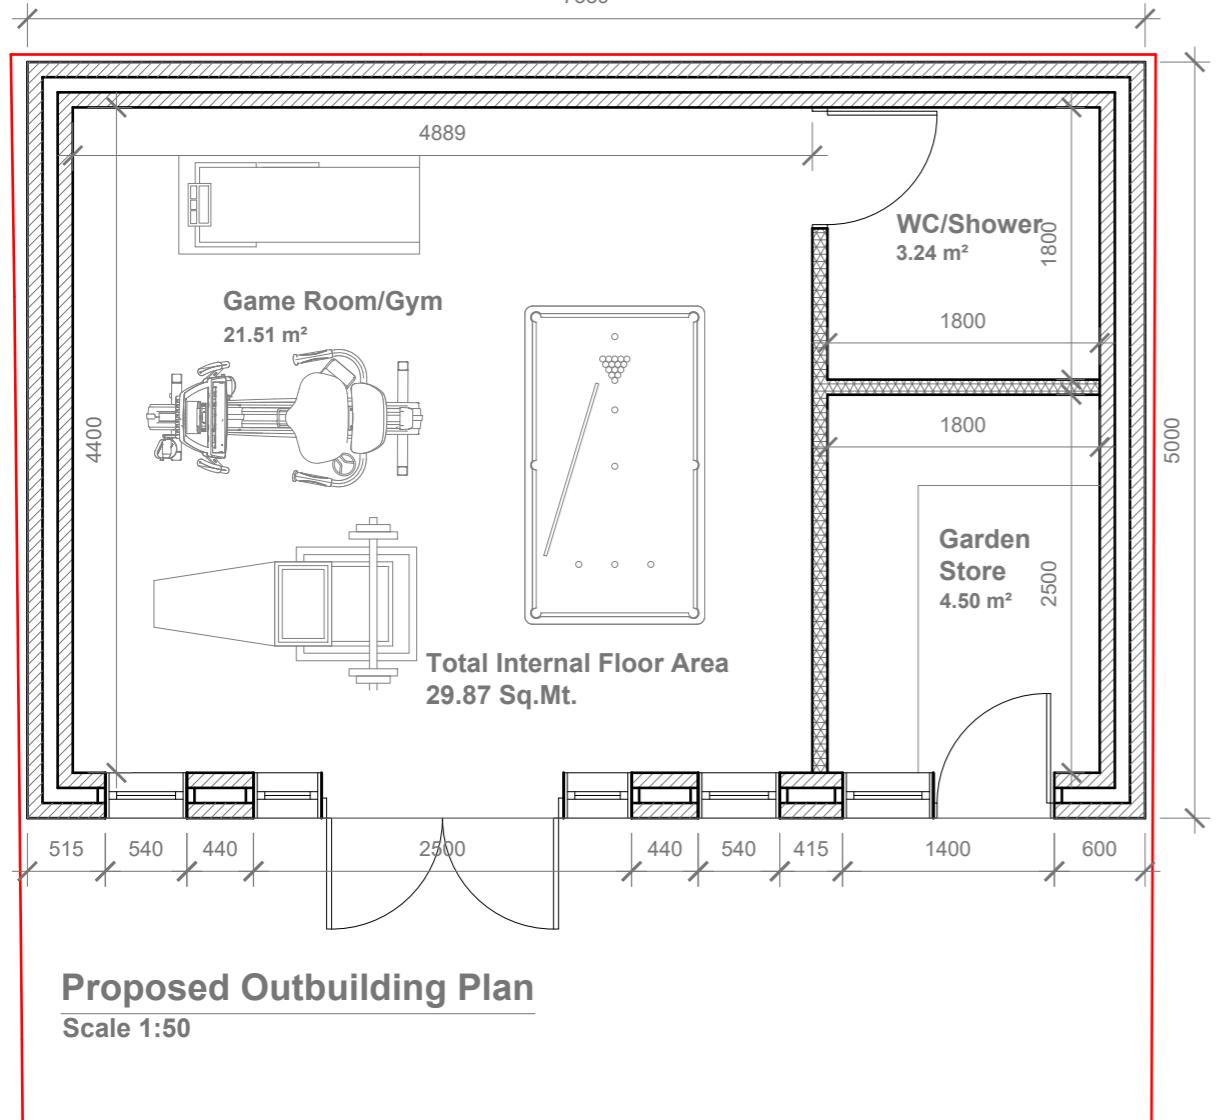
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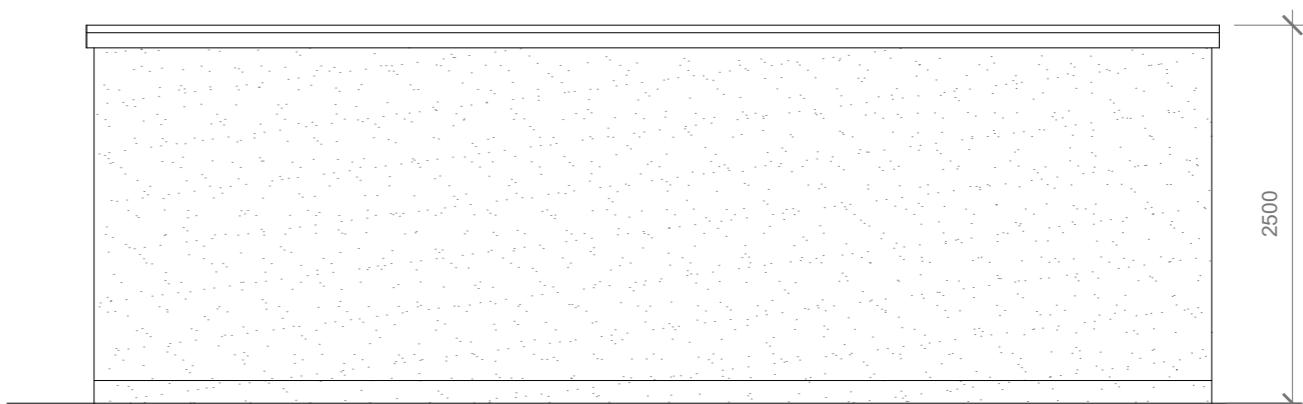


Proposed Outbuilding Plan

Scale 1:50


Proposed Front Elevation

Scale 1:50




Proposed Rear Elevation

Scale 1:50

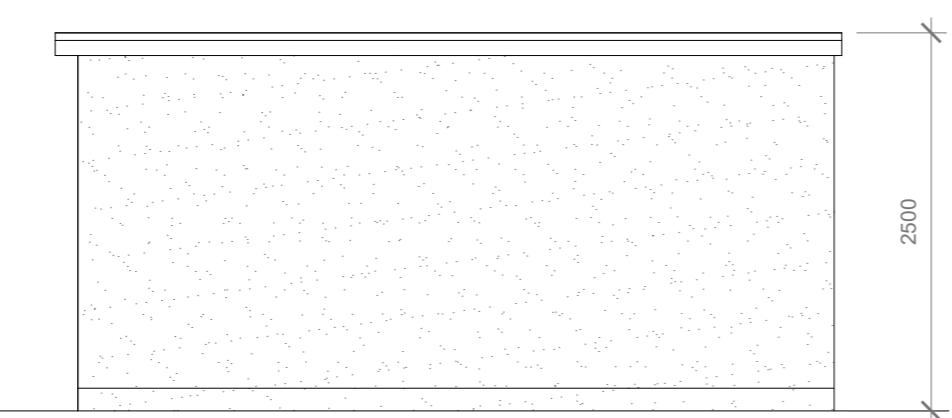

Proposed Side Elevation

Scale 1:50

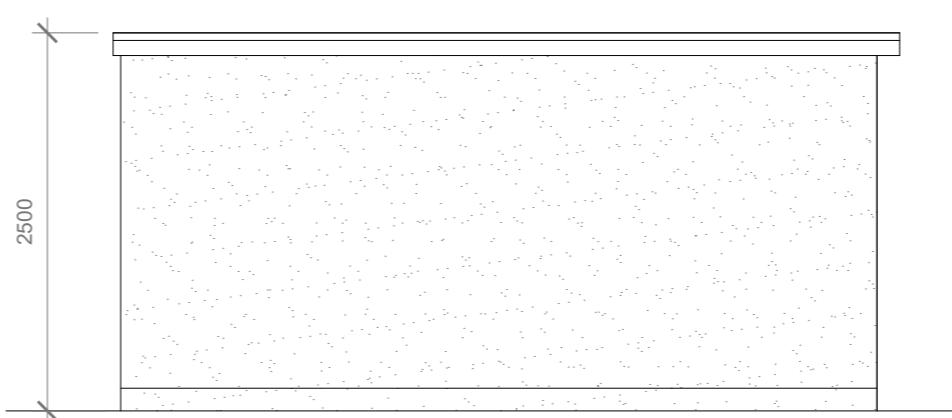

Proposed Side Elevation

Scale 1:50

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