



Scale 1:100

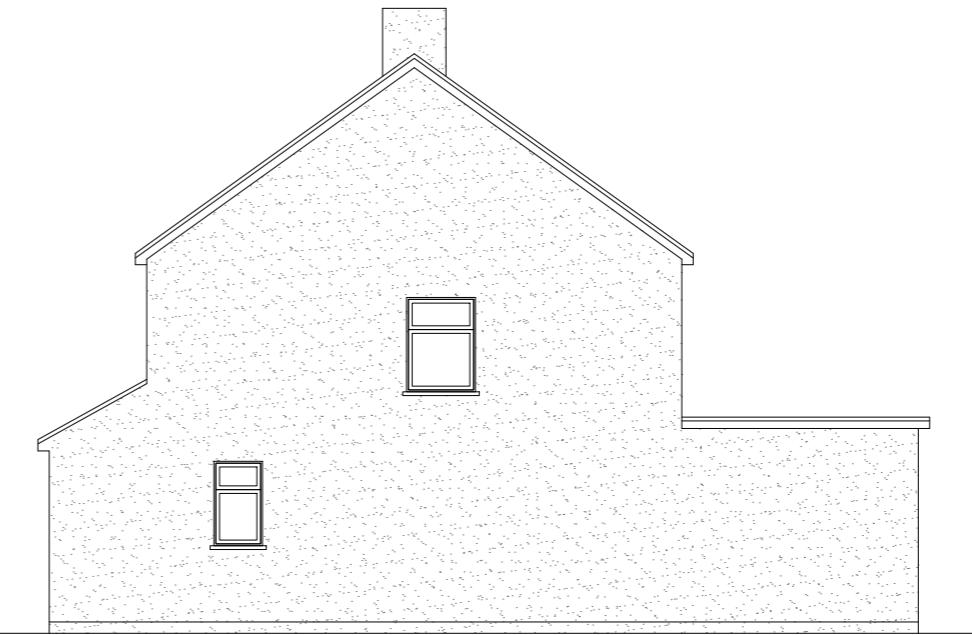


Scale 1:100




Scale 1:100

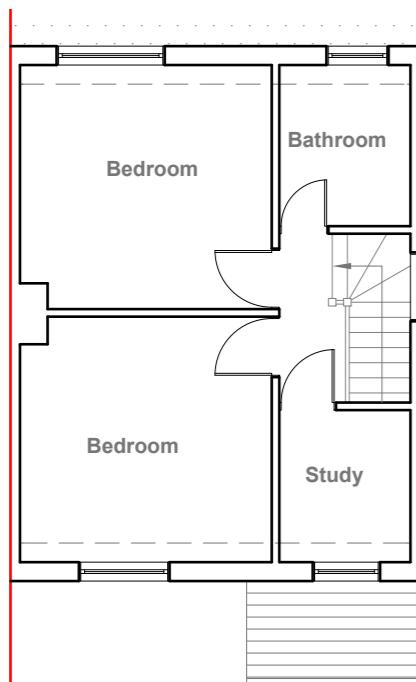

Scale 1:100

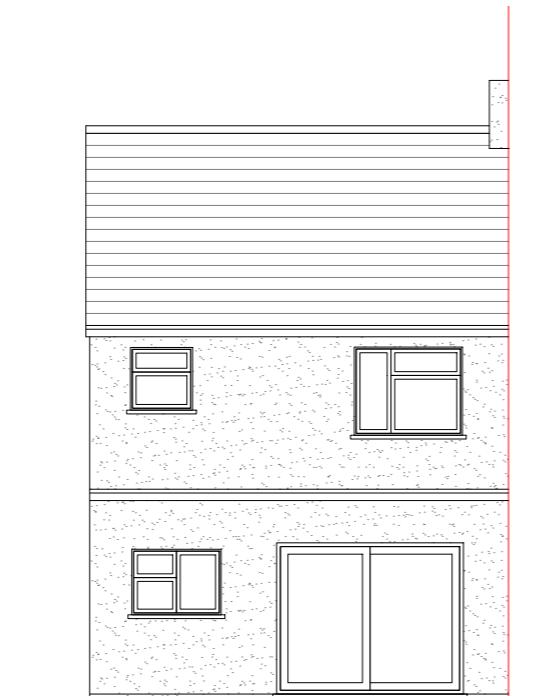

Scale 1:100

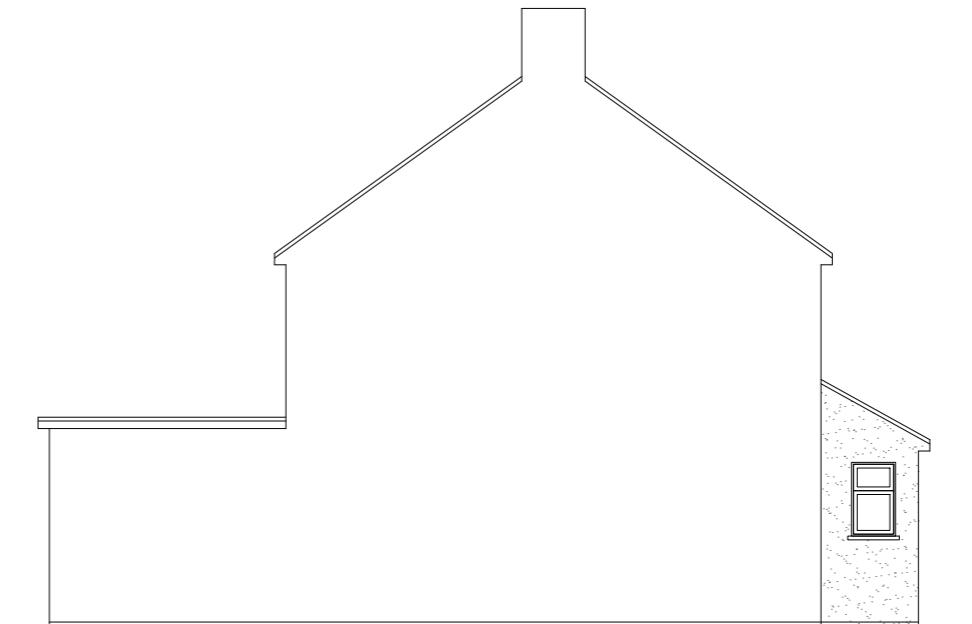

Scale 1:100

10 Meter

1:100

GENERAL NOTES:  
 1. ALL DIMENSIONS ARE IN MILLIMETER.  
 2. VERIFY ALL DIMENSIONS AND CONDITIONS BEFORE BUILDING OR  
 STARTING CONSTRUCTION. NOTIFY THE DESIGNER IMMEDIATELY OF ANY  
 DISCREPANCY OR VARIATION.  
 3. ALL WORK TO COMPLY WITH CURRENT BUILDING REGULATIONS  
 AND CODES OF PRACTICE

Title:


## Existing Floor Plans & Elevations

Site Address  
180 Grosvenor  
Crescent, Uxbridge.  
UB10 9EZ


Scale: 1:100 @A3  
Date: 16/09/2024  
Drawing No.: 2024/154 -01  
Drawn By: RO

Revision Date:  
e:mail - faluckpatel@yahoo.com  
(M) +44 (0) 7871 466 254

Faluck  
Patel

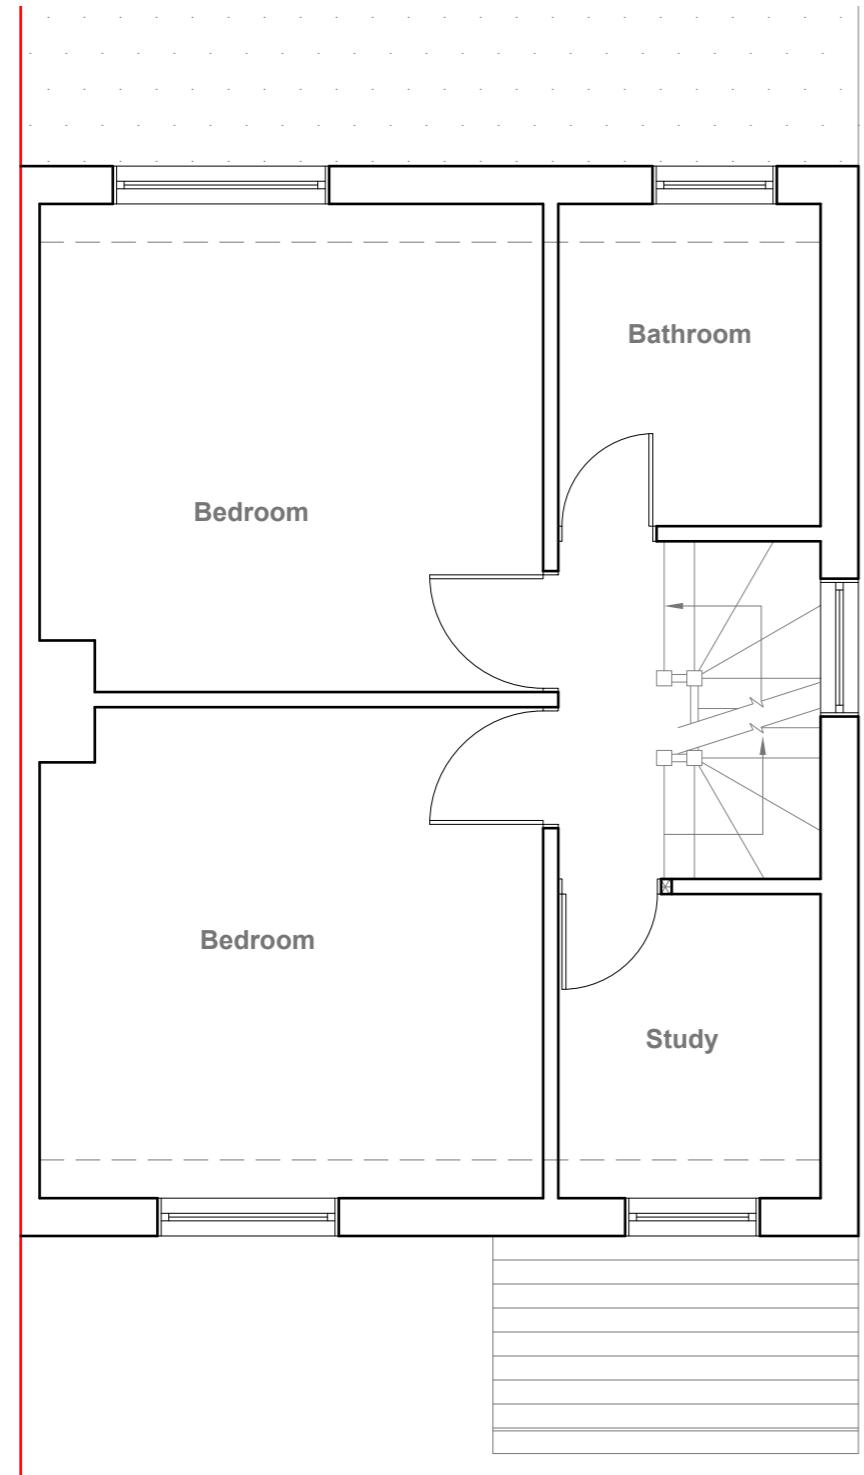

Provide 2m headheight between two Staircases ( If not Exsiting Wall to be moved to get 2m clear headheight)

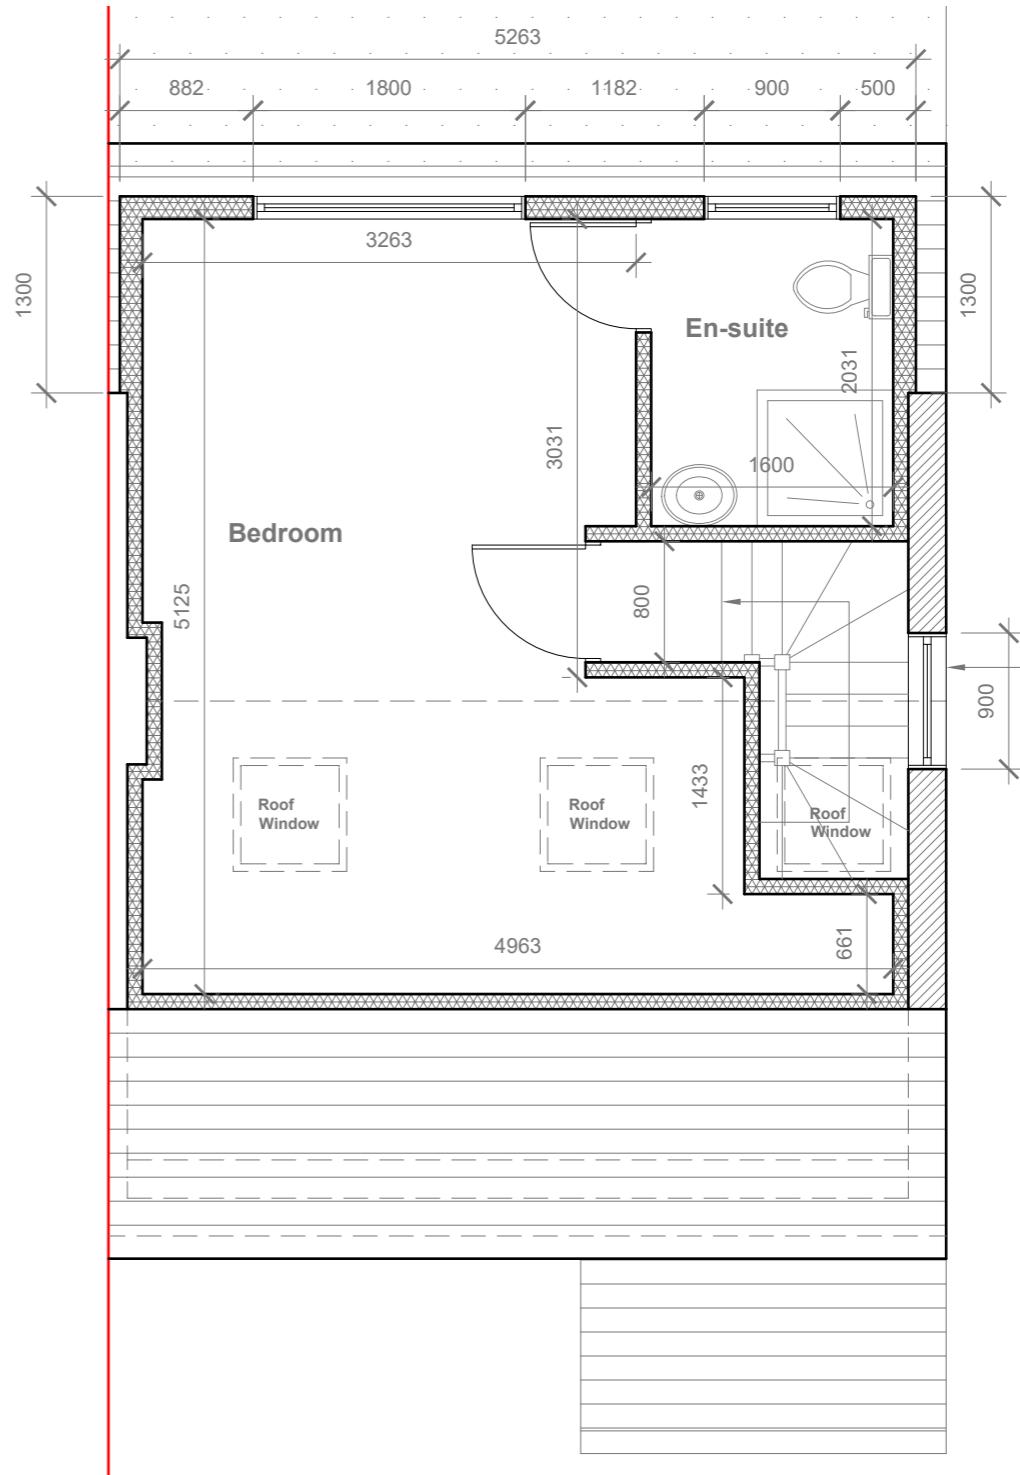


## Proposed First Floor & Loft Plans




**Proposed Front Elevation**

Scale 1:100

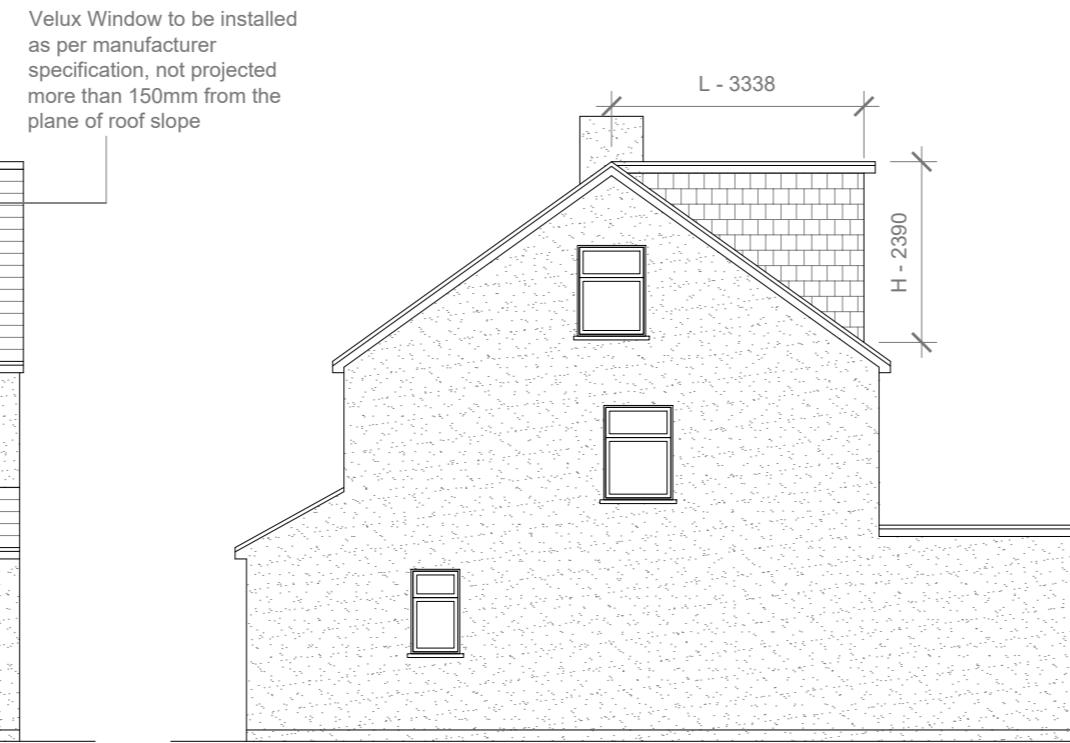


**Proposed Side Elevation**

Scale 1:100

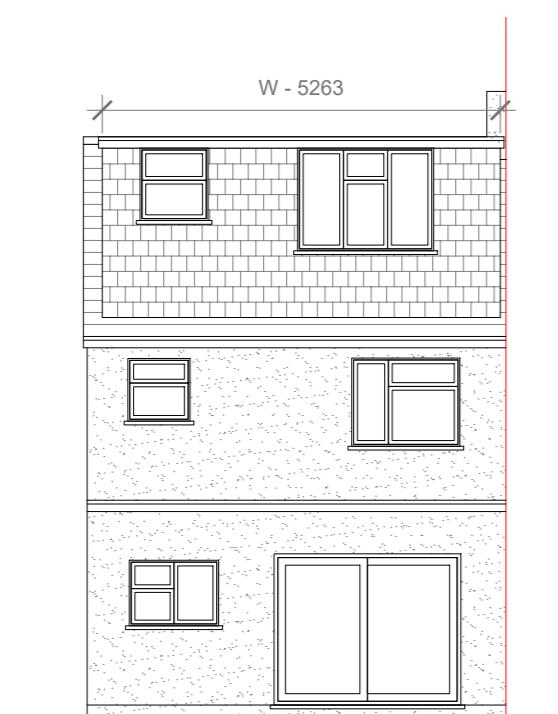

**Proposed Rear Elevation**

Scale 1:100

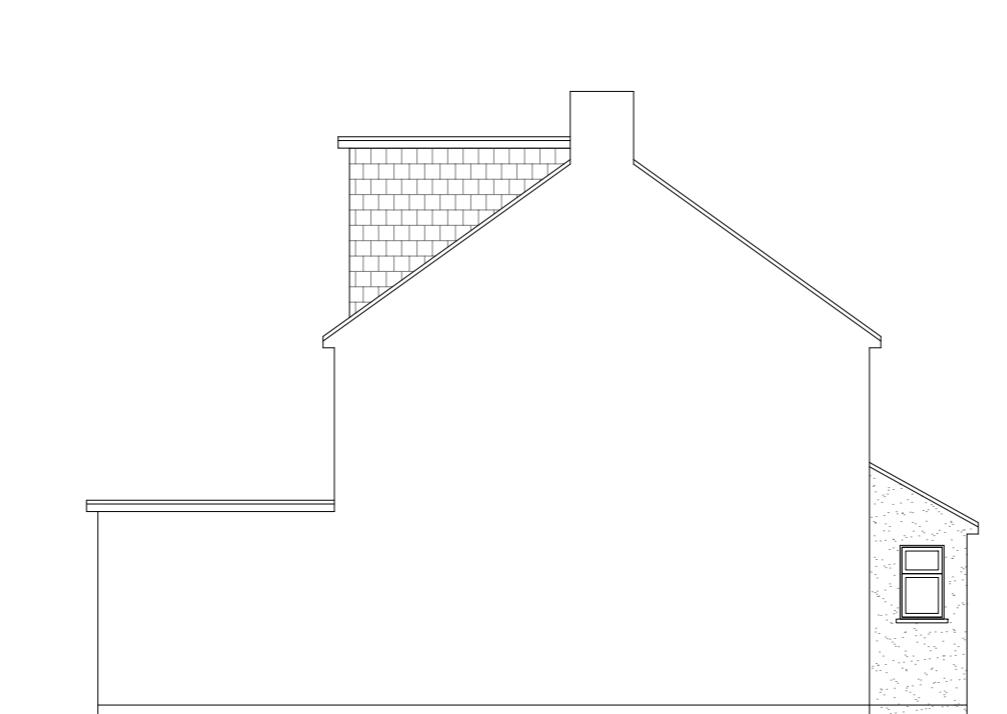

**Proposed Side Elevation**

Scale 1:100

GENERAL NOTES:  
1. ALL DIMENSIONS ARE IN MILLIMETER.  
2. VERIFY ALL DIMENSIONS AND CONDITIONS BEFORE BUILDING OR  
STARTING CONSTRUCTION. NOTIFY THE DESIGNER IMMEDIATELY OF ANY  
DISCREPANCY OR VARIATION.  
3. ALL WORK TO COMPLY WITH CURRENT BUILDING REGULATIONS  
AND CODES OF PRACTICE

Title:

## Proposed Elevations

REAR DORMER VOLUME =

V1 =

$W \times H \times L / 2$   
 $5.263 \times 2.390 \times 3.338 / 2$   
 $41.98 / 2$   
 $20.99 \text{ CU.MT.}$

TOTAL ROOF VOLUME =

V1  
20.99  
20.99 CU.MT. < 40.00 CU.MT

10 Meter  
5  
2  
1  
0  
1:100

Site Address  
180 Grosvenor  
Crescent, Uxbridge.  
UB10 9EZ

Scale: 1:100 @A3  
Date: 16/09/2024  
Drawing No.:  
2024/154 -03

Revision Date:  
Drawn By:  
RO  
e:mail -  
faluckpatel@yahoo.com  
(M) +44 (0) 7871 466 254

**Faluck  
Patel**