



Existing Ground Floor Plan
Scale 1:100



Existing First Floor Plan
Scale 1:100

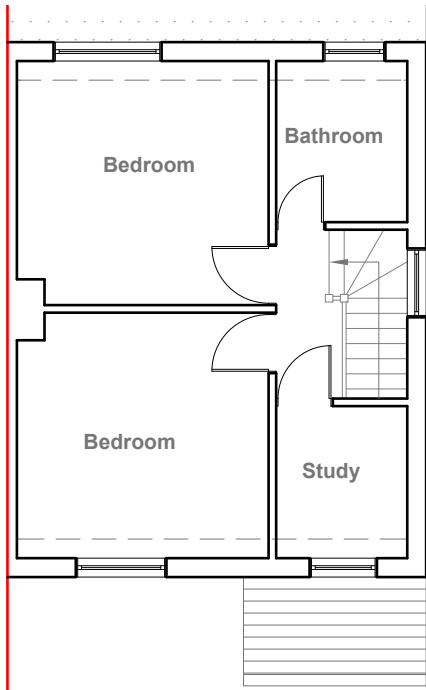


Existing Front Elevation
Scale 1:100

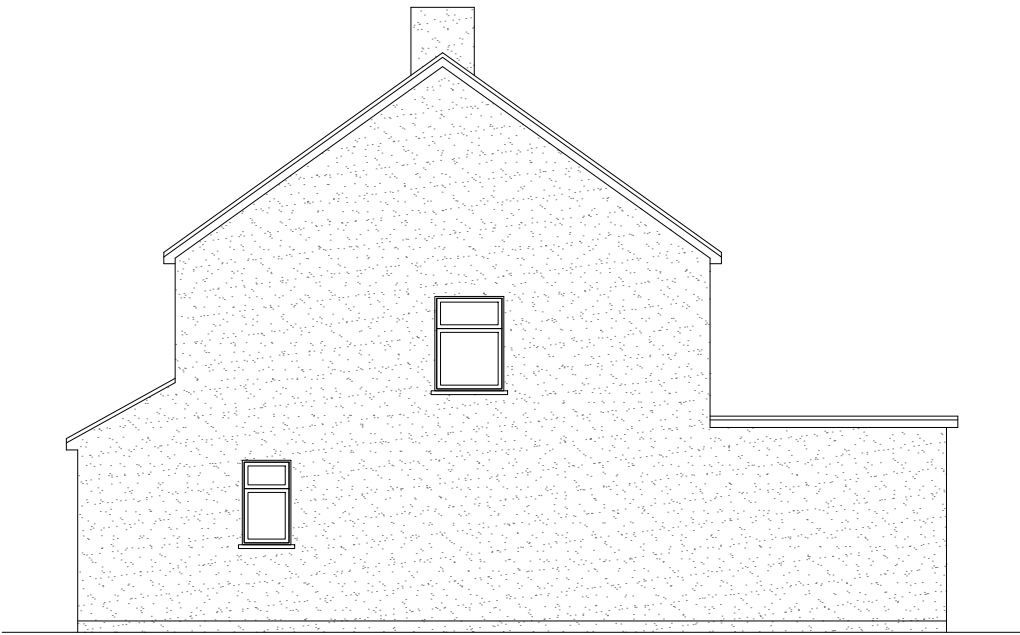

Existing Side Elevation
Scale 1:100



Existing Rear Elevation
Scale 1:100

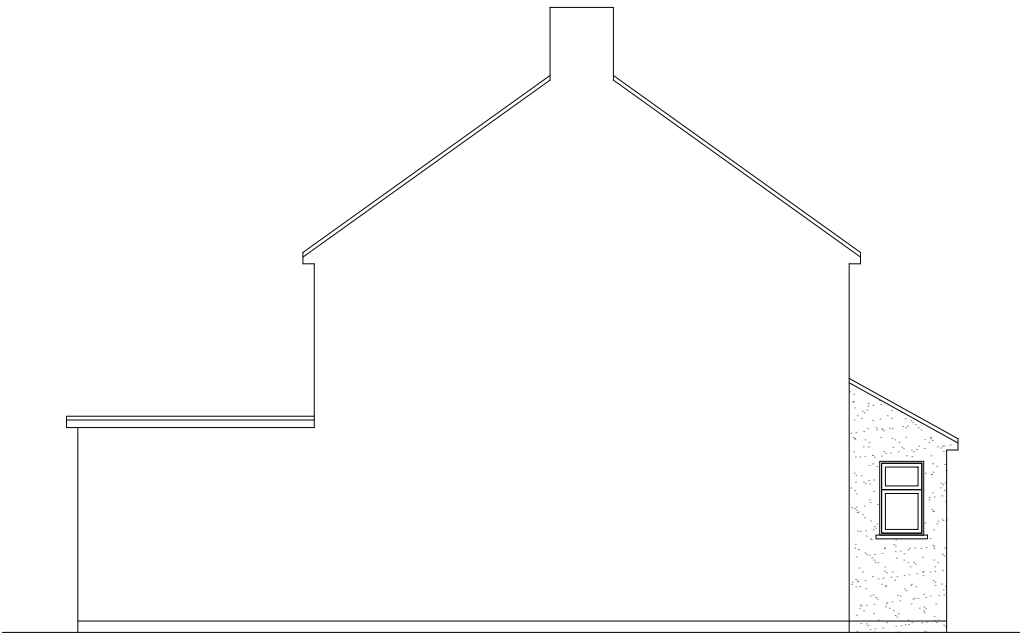

Existing Side Elevation
Scale 1:100




GENERAL NOTES:
1. ALL DIMENSIONS ARE IN MILLIMETER.
2. VERIFY ALL DIMENSIONS AND CONDITIONS BEFORE BUILDING OR STARTING CONSTRUCTION. NOTIFY THE DESIGNER IMMEDIATELY OF ANY DISCREPANCY OR VARIATION.
3. ALL WORK TO COMPLY WITH CURRENT BUILDING REGULATIONS AND CODES OF PRACTICE

Title:


Existing Floor Plans & Elevations

Site Address	Scale: 1:100 @A3	Revision Date:
180 Grosvenor Crescent, Uxbridge. UB10 9EZ	Date: 16/09/2024	
	Drawing No.: 2024/154 -01	
	Drawn By: RO	e:mail - faluckpatel@yahoo.com (M) +44 (0) 7871 466 254



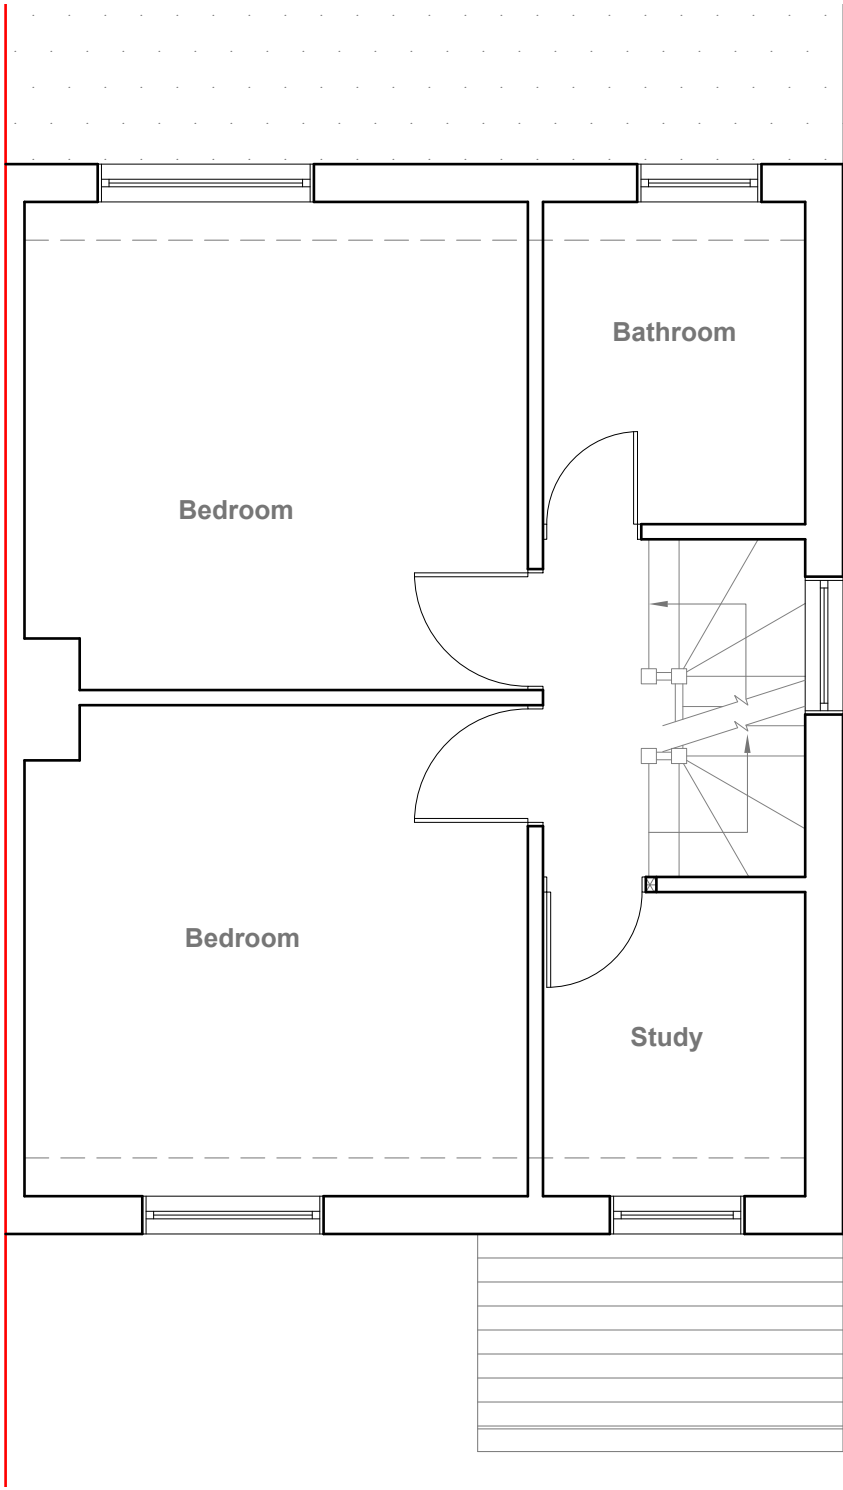

Proposed First Floor Plan
Scale 1:50

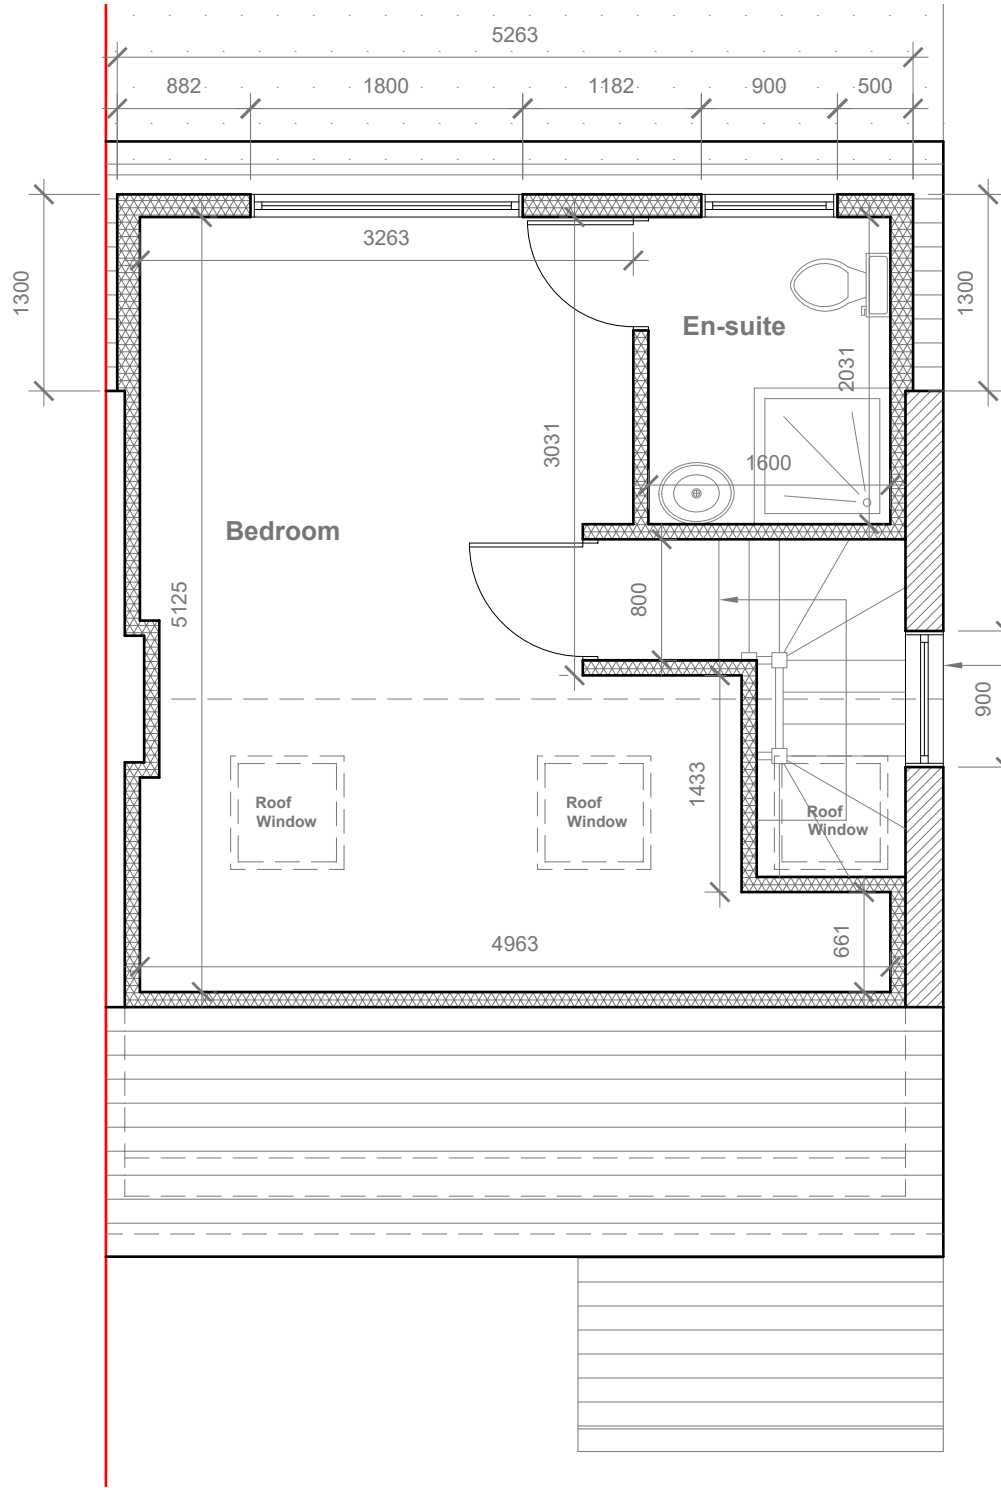

Proposed Loft Floor Plan
Scale 1:50



GENERAL NOTES:
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3. ALL WORK TO COMPLY WITH CURRENT BUILDING REGULATIONS AND CODES OF PRACTICE

Title:


Proposed First Floor & Loft Plans

Site Address	Scale: 1:100 @A3	Revision Date:
180 Grosvenor Crescent, Uxbridge. UB10 9EZ	Date: 16/09/2024	
	Drawing No.: 2024/154 -02	
	Drawn By: RO	e:mail - faluckpatel@yahoo.com (M) +44 (0) 7871 466 254







Proposed Front Elevation
Scale 1:100

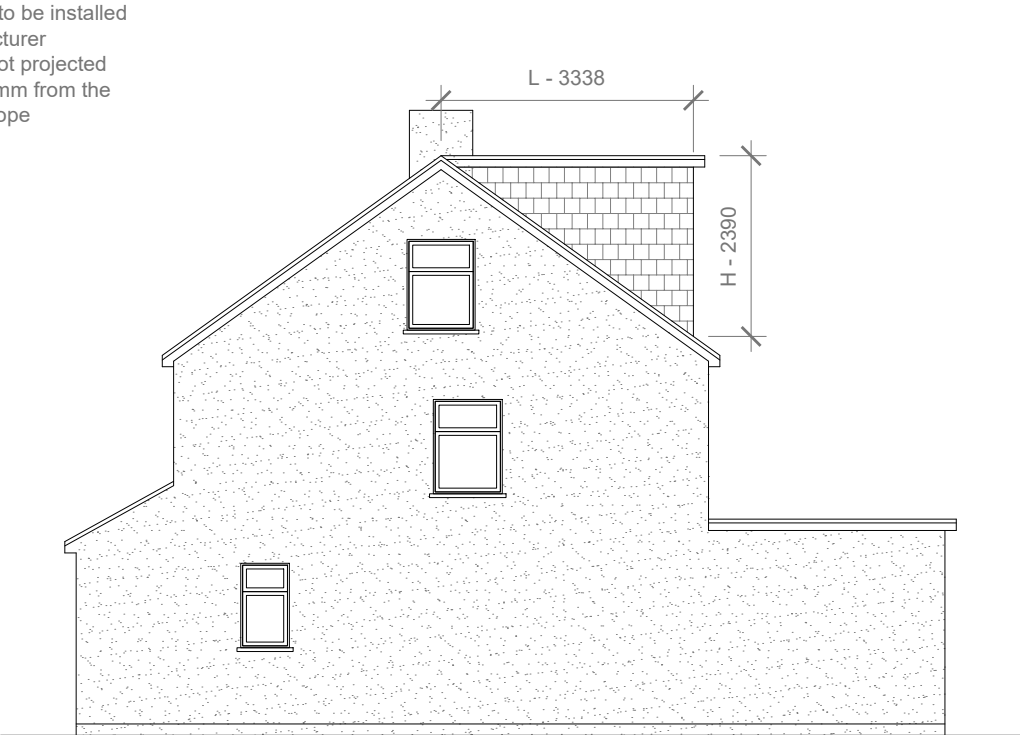

Proposed Side Elevation
Scale 1:100

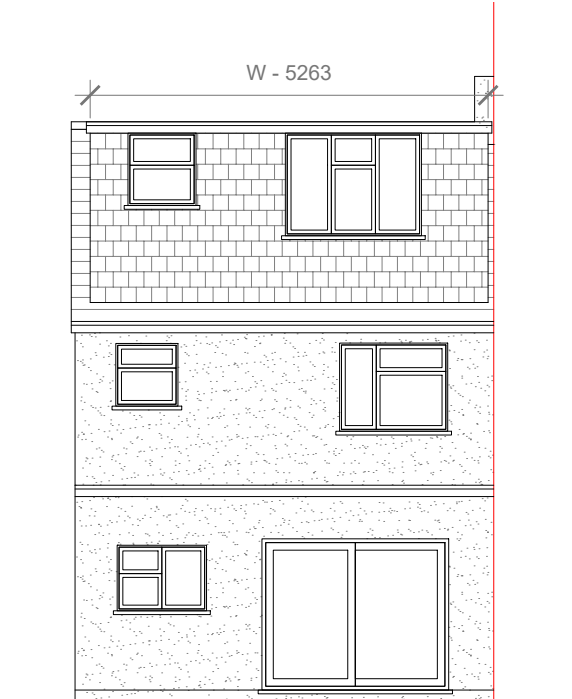

Proposed Rear Elevation
Scale 1:100

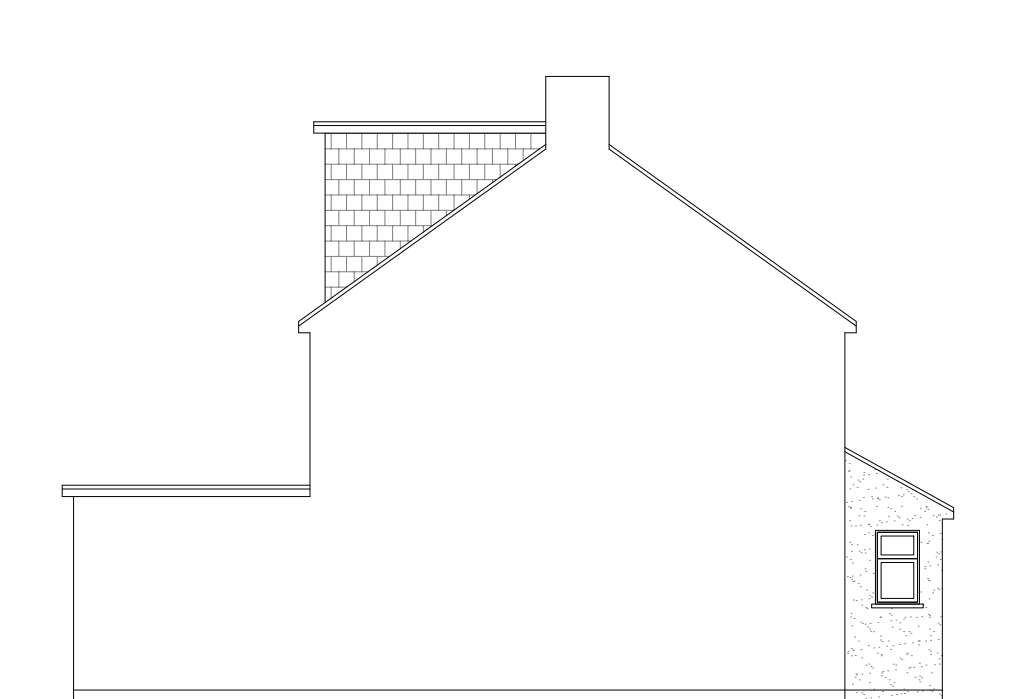

Proposed Side Elevation
Scale 1:100

REAR DORMER VOLUME = $W \times H \times L / 2$
 $5.263 \times 2.390 \times 3.338 / 2$
 $41.98 / 2$
 20.99 CU.MT.

V1 = 20.99

TOTAL ROOF VOLUME = $V1$
 20.99
 $20.99 \text{ CU.MT.} < 40.00 \text{ CU.MT}$



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Title:
Proposed Elevations

Site Address	Scale: 1:100 @A3	Revision Date:
180 Grosvenor Crescent, Uxbridge. UB10 9EZ	Date: 16/09/2024	
	Drawing No.: 2024/154 -03	
	Drawn By: RO	e:mail - faluckpatel@yahoo.com (M) +44 (0) 7871 466 254

