

Amendment		
A	Roof conversion revised	24/11/2023

### VOLUME CALCULATION

#### EXISTING FLAT ROOF VOID

$$1) \text{ Vol} = 52 \times 0.01 = 0.5\text{m}^3$$

#### PROPOSED GABLE ROOF EXTENSION

$$2) \text{ Vol} = \frac{0.5 \times 6.48 \times 3.24 \times 2.62}{3} = 9.17\text{m}^3$$

#### PROPOSED DORMER


$$3) \text{ Vol} = 5.72 \times 2.39 \times 2.95 \times 0.5 \times 2 = 40.33\text{m}^3$$

TOTAL VOLUME PROPOSED = 50m<sup>3</sup>

EQUAL TO THE 50m<sup>3</sup> ALLOWED UNDER PERMITTED DEVELOPMENT FOR LOFT EXTENSIONS



South Elevation

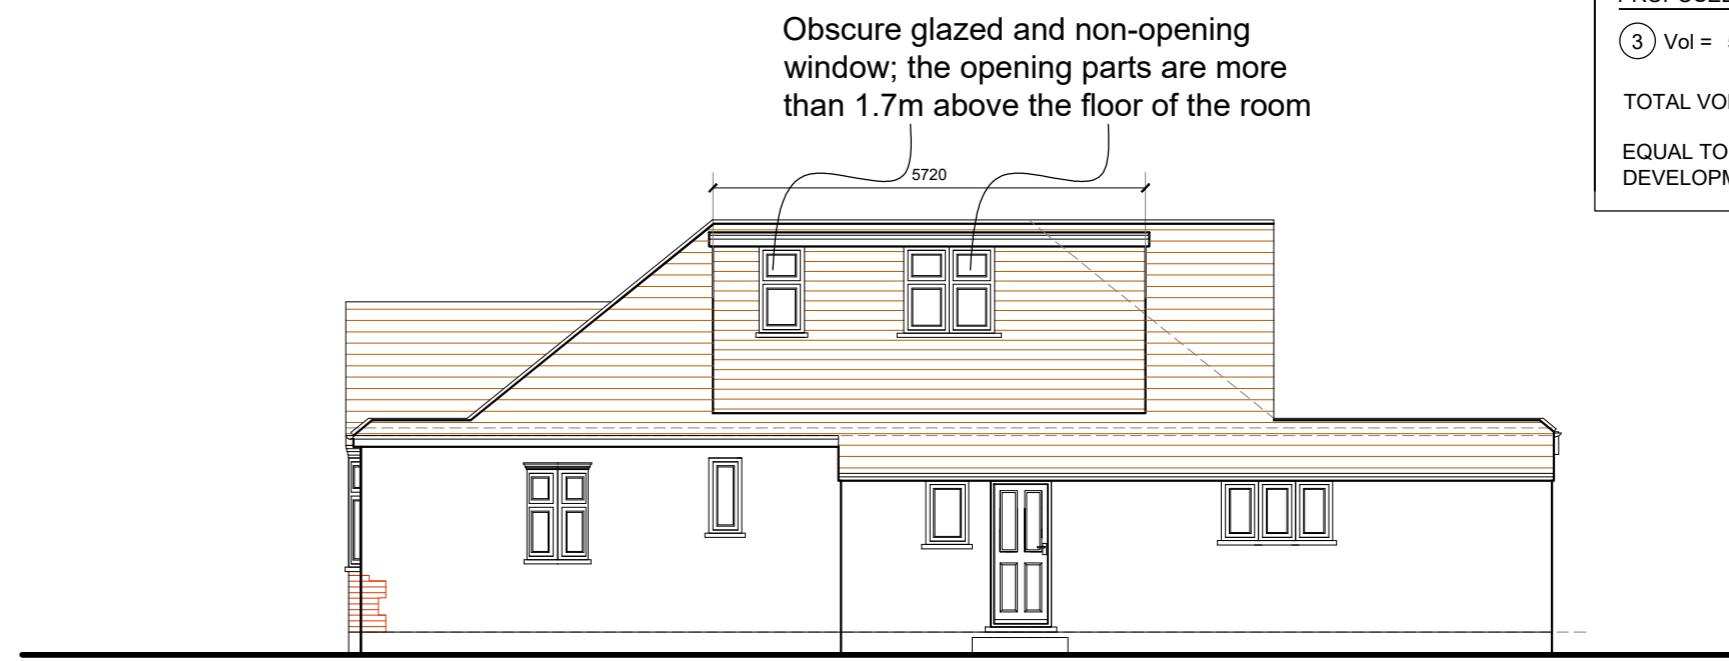


East Elevation

ALL MATERIALS TO MATCH EXISTING



North Elevation

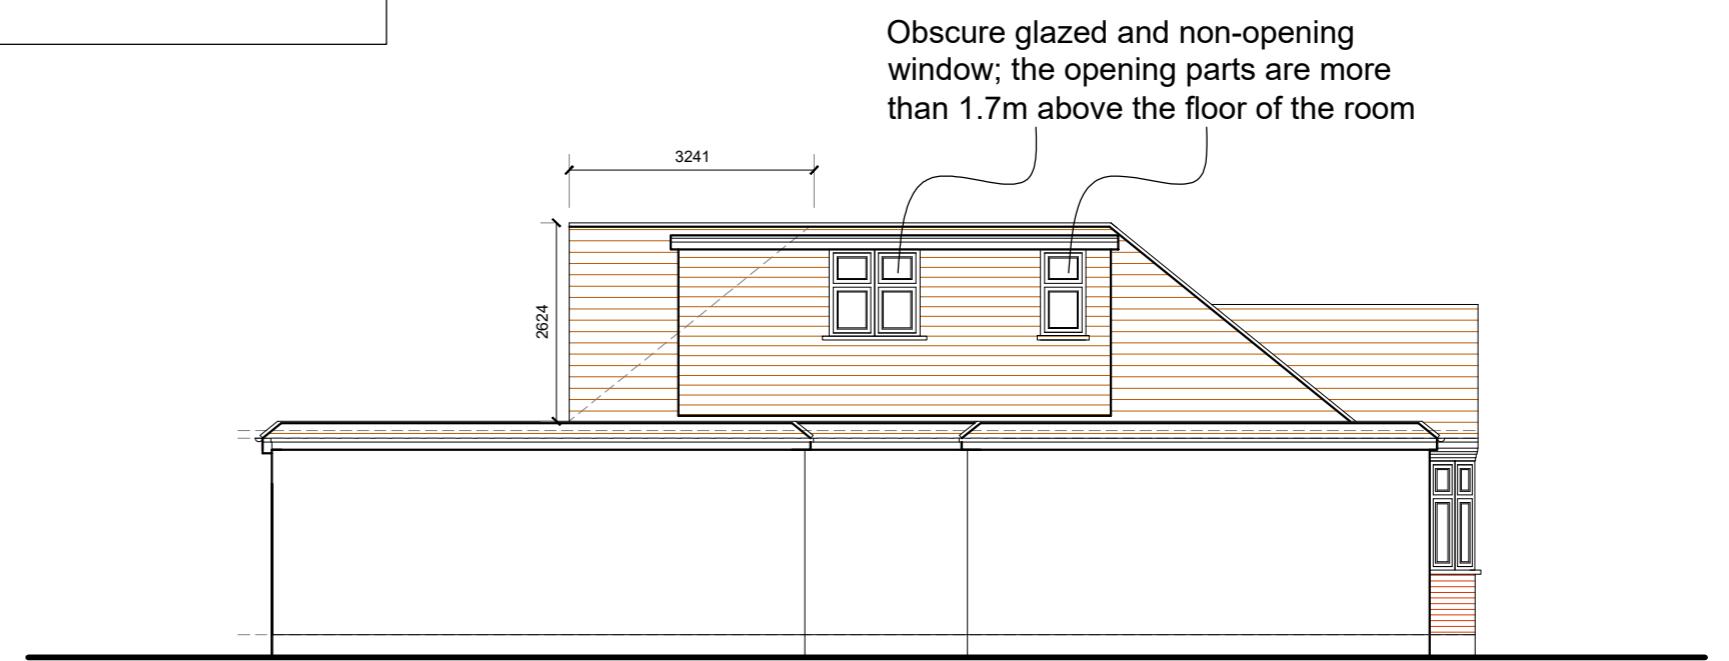

West Elevation

### PROPOSED ELEVATIONS

20 Elgar Close, Ickenham, Uxbridge,  
UB10 8HN

Scale Bar

1:100 @ A2  
0 1 2 3 4 5 6 7 8 9 10 Metres



THE GILLETT MACLEOD PARTNERSHIP  
Chartered Architects & Town Planning Consultants  
1 High Road Old Eastcote Pinner Middlesex HA5 2EW tel. 0208 868 1333

Drg. No. 23/3591/07 A  
Scale 1:100  
Date 27/09/23  
Drawn by KH

REVISION  
A  
C  
drawer