



Amendment		
A	Roof conversion revised	24/11/2023

VOLUME CALCULATION	
EXISTING FLAT ROOF VOID	
①	Vol = 52 x 0.01 = 0.5m³
PROPOSED GABLE ROOF EXTENSION	
②	Vol = $\frac{0.5 \times 6.48 \times 3.24 \times 2.62}{3}$ = 9.17m³
PROPOSED DORMER	
③	Vol = 5.72 x 2.39 x 2.95 x 0.5 x 2 = 40.33m³
TOTAL VOLUME PROPOSED = 50m³	
EQUAL TO THE 50m³ ALLOWED UNDER PERMITTED DEVELOPMENT FOR LOFT EXTENSIONS	

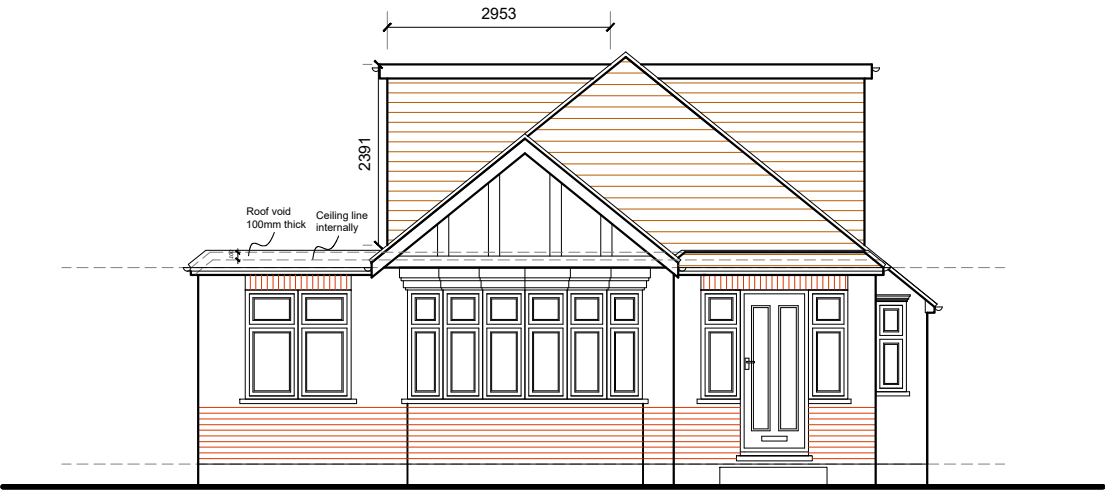

South Elevation

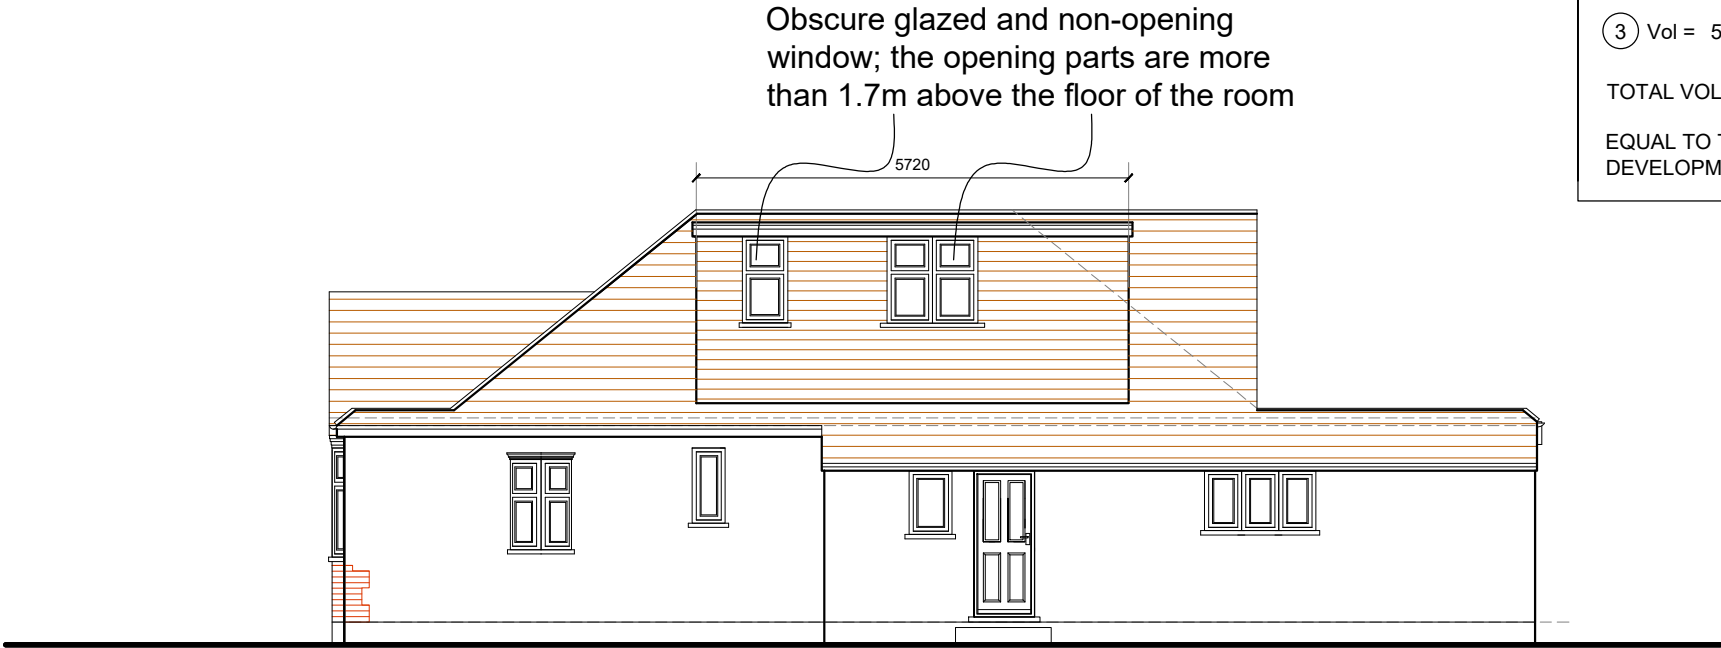


East Elevation

ALL MATERIALS TO MATCH EXISTING




North Elevation

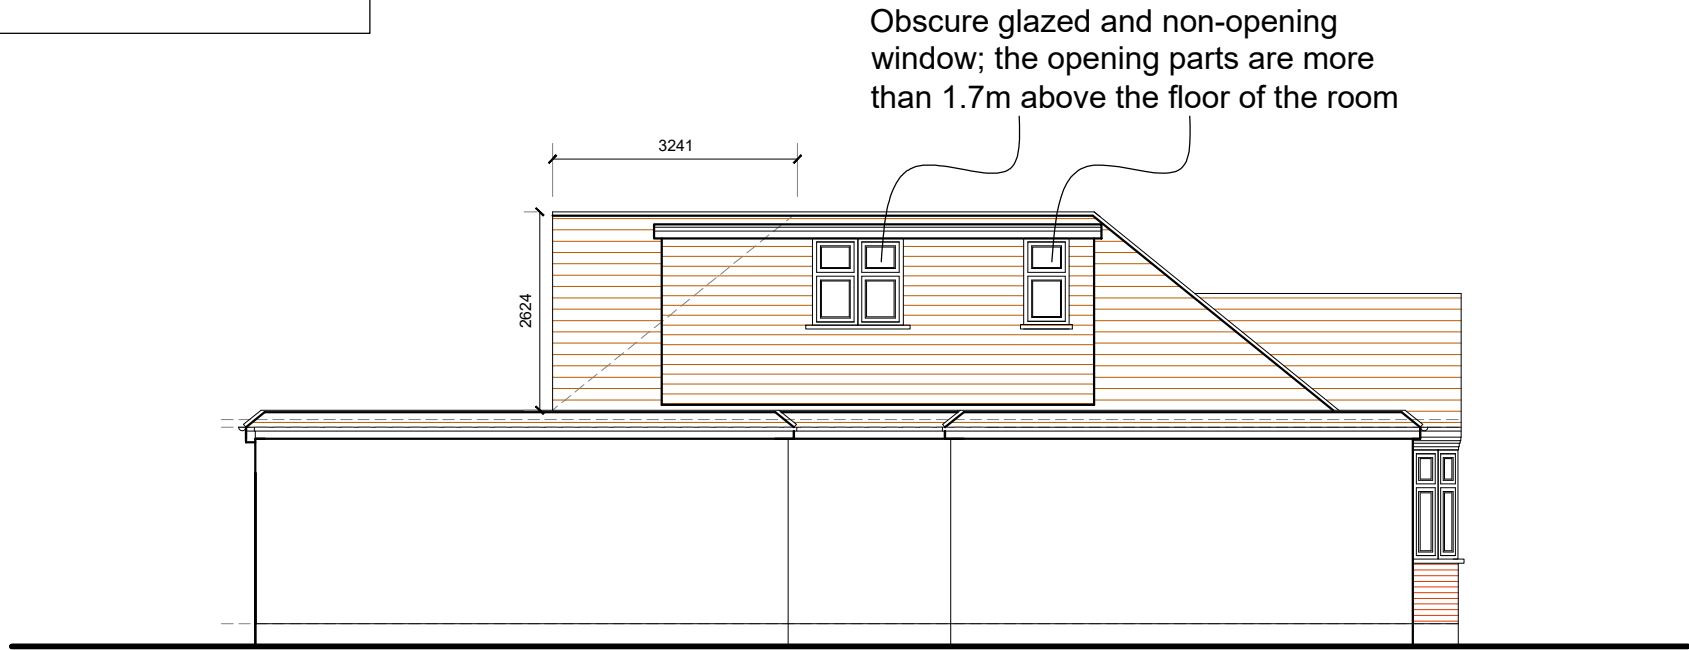

West Elevation

PROPOSED ELEVATIONS

20 Elgar Close, Ickenham, Uxbridge,
UB10 8HN

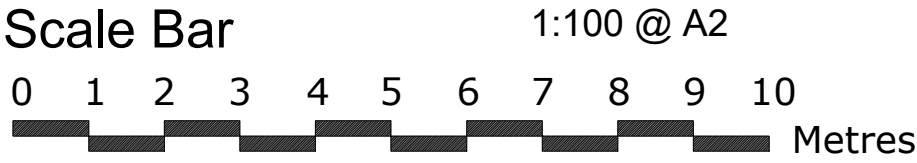

THE GILLETT MACLEOD PARTNERSHIP
Chartered Architects & Town Planning Consultants
1 High Road Old Eastcote Pinner Middlesex HA5 2EW tel. 0208 868 1333

Drg. No. 23/3591/07
Scale 1:100
Date 27/09/23
Drawn by KH

REVISION	
A	
Ⓒ	drawer