


NOTES


- Dimensions are not to be scaled from this drawing by contractors. The contractor is requested to check all dimensions before the work started.
- Report any discrepancies to the client or architect before undertaking the work described in the drawings.
- Dimensions are approximate site dimensions and are to be verified by the contractor on site before any fabrication/site works i.e foundations etc occur.
- Contractor is responsible for all temporary propping to existing structure.



01 - FRONT ELEVATION

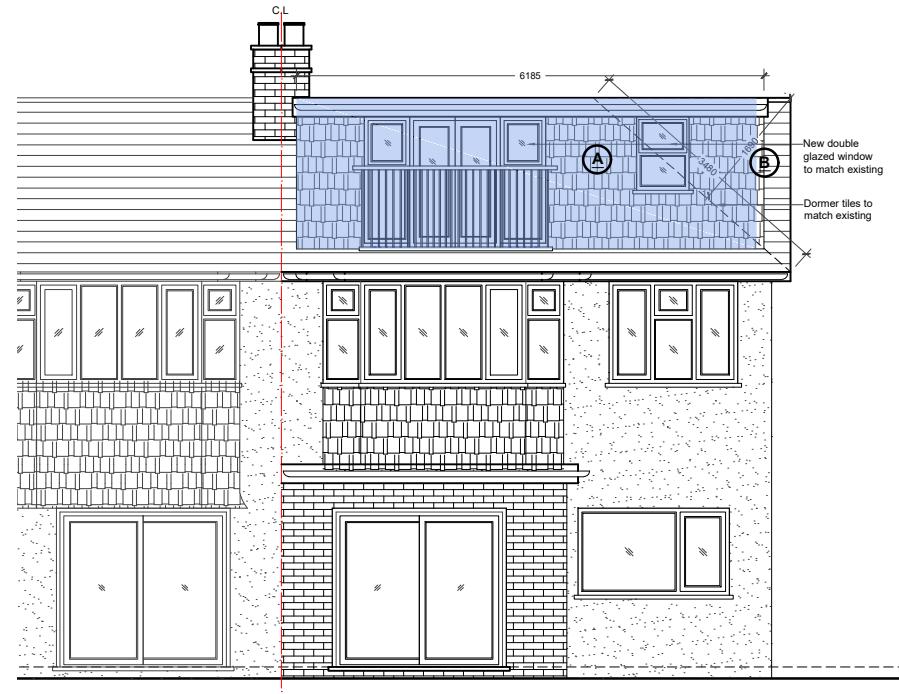

02 - REAR ELEVATION

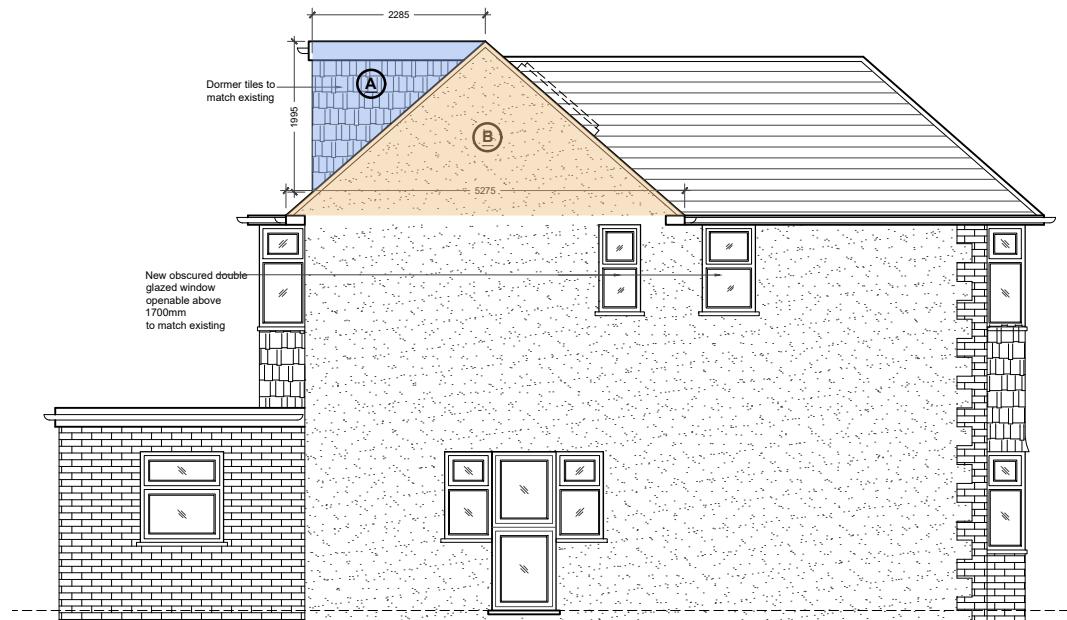

03 - SIDE ELEVATION

**LOFT VOLUME:**

Loft Dormer Volume (A) -  $(6.185 \times 2.285 \times 1.995)/2 = 14.09 \text{ cub.m}$   
 Hip To Gable (B) -  $(5.275 \times 3.480 \times 1.690)/6 = 05.17 \text{ cub.m}$

**Total Volume - Volume A + Volume B = 14.09 cub.m + 05.17 cub.m = 19.26 cub.m < 50 cub.m**

0 1 2m 3 4 5m  
Scale

REVISIONS			
NO.	DESCRIPTION	DATE	BY

**LAWFULNESS  
CERTIFICATE**

DE ARCHITECTURAL CONSULT.LTD

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Title: PROPOSED ELEVATIONS

Scale: 1:100@A3	Drawn: MZ	Approved:	Date: MAY-25
Job No.: DAC-326/25	Drawing No.: PD-22HR-04	Rev.:	-