


Existing Ground Floor Plan
Scale 1:100



Existing First Floor Plan
Scale 1:100

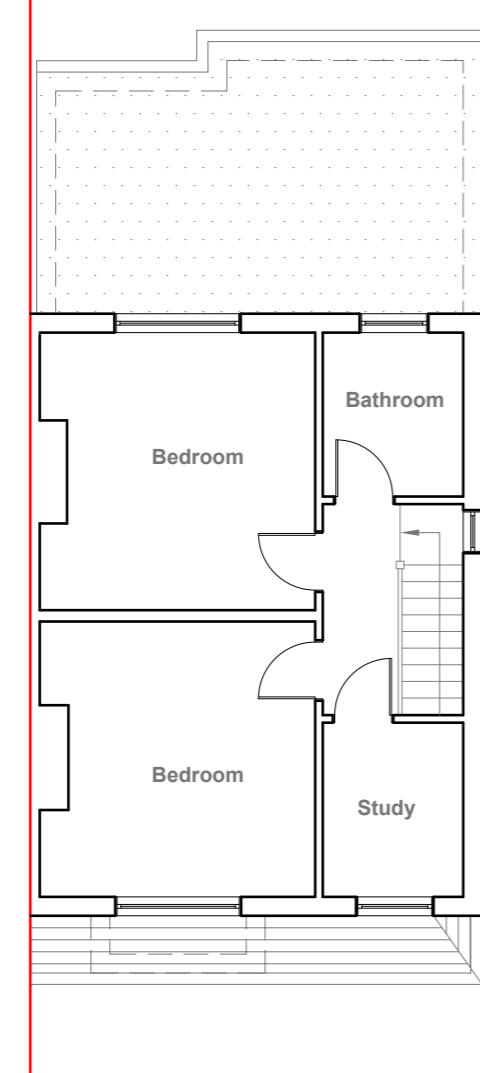


Existing Front Elevation
Scale 1:100



Existing Side Elevation
Scale 1:100



Existing Rear Elevation
Scale 1:100

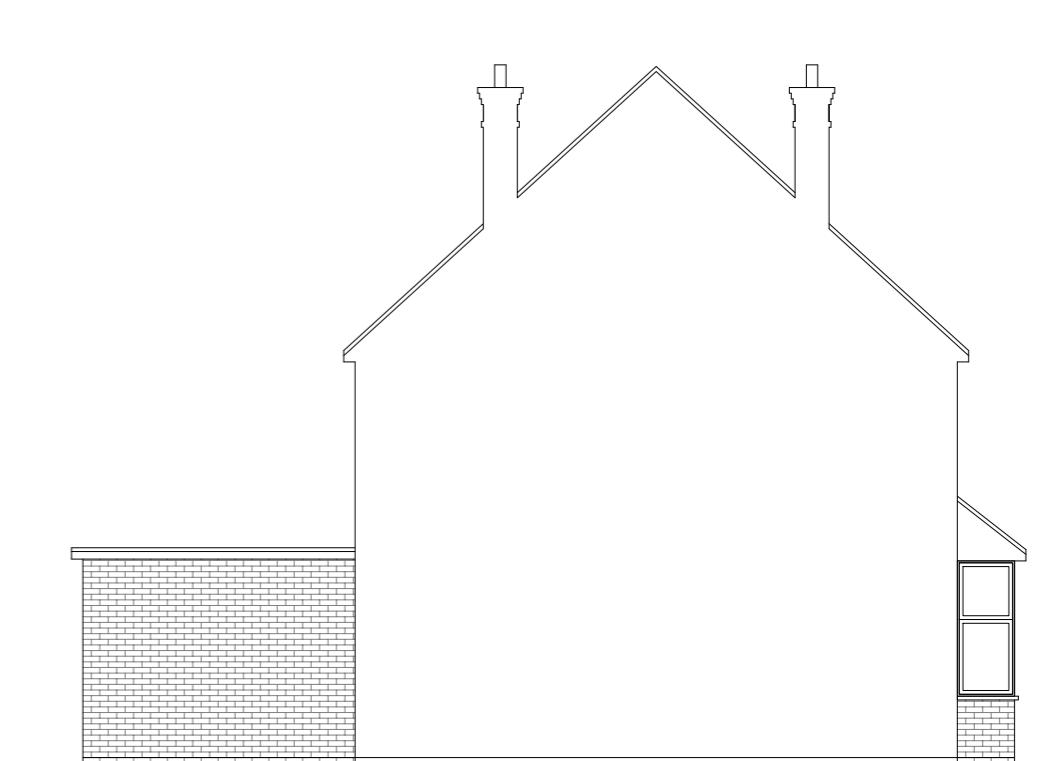

Existing Side Elevation
Scale 1:100

10 Meter
5
2
1
0
1:100

GENERAL NOTES:
1. ALL DIMENSIONS ARE IN MILLIMETER.
2. VERIFY ALL DIMENSIONS AND CONDITIONS BEFORE BUILDING OR
STARTING CONSTRUCTION. NOTIFY THE DESIGNER IMMEDIATELY OF ANY
DISCREPANCY OR VARIATION.
3. ALL WORK TO COMPLY WITH CURRENT BUILDING REGULATIONS
AND CODES OF PRACTICE

Title:

Existing Floor Plans & Elevations



Site Address
19 Myrtle Avenue,
Ruislip.
HA4 8SA

Scale: 1:100 @A3
Date: 02/02/2024
Drawing No.:
2024/015 -01
Drawn By:
RO

Revision Date:

e:mail -
faluckpatel@yahoo.com
(M) +44 (0) 7871 466 254

**Faluck
Patel**

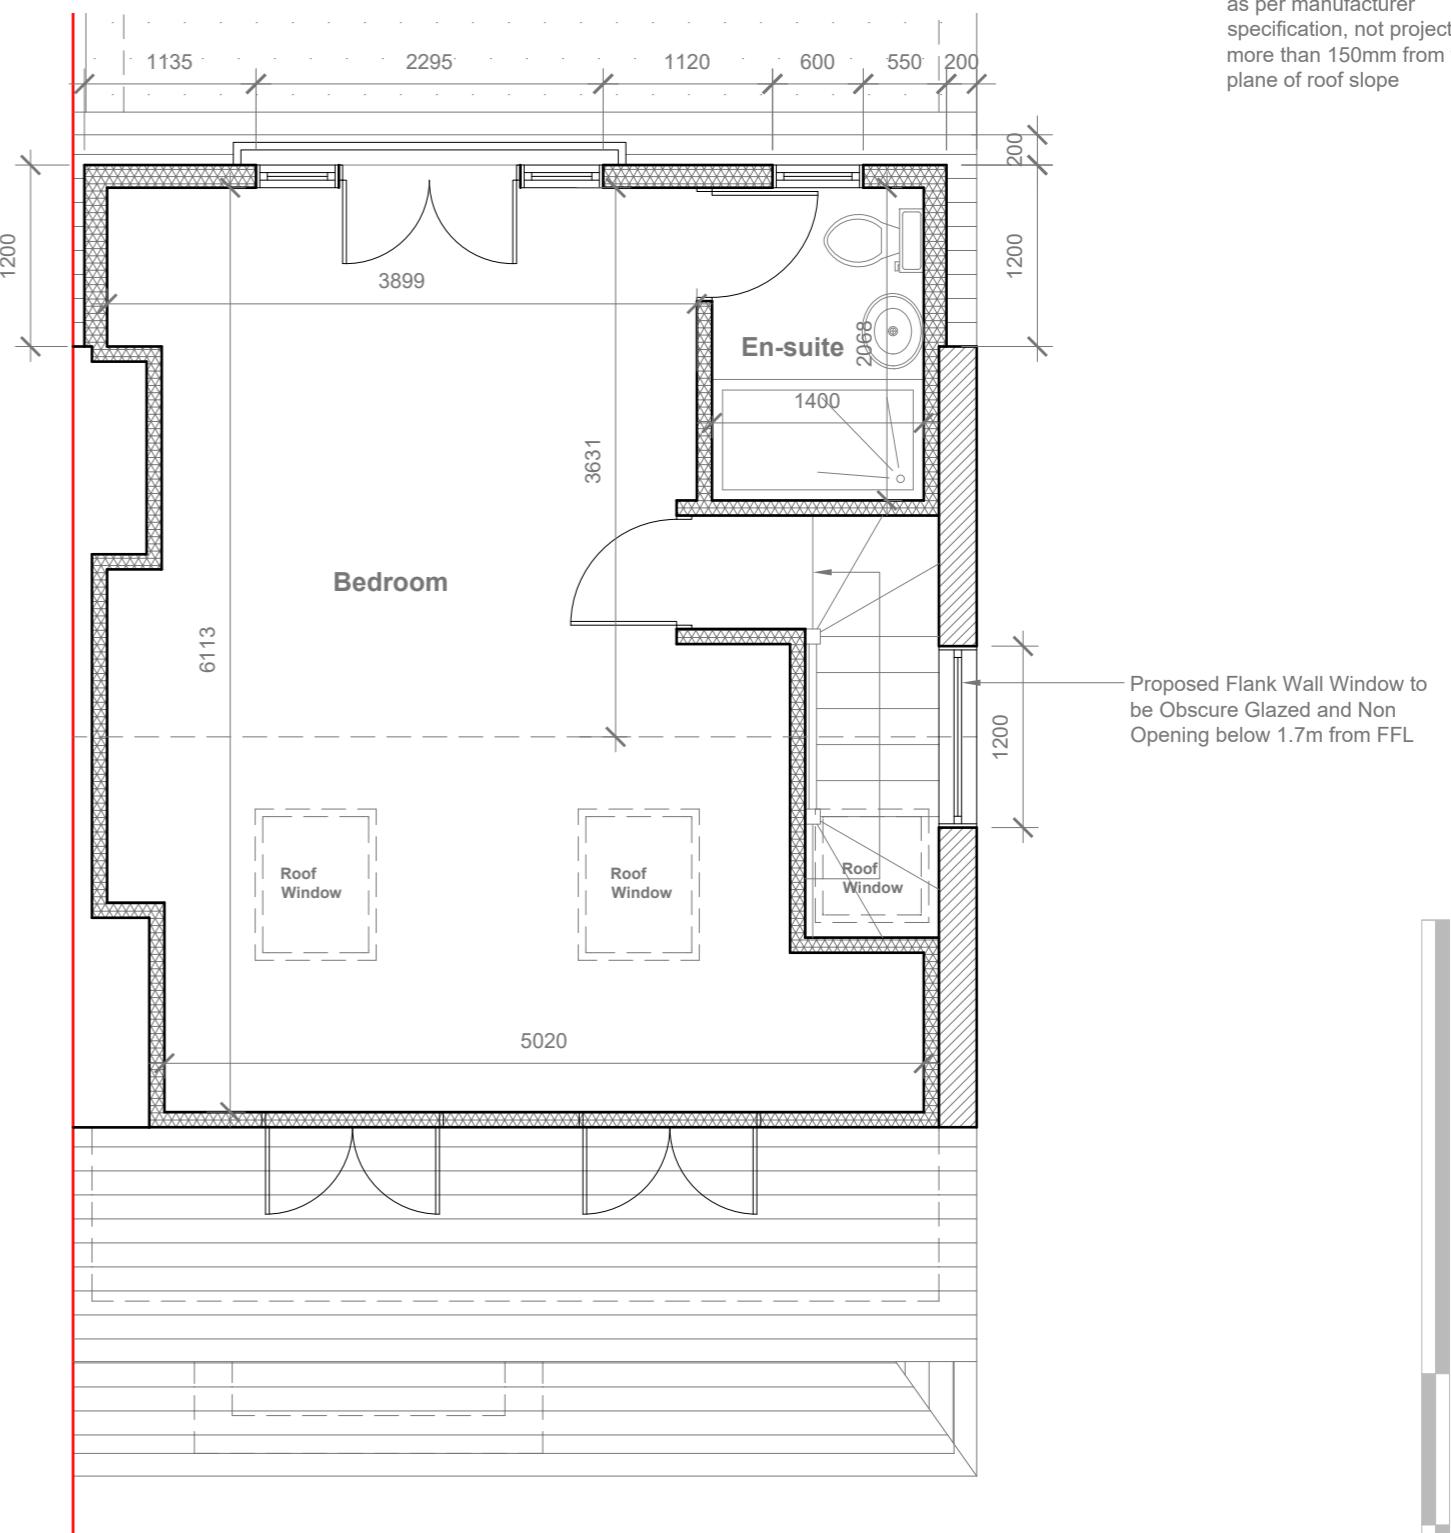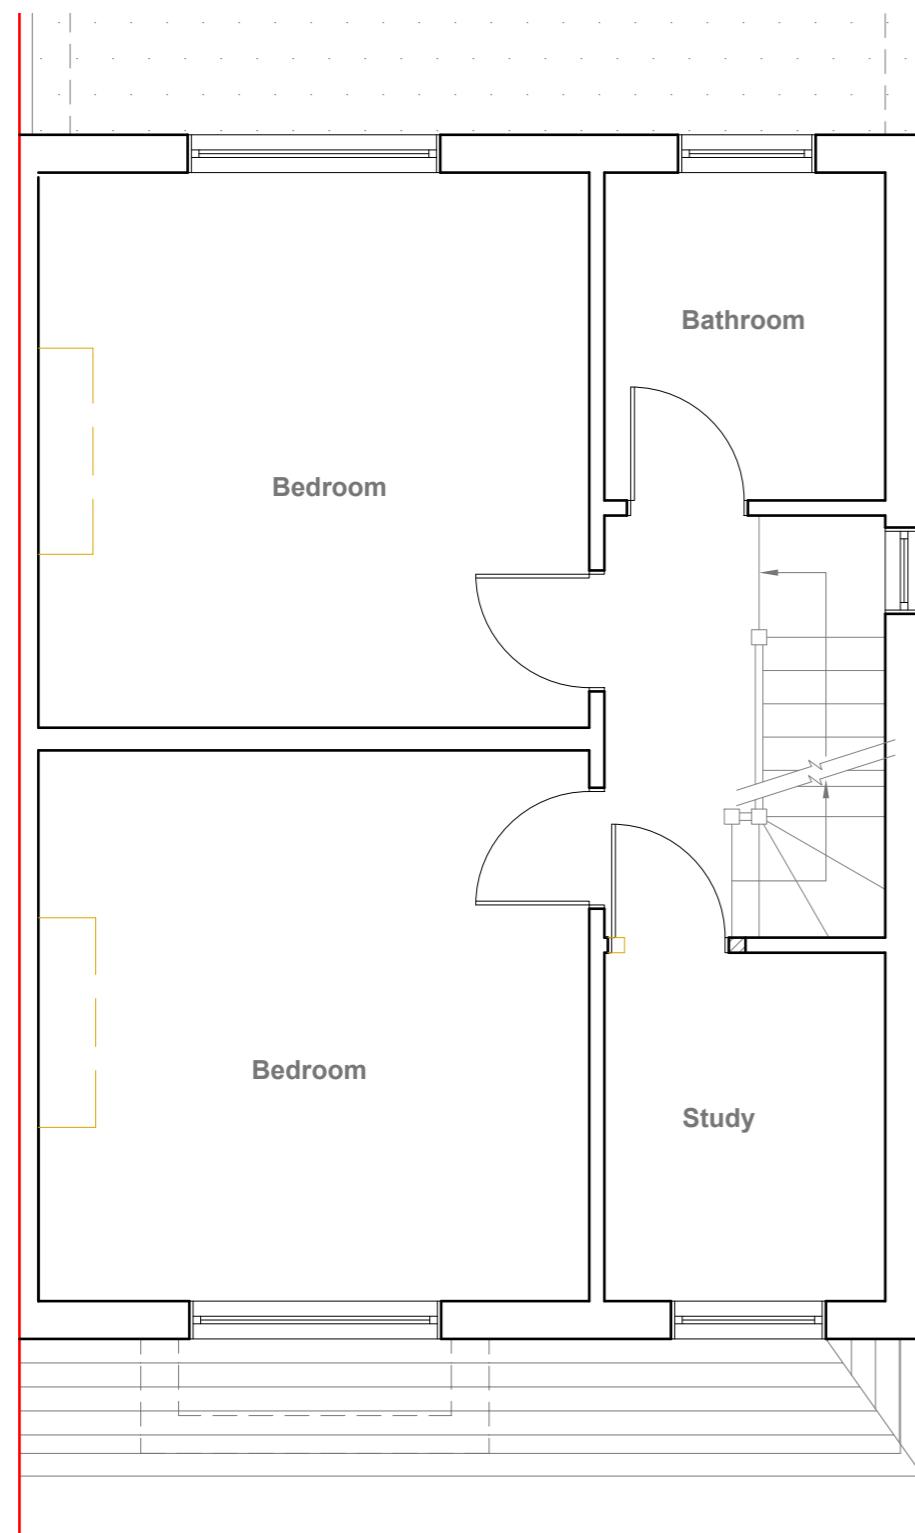

GENERAL NOTES:
1. ALL DIMENSIONS ARE IN MILLIMETER.
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3. ALL WORK TO COMPLY WITH CURRENT BUILDING REGULATIONS AND CODES OF PRACTICE

Title:

Proposed First Floor & Loft Plans

Site Address
19 Myrtle Avenue,
Ruislip.
HA4 8SA

Scale: 1:50 @A3
Date: 02/02/2024
Drawing No.: 2024/015 -02
Drawn By:
RO


Revision Date:
e:mail - faluckpatel@yahoo.com
(M) +44 (0) 7871 466 254

Faluck Patel



Proposed Front Elevation

Scale 1:100

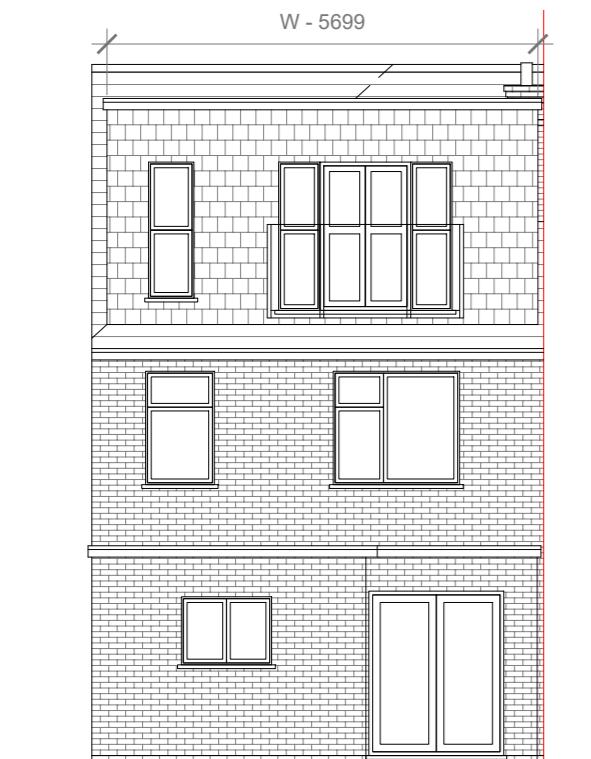


Proposed Rear Elevation

Scale 1:100

Proposed Side Elevation

Scale 1:100

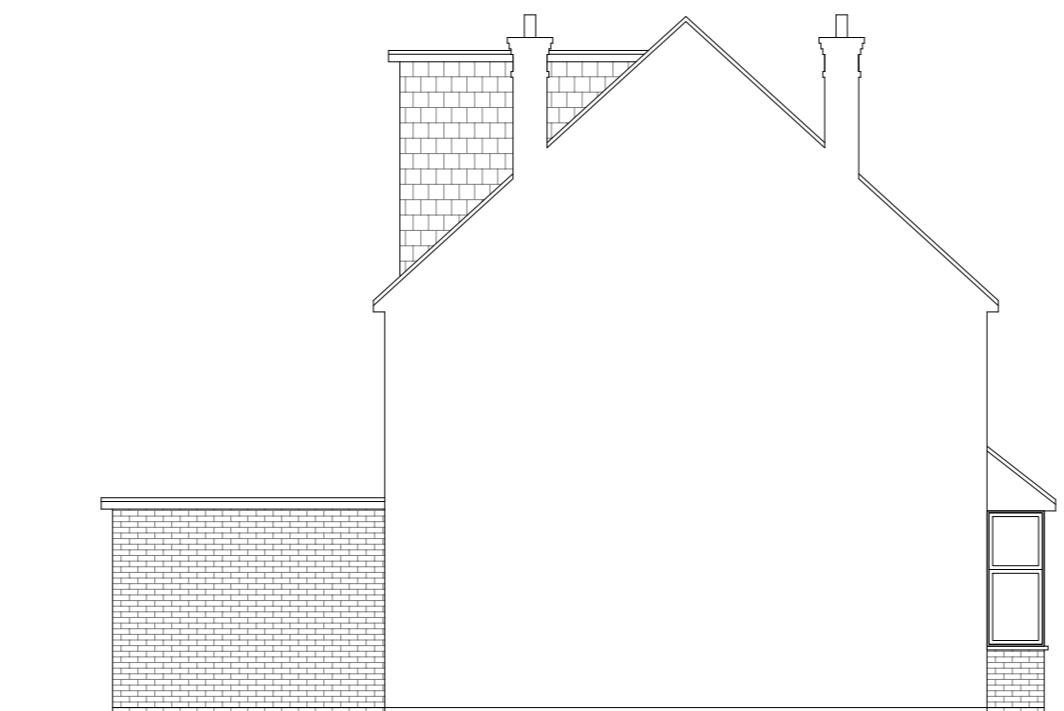

Proposed Side Elevation

Scale 1:100

		Proposed External Finish Materials to Match Existing External Finish Materials
REAR DORMER VOLUME =		$W \times H \times L / 2$ 5.699 X 2.990 X 3.287 / 2 55.71 / 2 27.85 CU.MT.
V1 =		
HIP TO GABLE ROOF VOLUME =		$W1 \times H1 \times L1 / 6$ 8.263 X 3.908 X 3.982 / 6 128.58 / 6 21.43 CU.MT.
V2 =		
TOTAL ROOF VOLUME =		$V1 + V2$ 27.85 + 21.43 49.28 CU.MT. < 50.00 CU.MT

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Title:

Proposed Elevations

Site Address	Scale: 1:100 @A3	Revision Date:
19 Myrtle Avenue, Ruislip. HA4 8SA	Date: 02/02/2024	
	Drawing No.: 2024/015 -03	
	Drawn By:	
	RO	e:mail - faluckpatel@yahoo.com (M) +44 (0) 7871 466 254

10 Meter
5
5
2
1
0
1:100