



Scale 1:100

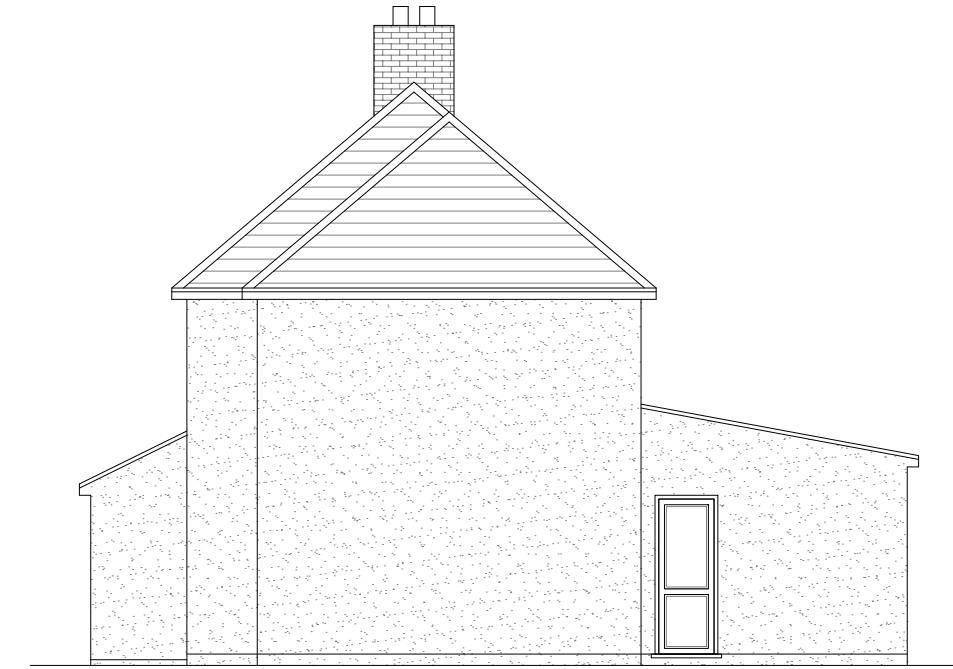

Scale 1:100




Scale 1:100

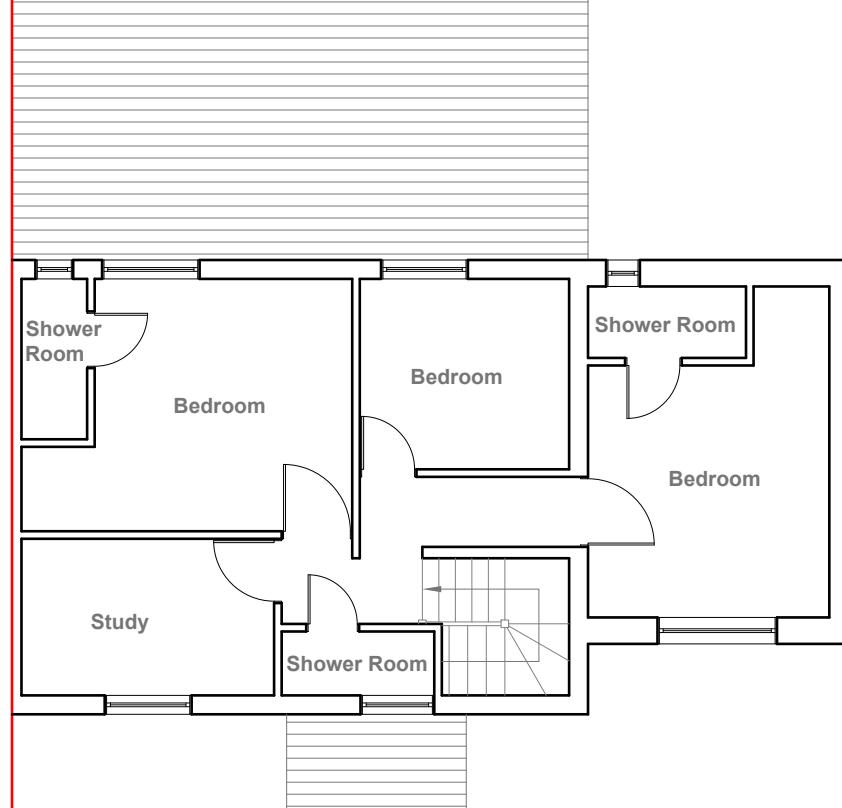

Scale 1:100



Scale 1:100

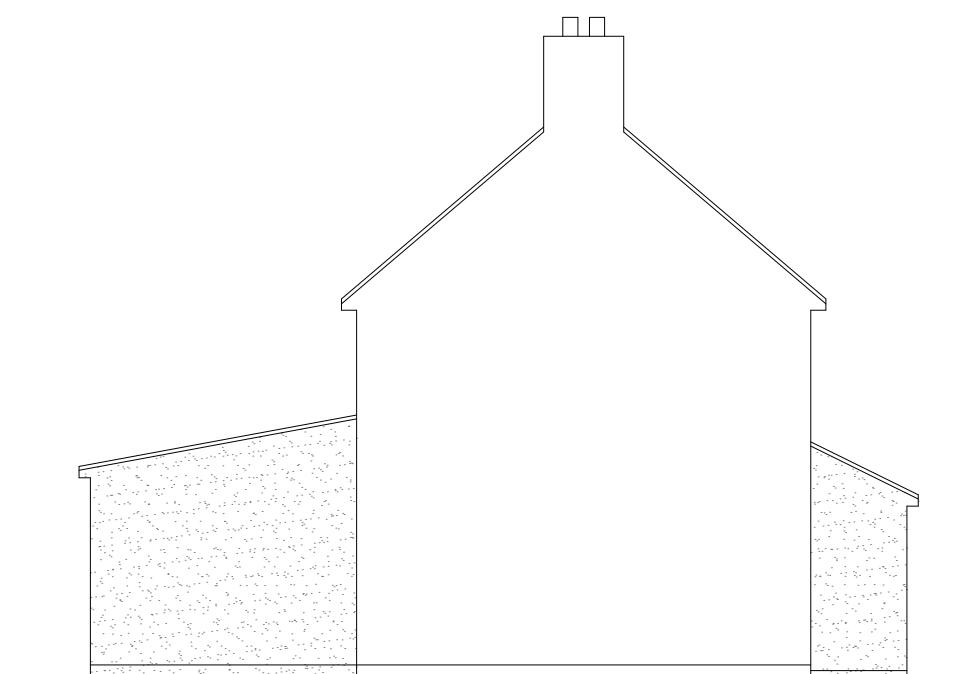

Scale 1:100

GENERAL NOTES:
 1. ALL DIMENSIONS ARE IN MILLIMETER.
 2. VERIFY ALL DIMENSIONS AND CONDITIONS BEFORE BUILDING OR
 STARTING CONSTRUCTION. NOTIFY THE DESIGNER IMMEDIATELY OF ANY
 DISCREPANCY OR VARIATION.
 3. ALL WORK TO COMPLY WITH CURRENT BUILDING REGULATIONS
 AND CODES OF PRACTICE


Title:

Existing Plans & Elevations

Site Address
88 Central Avenue,
Hayes,
UB3 2BZ

Scale: 1:100 @A3
Date: 18/07/2024
Drawing No.:
2024/000-01
Drawn By:
JG

Revision Date:
e:mail -
faluckpatel@yahoo.com
(M) +44 (0) 7871 466 254

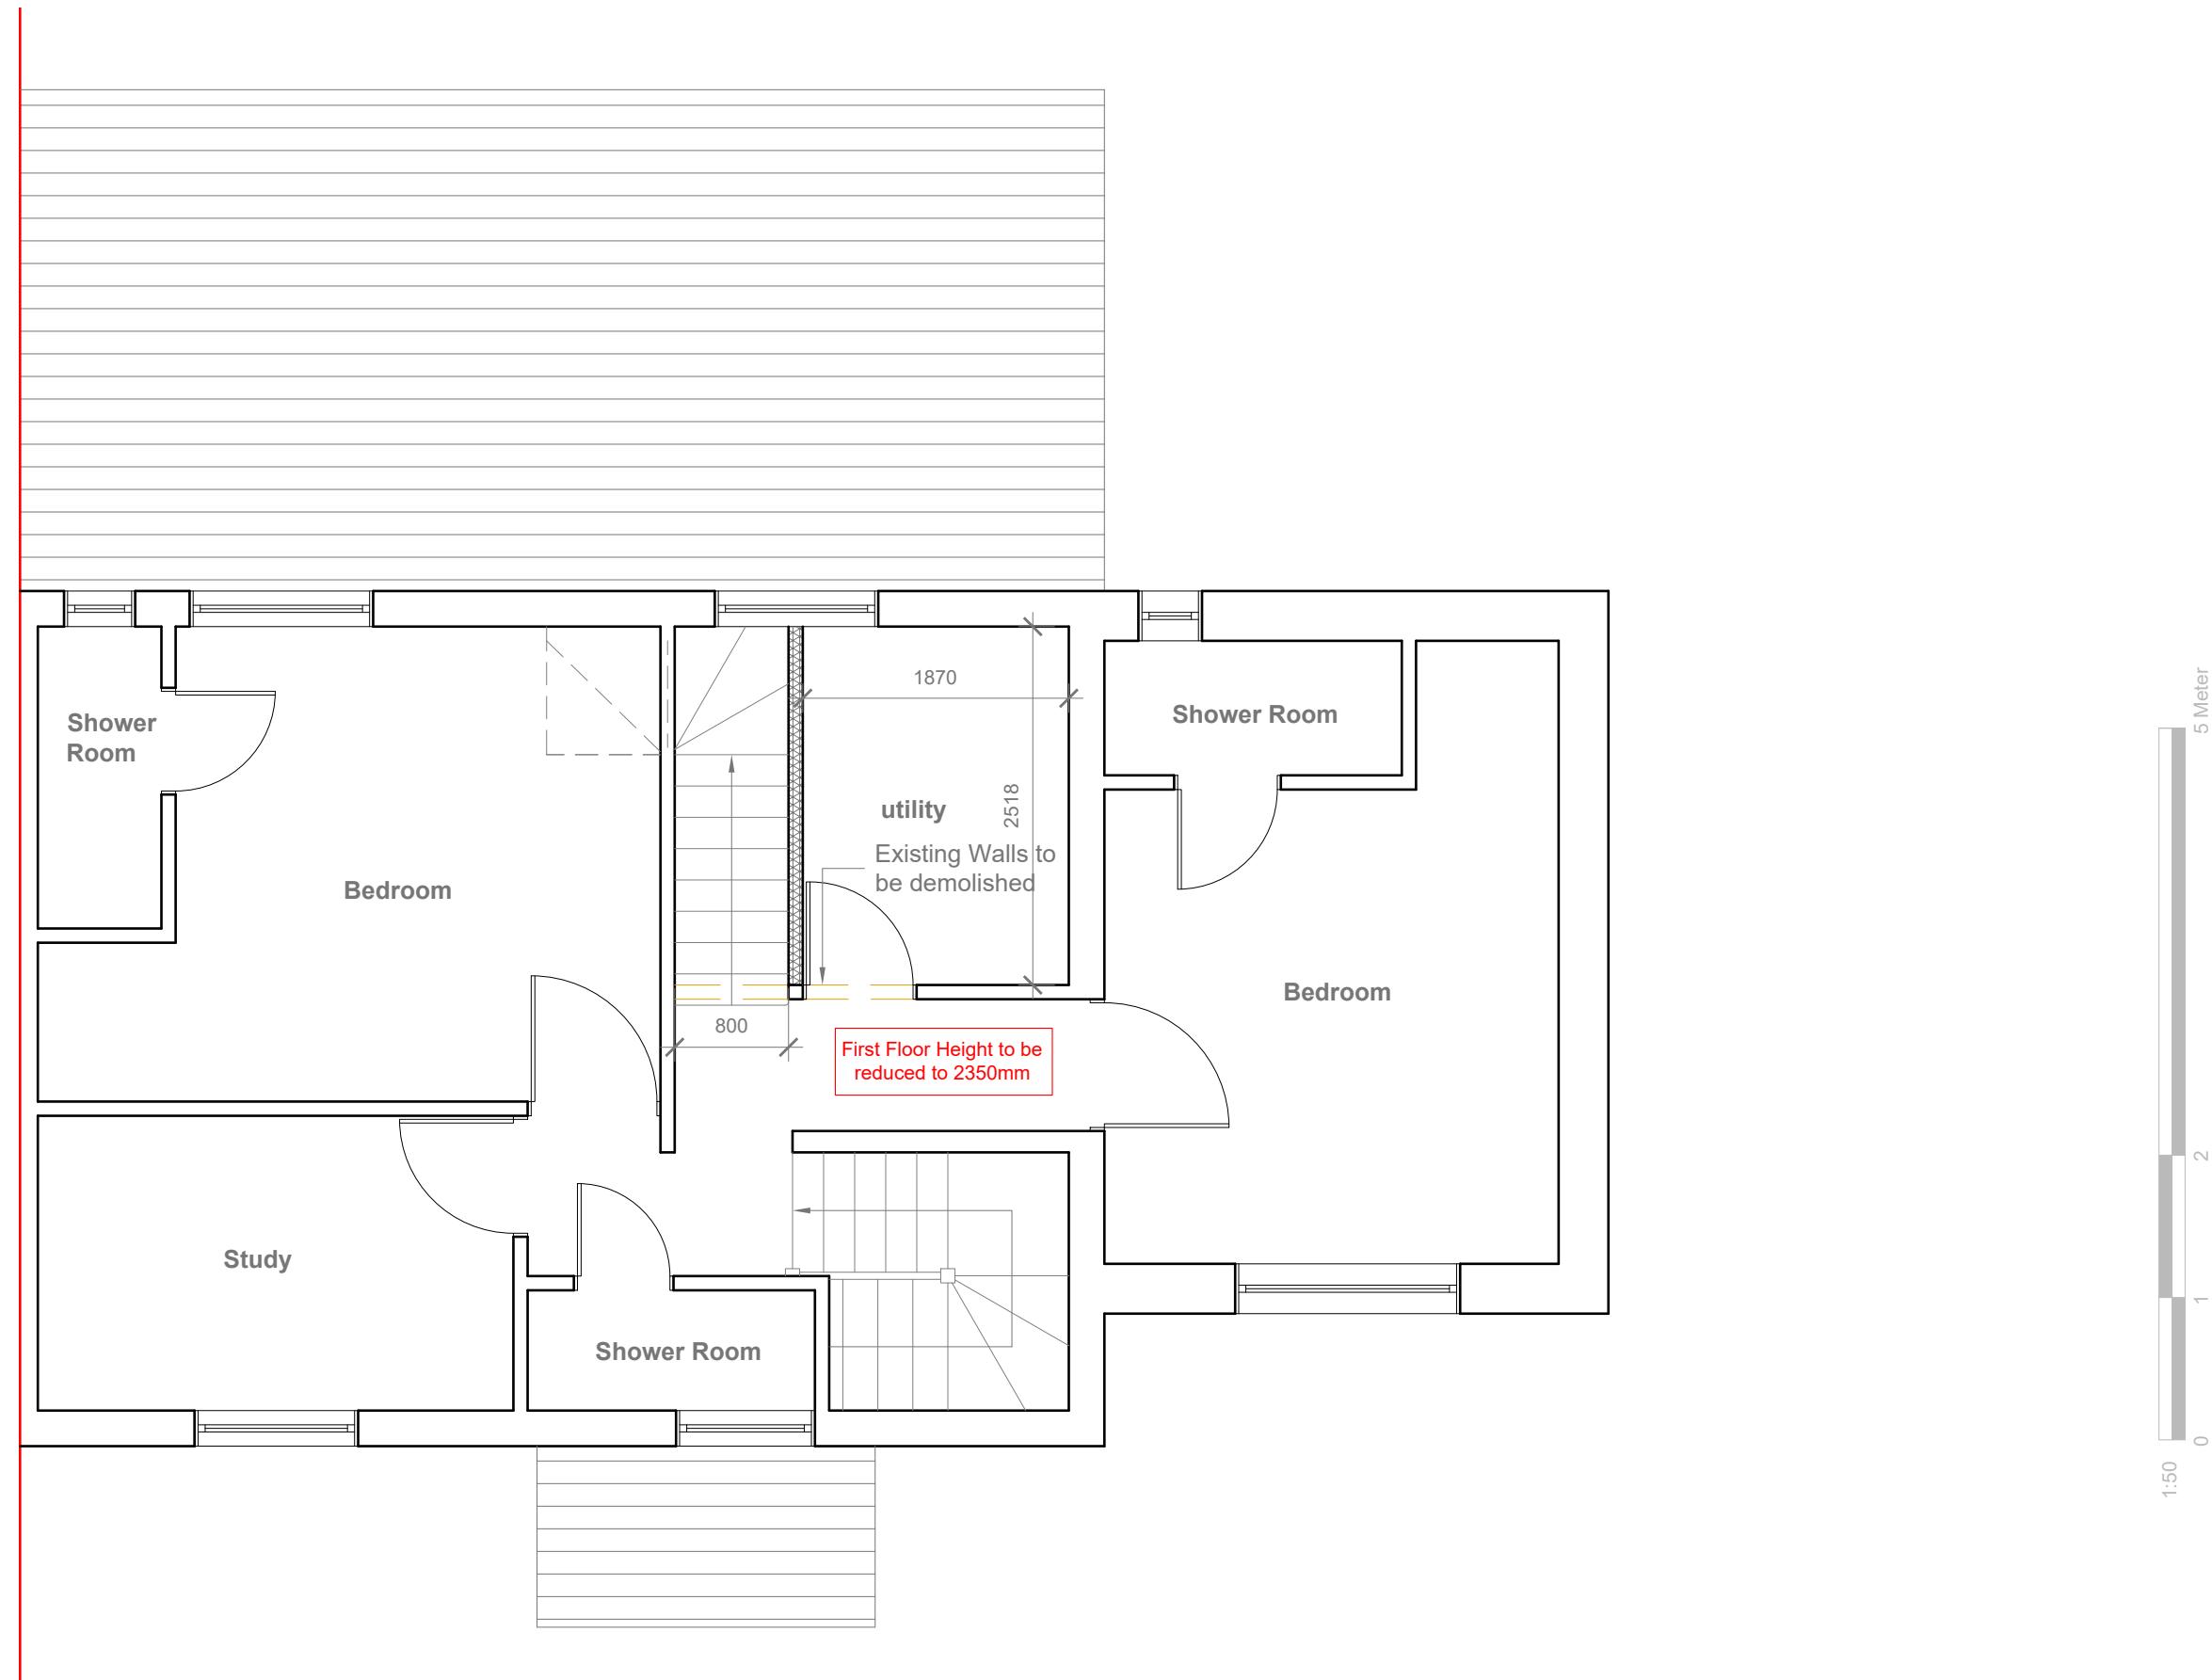

Proposed First Floor Plan

Scale 1:50

GENERAL NOTES:

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3. ALL WORK TO COMPLY WITH CURRENT BUILDING REGULATIONS AND CODES OF PRACTICE

Title:

Proposed First Floor Plan

Site Address

88 Central Avenue,
Hayes,
UB3 2BZ

Scale: 1:50 @A3

Date: 18/07/2024

Drawing No.:


2024/000 -02

Drawn By:

JG

Revision Date:

e:mail -
faluckpatel@yahoo.com
(M) +44 (0) 7871 466 254

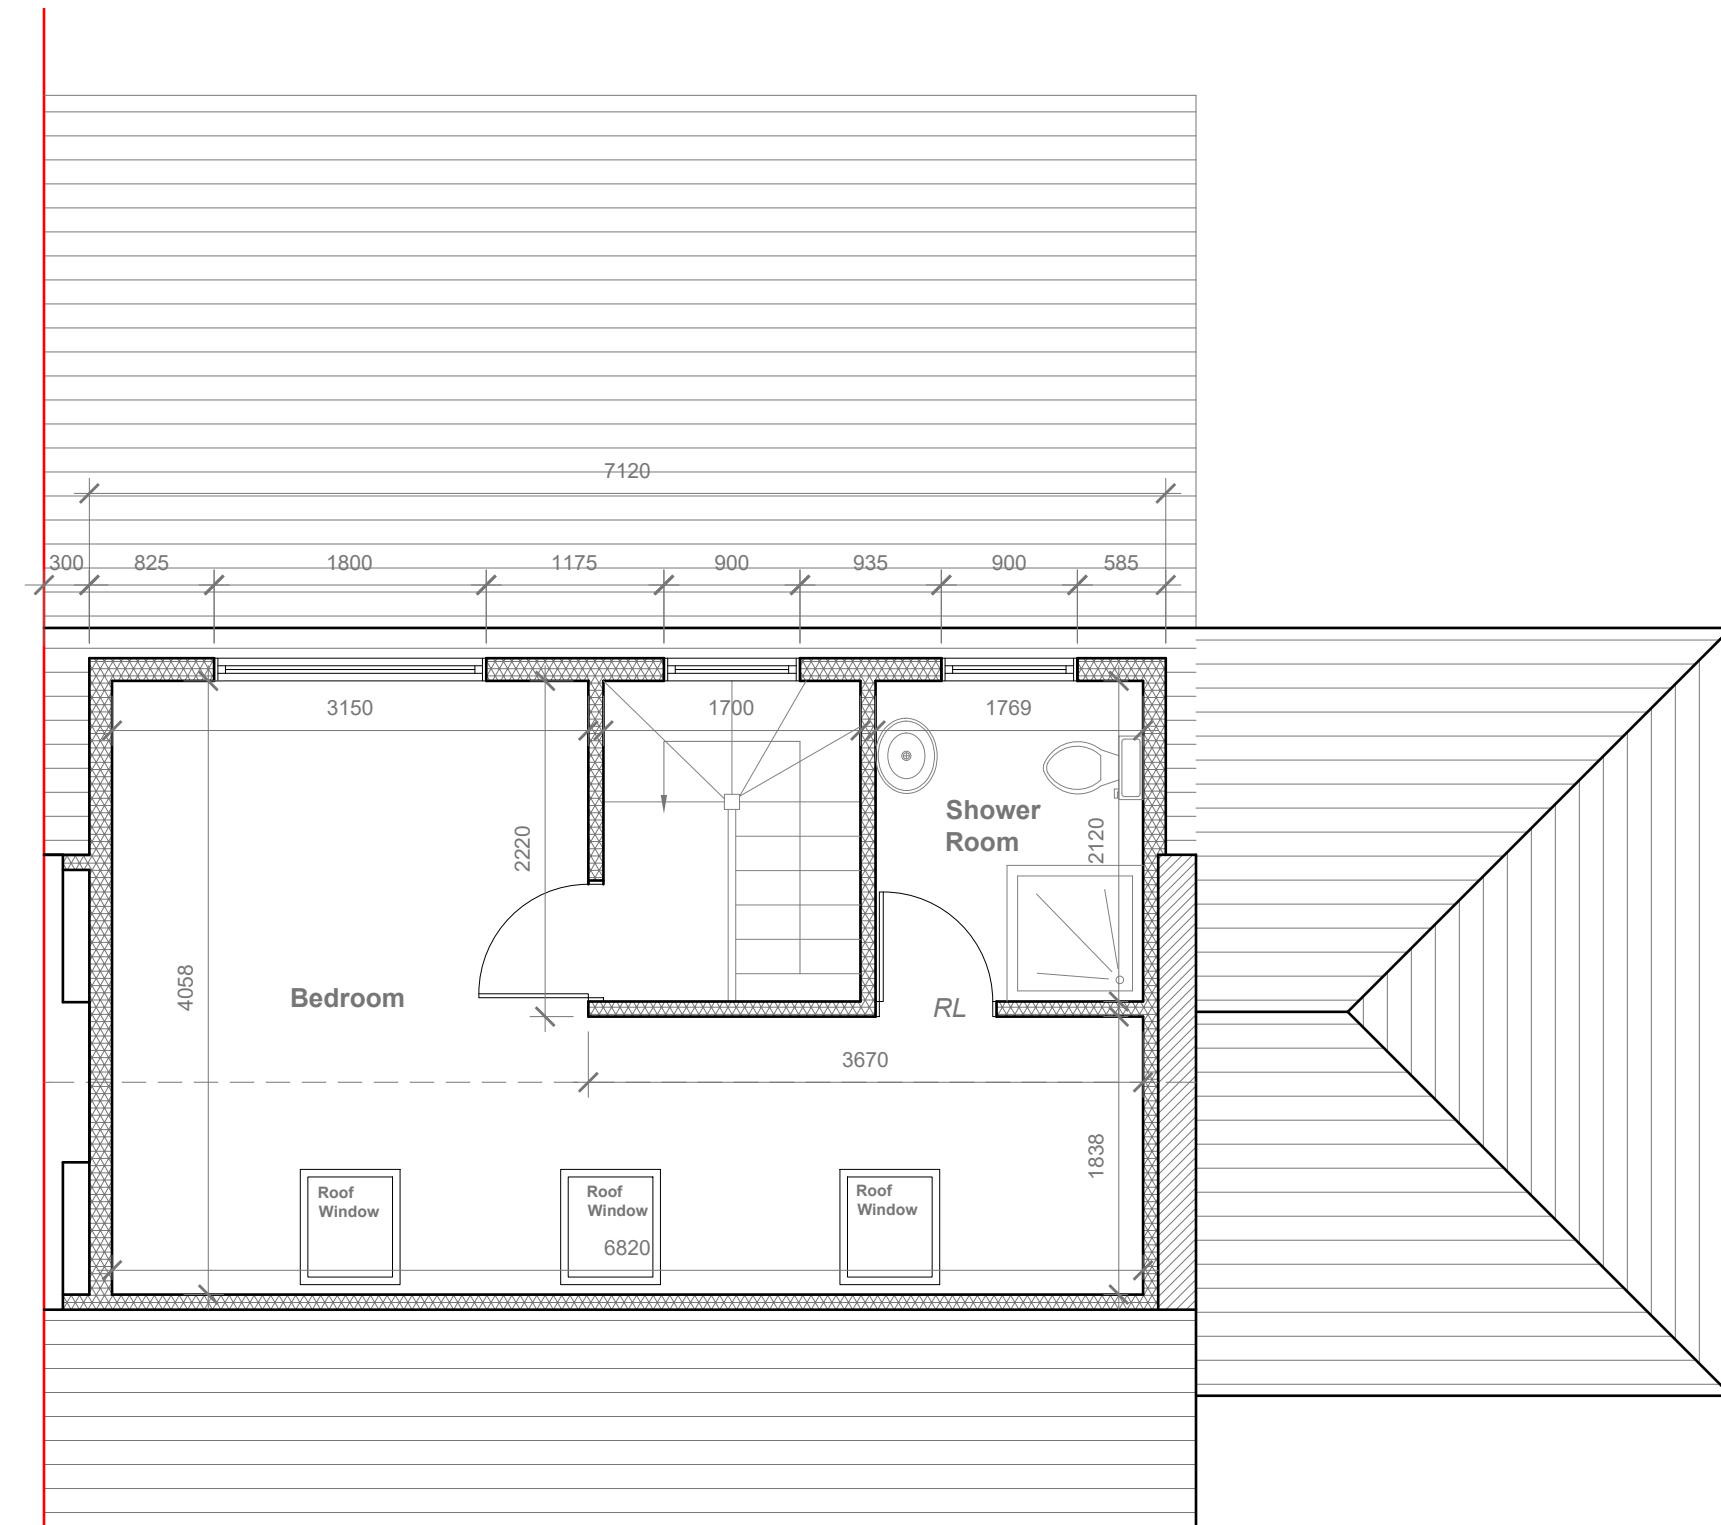

Proposed Loft Floor Plan

Scale 1:50

GENERAL NOTES:

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Title:

Proposed Loft Floor Plan

Site Address
88 Central Avenue,
Hayes,
UB3 2BZ

Scale: 1:50 @A3
Date: 18/07/2024
Drawing No.:
2024/000 -03
Drawn By:
JG

Revision Date:
e:mail -
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**Faluck
Patel**

Velux Window to be installed as per manufacturer specification, not projected more than 150mm from the plane of roof slope

REAR DORMER VOLUME

$$\begin{aligned} W \times H \times L / 2 \\ 7.120 \times 2.233 \times 2.628 / 2 \\ 41.78 / 2 \\ V1 = 20.89 \text{ CU.MT.} \end{aligned}$$



Proposed External Finish Materials to Match Existing External Finish Materials

HIP TO GABLE ROOF VOLUME

$$\begin{aligned} W1 \times H1 \times L1 / 6 \\ 6.408 \times 2.557 \times 3.004 / 6 \\ 49.22 / 6 \\ V2 = 8.20 \text{ CU.MT.} \end{aligned}$$

SIDE ROOF VOLUME

$$\begin{aligned} W2 \times H2 \times L2 / 3 \\ 5.477 \times 2.477 \times 2.738 / 3 \\ 37.14 / 3 \\ V3 = 12.38 \text{ CU.MT.} \\ W2 \times H2 \times L3 / 2 \\ 5.477 \times 2.477 \times 1.004 / 2 \\ 13.62 / 2 \\ V4 = 6.81 \text{ CU.MT.} \end{aligned}$$

TOTAL ROOF VOLUME


$$\begin{aligned} V1 + V2 + V3 + V4 \\ = 20.89 + 8.20 + 12.38 + 6.81 \\ = 48.28 \text{ CU.MT.} < 50.00 \text{ CU.MT.} \end{aligned}$$

Proposed Front Elevation

Scale 1:100

Proposed Side Elevation

Scale 1:100

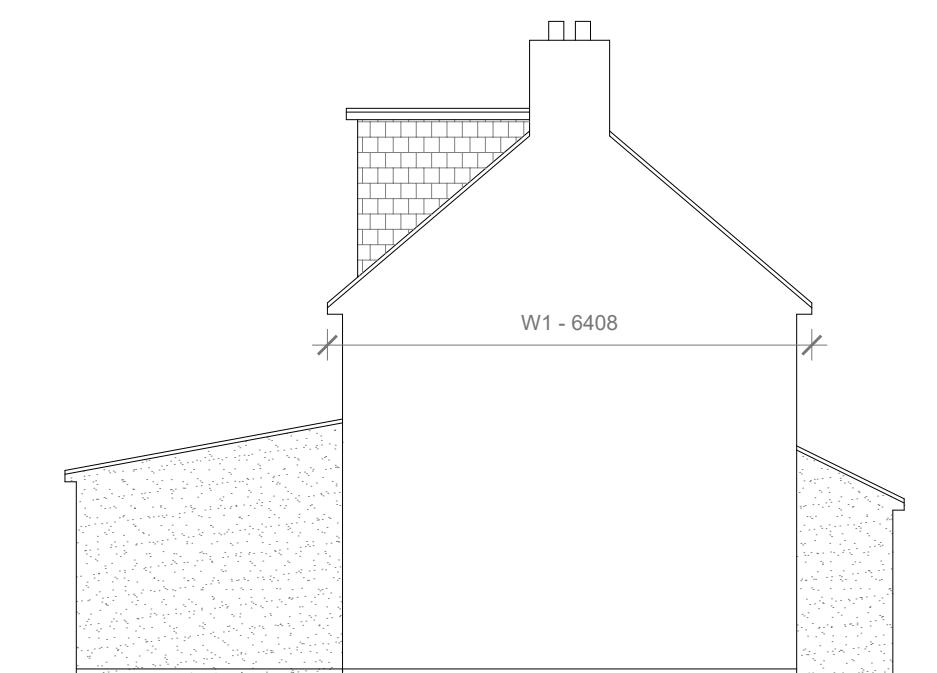

Proposed Rear Elevation

Scale 1:100

Proposed Side Elevation

Scale 1:100

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Title:

Proposed Elevations

Site Address	Scale: 1:100 @A3	Revision Date:
88 Central Avenue, Hayes, UB3 2BZ	Date: 18/07/2024 Drawing No.: 2024/000 -04 Drawn By: JG	e:mail - faluckpatel@yahoo.com (M) +44 (0) 7871 466 254

