



Existing Ground Floor Plan
Scale 1:100

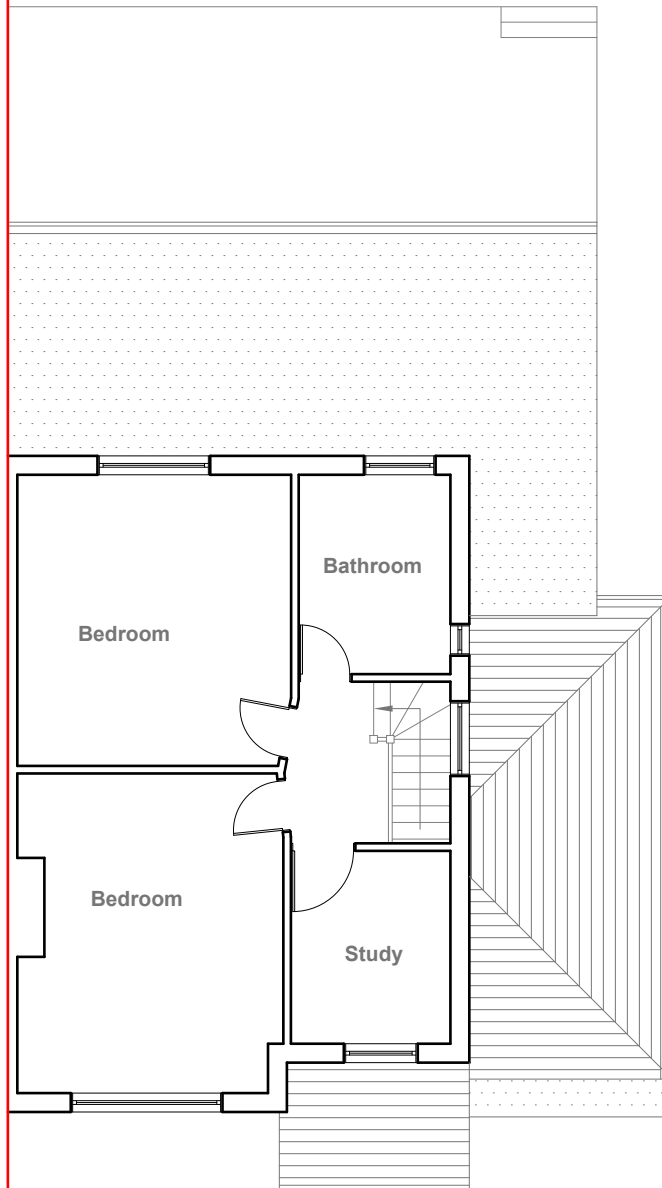

Existing First Floor Plan
Scale 1:100

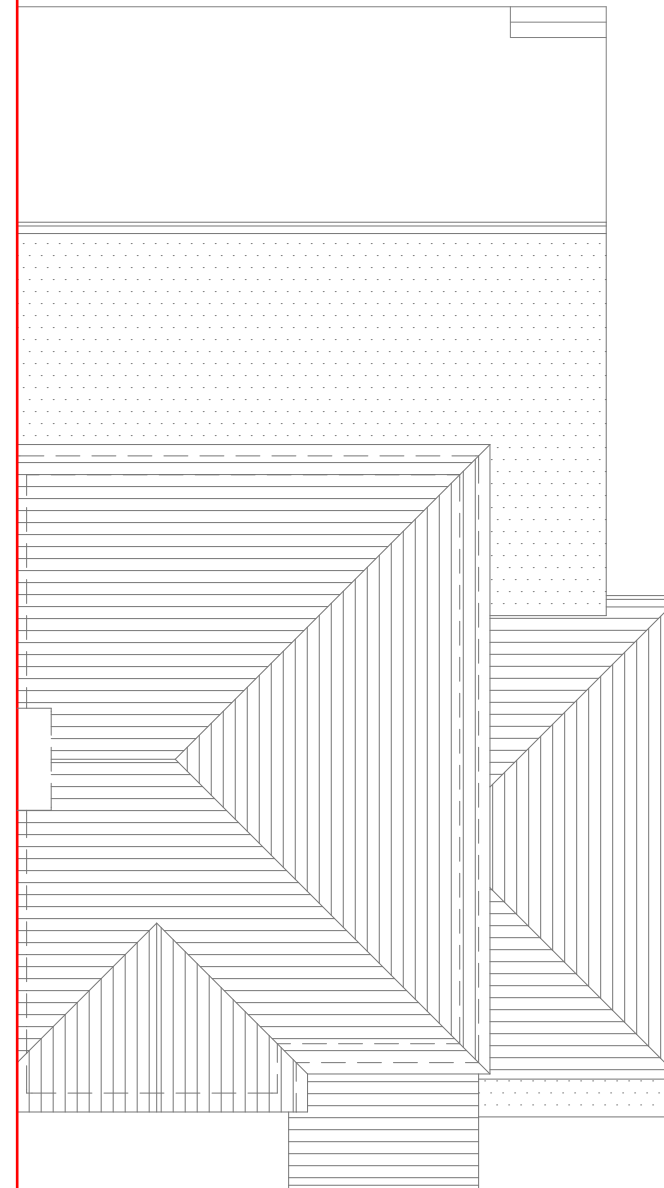

Existing Roof Plan
Scale 1:100



GENERAL NOTES:
1. ALL DIMENSIONS ARE IN MILLIMETER.
2. VERIFY ALL DIMENSIONS AND CONDITIONS BEFORE BUILDING OR STARTING CONSTRUCTION. NOTIFY THE DESIGNER IMMEDIATELY OF ANY DISCREPANCY OR VARIATION.
3. ALL WORK TO COMPLY WITH CURRENT BUILDING REGULATIONS AND CODES OF PRACTICE

Title:

Existing Floor Plans

Site Address
7 Vine Lane,
Uxbridge,
UB10 0AY

Scale: 1:100 @A3
Date: 18/04/2023
Drawing No.:
2023/058 -01
Drawn By:
RO

Revision Date:

e:mail -
faluckpatel@yahoo.com
(M) +44 (0) 7871 466 254

**Faluck
Patel**




Existing Front Elevation
Scale 1:100



Existing Side Elevation
Scale 1:100



Existing Rear Elevation
Scale 1:100

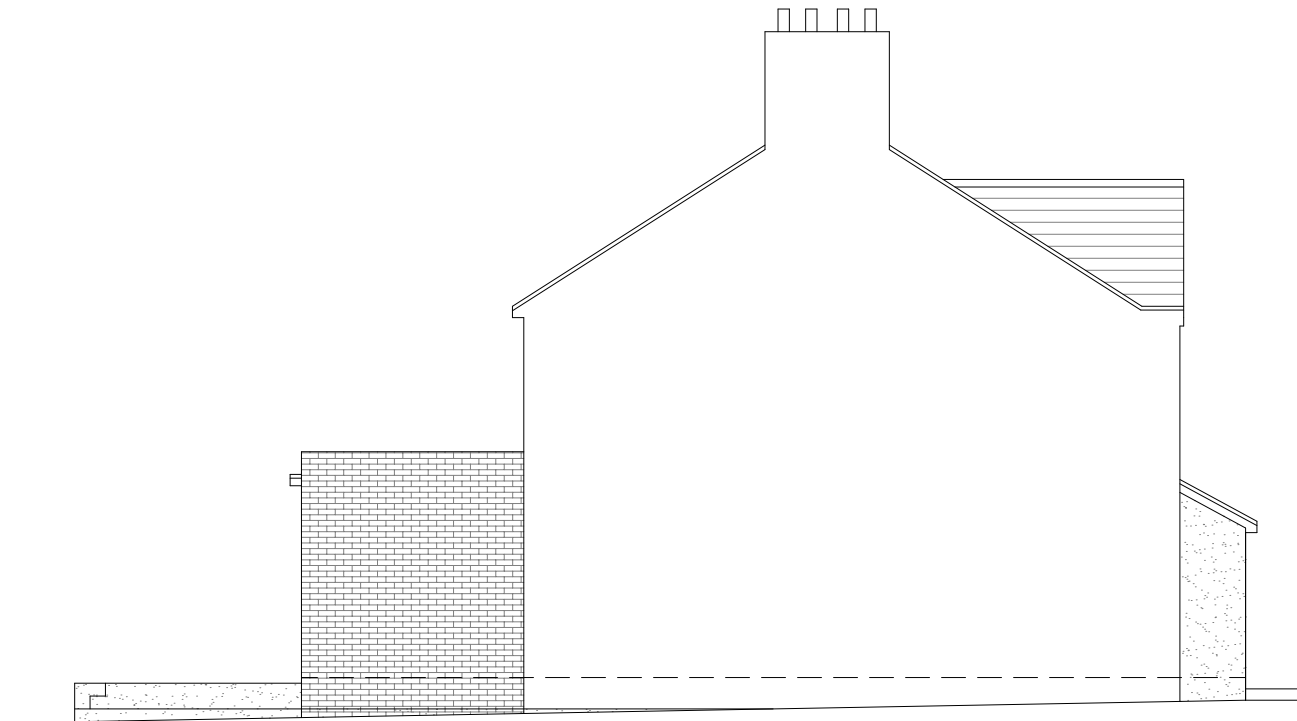

Existing Side Elevation
Scale 1:100



GENERAL NOTES:
1. ALL DIMENSIONS ARE IN MILLIMETER.
2. VERIFY ALL DIMENSIONS AND CONDITIONS BEFORE BUILDING OR STARTING CONSTRUCTION. NOTIFY THE DESIGNER IMMEDIATELY OF ANY DISCREPANCY OR VARIATION.
3. ALL WORK TO COMPLY WITH CURRENT BUILDING REGULATIONS AND CODES OF PRACTICE

Title:

Existing Elevations

Site Address

7 Vine Lane,
Uxbridge.
UB10 0AY

Scale: 1:100 @A3

Date: 18/04/2023

Drawing No.:

2023/058 -02

Drawn By:


RO

Revision Date:


e:mail -

faluckpatel@yahoo.com
(M) +44 (0) 7871 466 254

**Faluck
Patel**

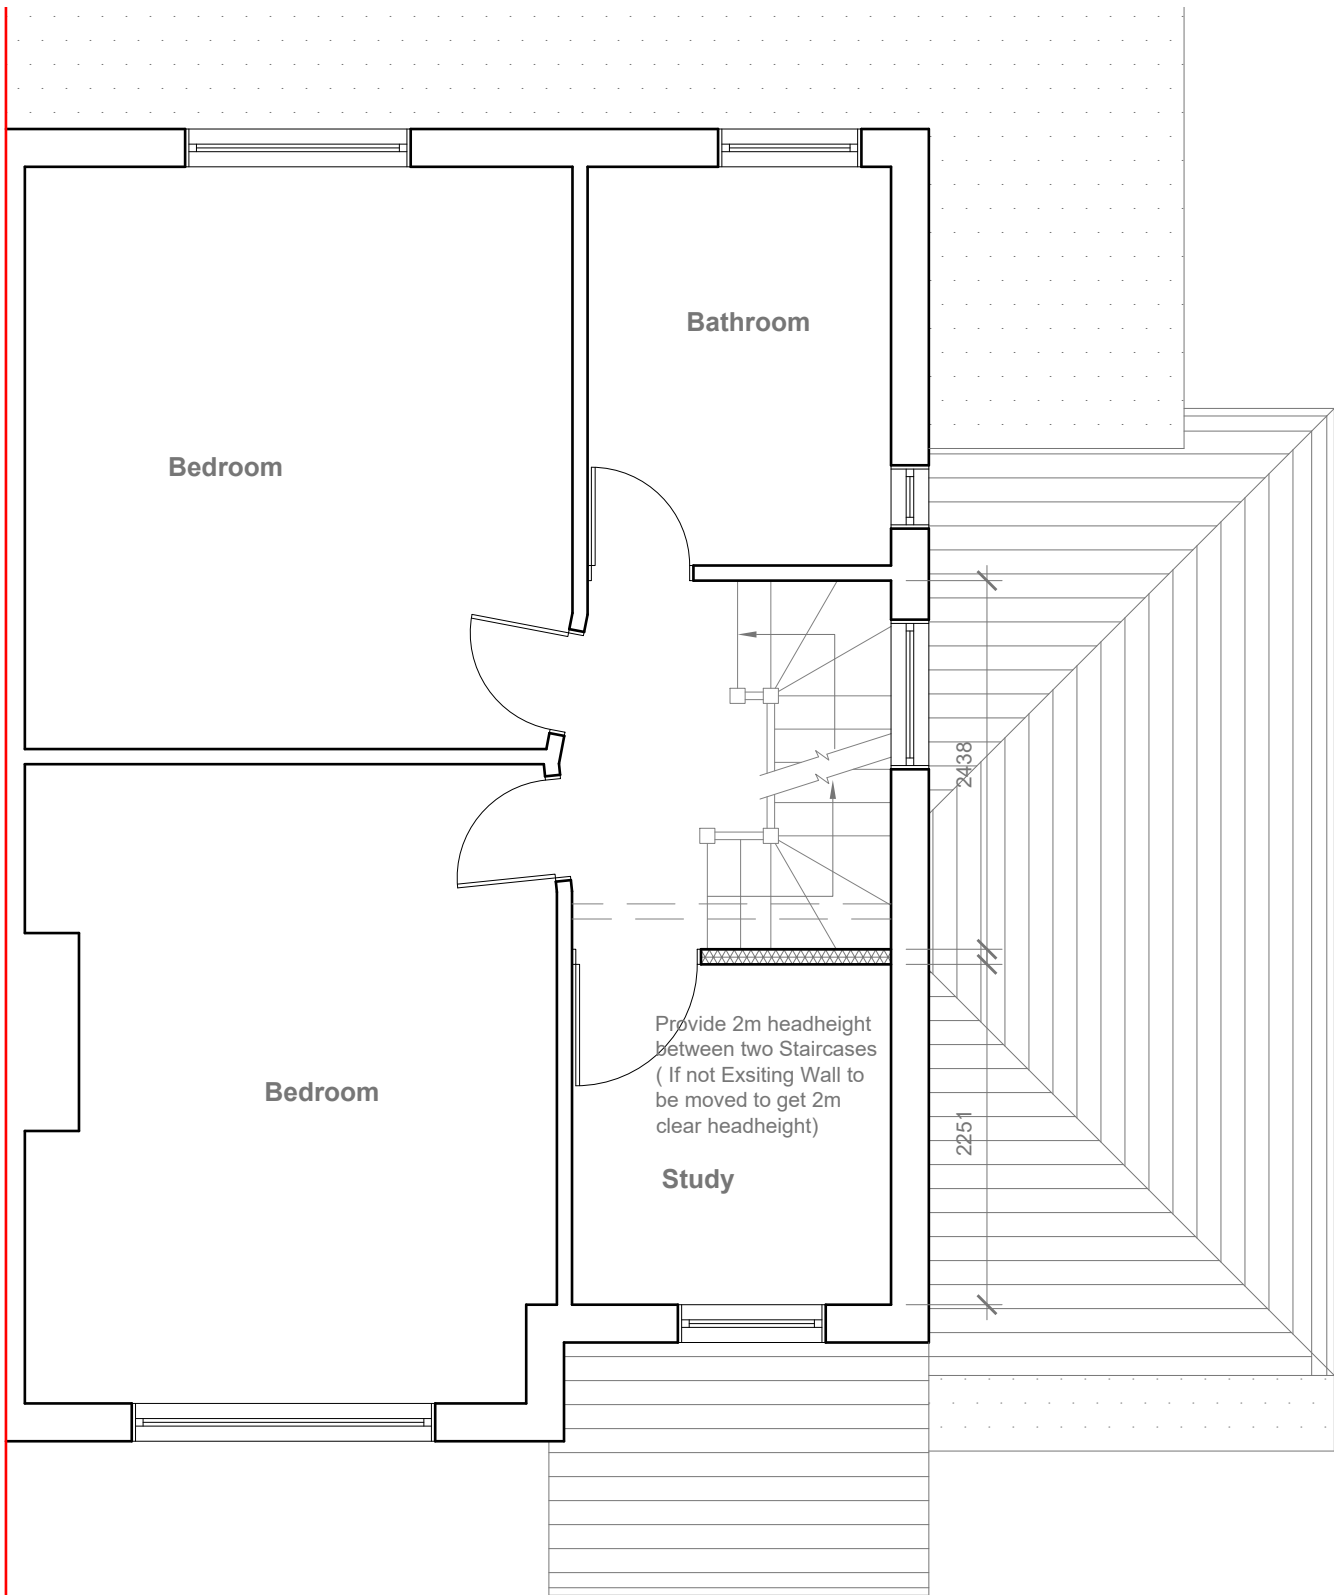

Proposed First Floor Plan
Scale 1:50

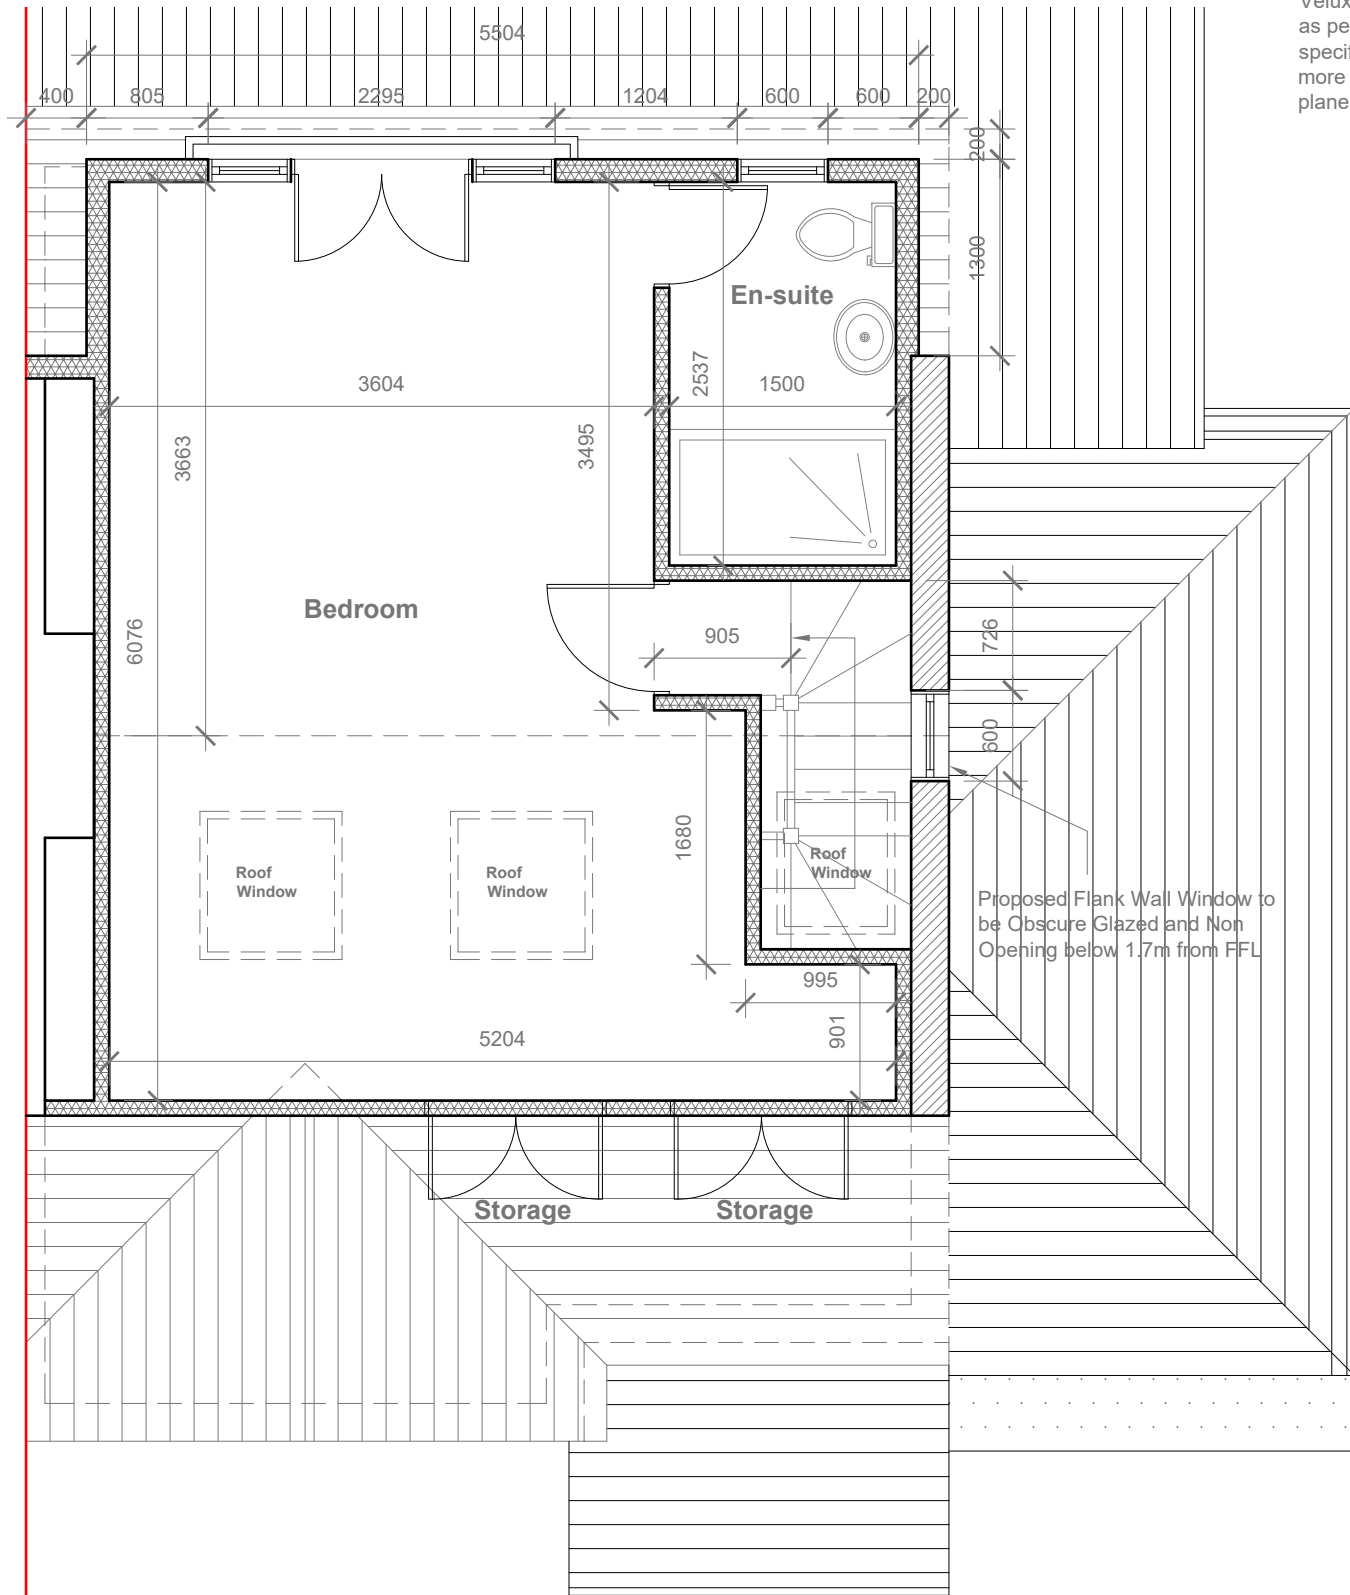

Proposed Loft Floor Plan
Scale 1:50



GENERAL NOTES:
1. ALL DIMENSIONS ARE IN MILLIMETER.
2. VERIFY ALL DIMENSIONS AND CONDITIONS BEFORE BUILDING OR STARTING CONSTRUCTION. NOTIFY THE DESIGNER IMMEDIATELY OF ANY DISCREPANCY OR VARIATION.
3. ALL WORK TO COMPLY WITH CURRENT BUILDING REGULATIONS AND CODES OF PRACTICE

Title:

Proposed First Floor & Loft Plans


Site Address
7 Vine Lane,
Uxbridge.
UB10 0AY

Scale: 1:50 @A3
Date: 18/04/2023
Drawing No.: 2023/058 -03
Drawn By: RO


Revision Date:
e:mail - faluckpatel@yahoo.com
(M) +44 (0) 7871 466 254



Proposed External Finish
Materials to Match Existing
External Finish Materials

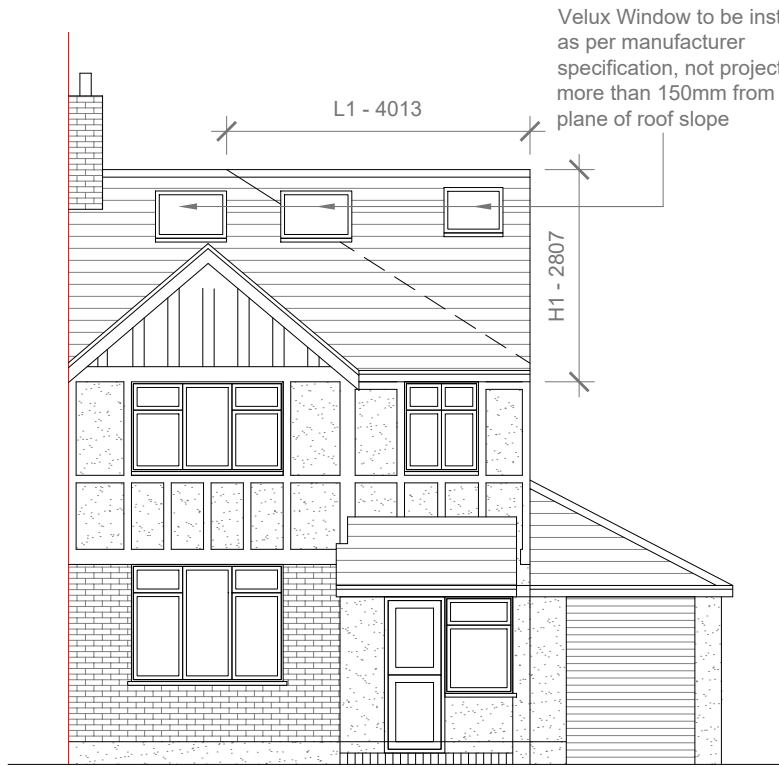

Proposed Front Elevation
Scale 1:100

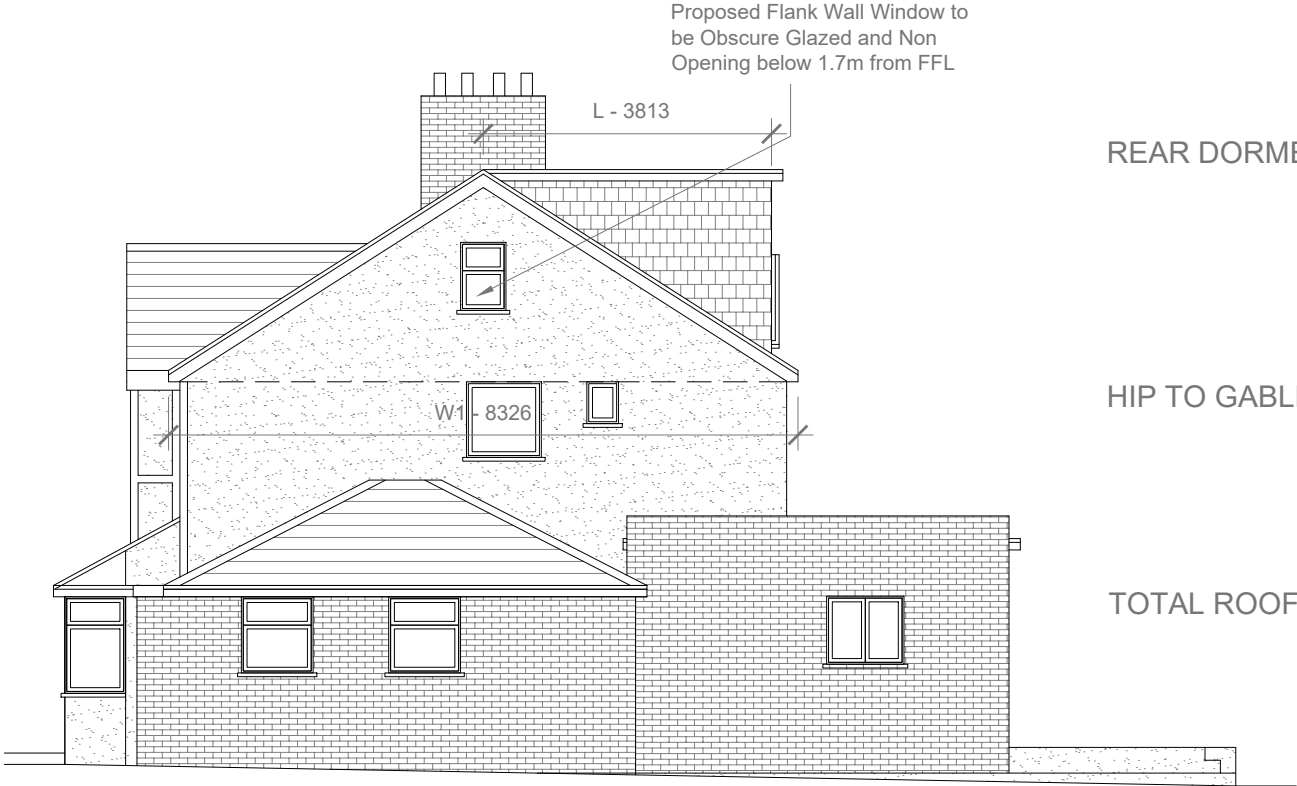

Proposed Side Elevation
Scale 1:100


REAR DORMER VOLUME = $W \times H \times L / 2$
 $5.504 \times 2.434 \times 3.813 / 2$
 $51.06 / 2$
 25.53 CU.MT.

HIP TO GABLE ROOF VOLUME = $W1 \times H1 \times L1 / 6$
 $8.326 \times 2.807 \times 4.013 / 6$
 $93.78 / 6$
 15.63 CU.MT.

TOTAL ROOF VOLUME = $V1 + V2$
 $25.53 + 15.63$
 $41.16 \text{ CU.MT.} < 50.00 \text{ CU.MT}$



Proposed Rear Elevation
Scale 1:100

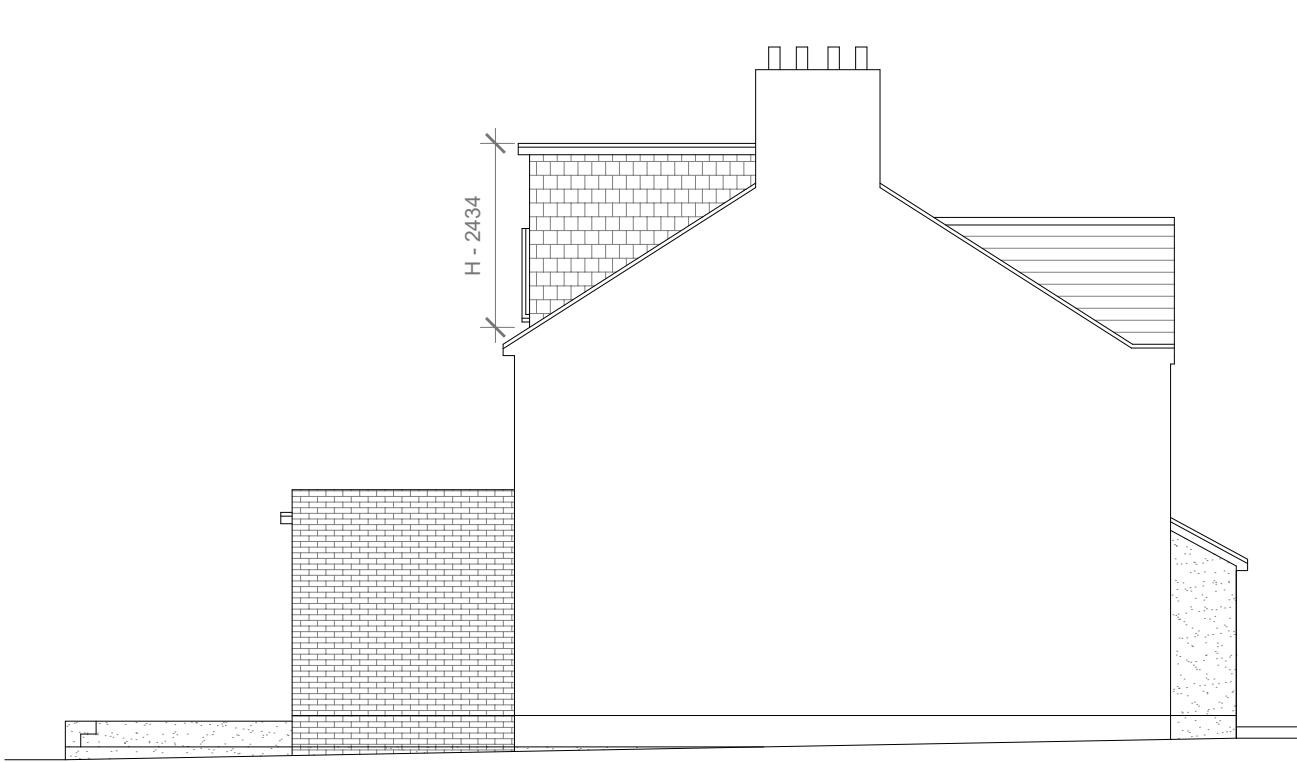

Proposed Side Elevation
Scale 1:100



GENERAL NOTES:
1. ALL DIMENSIONS ARE IN MILLIMETER.
2. VERIFY ALL DIMENSIONS AND CONDITIONS BEFORE BUILDING OR STARTING CONSTRUCTION. NOTIFY THE DESIGNER IMMEDIATELY OF ANY DISCREPANCY OR VARIATION.
3. ALL WORK TO COMPLY WITH CURRENT BUILDING REGULATIONS AND CODES OF PRACTICE

Title:

Proposed Elevations

Site Address
7 Vine Lane,
Uxbridge.
UB10 0AY

Scale: 1:100 @A3
Date: 18/04/2023
Drawing No.:
2023/058 -04
Drawn By:
RO

Revision Date:

e:mail -
faluckpatel@yahoo.com
(M) +44 (0) 7871 466 254

Faluck
Patel